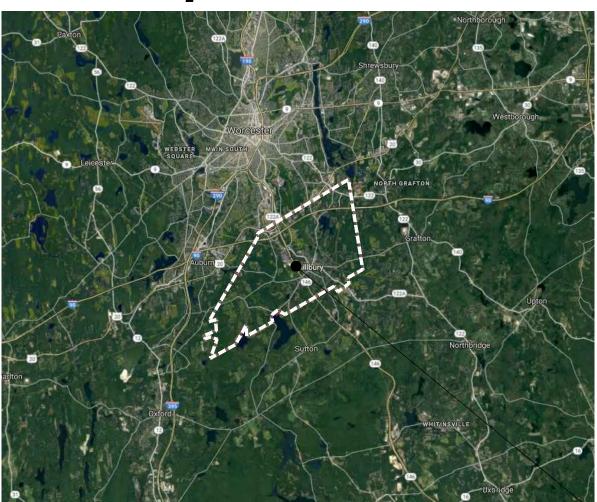
# TOWN OF MILLBURY


## IMPROVEMENTS TO MILLBURY DOWNTOWN


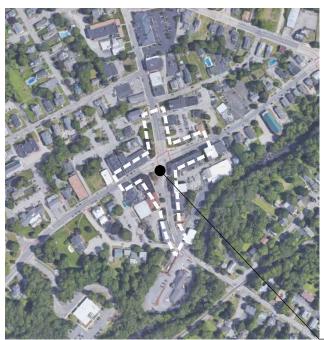
### Locus Map



PROJECT AREA



PROJECT SITE

MILLBURY DOWNTOWN
INTERSECTION OF ELM STREET
AND N. MAIN / S. MAIN STREETS

**JULY 2019** 

### Prepared By



427 Main Street, Suite 400, Worcester, MA 01608 (508) 762-1676 (800) Sampson www.westonandsampson.com

### 95% CONSTRUCTION DOCUMENTS NOT FOR CONSTRUCTION

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### **GENERAL NOTES**

- 1. PROPERTY LINES, SITE SURVEY AND TOPOGRAPHICAL INFORMATION BASED FROM A COMPILATION OF THE TOWN OF MILLBURY GIS, RECORD DRAWINGS AND ON THE GROUND SURVEYS PERFORMED BY WESTON & SAMPSON PE, LS, LA, PC. IN JULY 2018 AND OCTOBER 2018.
- CONTOURS AND ELEVATIONS SHOWN ON NAVD88 VERTICAL DATUM BASED ON GPS OBSERVATIONS.
- NORTH ORIENTATION IS TRUE NORTH BASED ON GPS OBSERVATIONS TAKEN AT THE TIME OF THE FIELD SURVEY. MAPPING PREPARED ON NADV83 STATE PLANE COORDINATE SYSTEM-MASSACHUSETTS MAINLAND ZONE.
- FOR DETAILED NOTES REGARDING TEST PITS AND BORINGS, REFER TO MEMO TITLED "GEOTECH LETTER REPORT" IN THE SPECIFICATIONS.
- 5. REFER TO GENERAL SYMBOLS FOR SURVEY LEGEND. ALL BIDDERS ARE REQUIRED TO INSPECT THE PROJECT SITE IN ITS ENTIRETY PRIOR TO SUBMITTING THEIR BID, AND BECOME FAMILIAR WITH ALL CONDITIONS AS THEY MAY AFFECT THEIR BID. CONTRACTOR AND SUB-CONTRACTOR SHALL BE FAMILIAR WITH ALL DRAWINGS AND SPECIFICATIONS PRIOR TO COMMENCING THE CONSTRUCTION.
- LOCATIONS OF ANY UTILITIES SHOWN ON THESE PLANS ARE APPROXIMATE ONLY. CONTRACTOR SHALL BE RESPONSIBLE FOR VERIFYING THE LOCATION OF SUCH UTILITIES, PROTECTING ALL EXISTING UTILITIES AND REPAIRING ANY DAMAGE DONE DURING CONSTRUCTION. THE CONTRACTOR SHALL BE RESPONSIBLE FOR ALL ON-SITE COORDINATION WITH UTILITY COMPANIES AND PUBLIC AGENCIES AND FOR OBTAINING ALL REQUIRED PERMITS AND PAYING ALL REQUIRED FEES. IN ACCORDANCE WITH M.G.L. CHAPTER 82, SECTION 40, INCLUDING AMENDMENTS, CONTRACTORS SHALL NOTIFY ALL UTILITY COMPANIES AND GOVERNMENT AGENCIES IN WRITING PRIOR TO EXCAVATION. CONTRACTOR SHALL ALSO CALL "DIG SAFE" AT (888) 344-7233 NO LESS THAN 72 HOURS, (EXCLUSIVE OF WEEKENDS AND HOLIDAYS), PRIOR TO SUCH EXCAVATION. DOCUMENTATION OF REQUESTS SHALL BE PROVIDED TO OWNER'S REPRESENTATIVE PRIOR TO EXCAVATION WORK.

- WHERE AN EXISTING UTILITY IS FOUND TO CONFLICT WITH THE PROPOSED WORK, THE LOCATION, ELEVATION AND SIZE OF THE UTILITY SHALL BE ACCURATELY DETERMINED WITHOUT DELAY BY THE CONTRACTOR AND THE INFORMATION FURNISHED TO THE OWNER'S REPRESENTATIVE FOR RESOLUTION OF THE CONFLICT.
- THE CONTRACTOR SHALL MAKE ALL ARRANGEMENTS FOR THE ALTERATION AND ADJUSTMENT OF GAS, ELECTRIC, TELEPHONE AND ANY OTHER PRIVATE UTILITIES BY THE UTILITY OWNER AT NO ADDITIONAL COST TO THE TOWN OF MILLBURY.
- CONTRACTOR SHALL BE RESPONSIBLE FOR REVIEWING ALL DRAWINGS AND SPECIFICATIONS TO DETERMINE THE EXTENT OF EXCAVATION AND DEMOLITION REQUIRED TO RECEIVE SITE IMPROVEMENTS.
- 10. ANY DISCREPANCIES OR CONFLICTS BETWEEN THE DRAWINGS AND EXISTING CONDITIONS, EXISTING CONDITIONS TO REMAIN, TEMPORARY CONSTRUCTION, PERMANENT CONSTRUCTION AND WORK OF ADJACENT CONTRACTS SHALL BE BROUGHT TO THE ATTENTION OF THE OWNER'S REPRESENTATIVE BEFORE PROCEEDING. ITEMS ENCOUNTERED IN AREAS OF EXCAVATION THAT ARE NOT INDICATED ON THE DRAWINGS, BUT ARE VISIBLE ON SURFACE, SHALL BE THE CONTRACTOR'S RESPONSIBILITY AND SHALL BE REMOVED AT NO ADDITIONAL COST TO THE OWNER.
- 11. ANY ALTERATIONS TO THESE DRAWINGS MADE IN THE FIELD DURING CONSTRUCTION SHALL BE RECORDED BY THE GENERAL CONTRACTOR ON "AS BUILT" DRAWINGS.
- 12. ALL AREAS DISTURBED BY THE CONTRACTOR'S OPERATIONS OUTSIDE THE PROJECT LIMITS, SHALL BE RESTORED TO THE ORIGINAL CONDITION BY THE CONTRACTOR AT NO ADDITIONAL COST AND TO THE SATISFACTION OF THE OWNER.
- 13. ALL WORK SHOWN ON THE PLANS AS BOLD SHALL REPRESENT PROPOSED WORK. THE TERM "PROPOSED (PROP)" INDICATES WORK TO BE CONSTRUCTED USING NEW MATERIALS OR, WHERE APPLICABLE, RE-USING EXISTING MATERIALS IDENTIFIED AS "REMOVE AND RESET (R&R)" OR "REMOVE AND SALVAGE (R&S).
- 14. ALL KNOWN EXISTING STATE, COUNTY AND TOWN LOCATION LINES AND PRIVATE PROPERTY LINES HAVE BEEN ESTABLISHED FROM AVAILABLE

- INFORMATION AND ARE INDICATED ON THE PLANS.
- THE CONTRACTOR SHALL TAKE ALL NECESSARY PRECAUTIONS TO PROTECT HIS EMPLOYEES, AS WELL AS PUBLIC USERS FROM INJURY DURING THE ENTIRE CONSTRUCTION PERIOD USING ALL NECESSARY SAFEGUARDS, INCLUDING BUT NOT LIMITED TO, THE ERECTION OF TEMPORARY WALKS, STRUCTURES, PROTECTIVE BARRIERS, COVERING, OR FENCES AS NEEDED.
- 16. THE CONTRACTOR SHALL SUPPLY THE OWNER WITH THE NAME OF THE OSHA "COMPETENT PERSON" PRIOR TO CONSTRUCTION.
- 17. FILLING OF EXCAVATED AREAS SHALL NOT TAKE PLACE WITHOUT THE PRESENCE OR PERMISSION OF THE OWNER.
- 18. EXISTING TREES TO REMAIN SHALL BE PROTECTED FROM CONSTRUCTION ACTIVITIES. NO STOCKPILING OF MATERIAL, EQUIPMENT OR VEHICULAR TRAFFIC SHALL BE ALLOWED WITHIN THE DRIP LINE OF TREES TO REMAIN NO GUYS SHALL BE ATTACHED TO ANY TREE TO REMAIN. WHEN NECESSARY OR AS DIRECTED BY THE OWNER'S REPRESENTATIVE, THE CONTRACTOR SHALL ERECT TEMPORARY BARRIERS FOR THE PROTECTION OF EXISTING TREES DURING CONSTRUCTION.
- 19. TREES AND SHRUBS WITHIN THE LIMITS OF WORK SHALL BE REMOVED ONLY UPON THE APPROVAL OF THE OWNER'S REPRESENTATIVE OR AS NOTED ON THE PLANS.
- 20. NO FILLING SHALL OCCUR AROUND EXISTING TREES TO REMAIN WITHOUT THE APPROVAL OF THE OWNER OR OWNER REPRESENTATIVE.
- THE CONTRACTOR SHALL REMOVE ALL SURFACE VEGETATION PRIOR TO GRADING THE SITE. TREES AND STUMPS SHALL BE REMOVED AND DISPOSED COMPLETE BY CONTRACTOR, TEMPORARY EROSION CONTROL MEASURES SHOWN ON THE DRAWINGS (INCLUDING SILT FENCE, STRAW WATTLES, OR SILT SOCKS) SHALL BE INSTALLED BY THE CONTRACTOR. THE CONTRACTOR SHALL BE RESPONSIBLE FOR MAINTAINING THESE TEMPORARY EROSION CONTROL MEASURES THROUGHOUT THE PROJECT WHICH COST SHALL BE INCIDENTAL TO THE PROJECT.
- ALL UNSUITABLE UNCONTAMINATED EXCESS SOIL FROM CONSTRUCTION ACTIVITIES SHALL BE DISPOSED OF BY THE CONTRACTOR AT NO

- ADDITIONAL COST TO THE TOWN. REMOVAL ACTIVITIES SHALL BE ACCORDANCE WITH STATE AND LOCAL REGULATIONS AT NO ADDITIONAL COST TO THE TOWN. SUITABLE SOIL EXCAVATION AS PART OF THE PROJECT MUST MEET ONE OR MORE OF THE MATERIAL REQUIREMENTS SPECIFIED IN XXX-EARTHWORK. IF THE CONTRACTOR PROPOSES TO USE THE EXISTING FILL ON SITE BELOW PAVEMENT AREAS, HE MUST DEMONSTRATE THAT THE FILL MEETS THE REQUIREMENTS PER THE SPECIFICATIONS. ALL EXCAVATED FILL MATERIAL WHICH DOES NOT MEET THE REQUIREMENTS OF THE CONTRACT DOCUMENTS SHALL BE REMOVED 31. AND DISPOSED OF OFF-SITE AT NO ADDITIONAL COST.
- 23. CONTRACTOR IS RESPONSIBLE FOR STAKING CONSTRUCTION BASELINES IN FIELD WITH A MA. REGISTERED PROFESSIONAL LAND SURVEYOR. NO CONSTRUCTION WILL BE PERFORMED WITHOUT THE PROPOSED BASELINES AND LAYOUTS APPROVED BY THE ENGINEER.
- 24. NO FILL SHALL CONTAIN HAZARDOUS MATERIALS
- 25. CONTRACTOR SHALL PROVIDE TEMPORARY CONSTRUCTION FENCING AROUND PERIMETER OF WORK AREA (LIMIT OF WORK). FENCE SHALL NOT IMPEDE TRAVEL WAYS.
- 26. ANY QUANTITIES SHOWN ON PLANS ARE FOR COMPARATIVE BIDDING PURPOSES ONLY. IT IS THE CONTRACTOR'S RESPONSIBILITY TO VISIT THE 35. PROJECT SITE TO VERIFY ALL QUANTITIES AND CONDITIONS PRIOR TO SUBMITTING BID.
- ALL EXISTING DRAINAGE FACILITIES TO REMAIN SHALL BE MAINTAINED FREE OF DEBRIS, SOIL, SEDIMENT, AND FOREIGN MATERIAL AND OPERATIONAL THROUGHOUT THE LIFE OF THE CONTRACT. REMOVE ALL SOIL. SEDIMENT. DEBRIS AND FOREIGN MATERIAL FROM ALL DRAINAGE STRUCTURES, INCLUDING BUT NOT LIMITED TO, DRAINAGE INLETS, MANHOLES AND CATCH BASINS WITHIN THE LIMIT OF WORK AND DRAINAGE STRUCTURES OUTSIDE THE LIMIT OF WORK THAT ARE IMPACTED BY THE WORK FOR THE ENTIRE DURATION OF CONSTRUCTION.
- CONTRACTOR'S STAGING AREA MUST BE WITHIN THE CONTRACT LIMIT LINE AND IN AREAS APPROVED BY OWNER. ANY OTHER AREAS THAT THE CONTRACTOR MAY WISH TO USE FOR STAGING MUST BE COORDINATED WITH THE OWNER.

- 29. THE CONTRACTOR SHALL KEEP ALL STREETS, PARKING LOTS AND WALKS THAT ARE NOT RESTRICTED FROM PUBLIC USE DURING CONSTRUCTION METHODS AND MATERIALS TO MAINTAIN ADEQUATE DUST CONTROL THROUGHOUT CONSTRUCTION.
- CONTRACTOR SHALL COORDINATE ALL WORK WITH THE OWNER.
- THE CONTRACTOR SHALL PROVIDE SAFE ACCESS TO OPEN BUSINESSES AT ALL TIMES. ANY WORK THAT RESTRICTS ACCESS TO BUSINESSES SHALL E COORDINATED WITH THE OWNER.
- 32. THE LIMIT OF WORK SHALL BE DELINEATED IN THE FIELD PRIOR TO THE START OF SITE CLEARING OR CONSTRUCTION AND AGREED UPON WITH THE OWNER'S REPRESENTATIVE.
- 33. DEEP SUMP CATCH BASINS AND STORMWATER BASINS SHALL BE CLEANED FOLLOWING CONSTRUCTION AND SHALL FOLLOW THE OPERATION AND MAINTENANCE PLAN THEREAFTER.
- 34. HAULING OF EARTH MATERIALS TO AND FROM THE SITE SHALL BE RESTRICTED TO THE HOURS OF 7 AM TO 5 PM.
- ANY BOULDERS 3 CY OR SMALLER SHALL BE CONSIDERED UNDOCUMENTED FILL AND SHALL BE DISPOSED OF AT NO ADDITIONAL COST TO THE TOWN.
  - 36. WORK ON WEEKENDS SHALL ONLY BE CONDUCTED IF PRIOR WRITTEN PERMISSION IS PROVIDED BY THE TOWN.
- NO TRUCKS LEFT IDLING ON TOWN STREETS DURING CONSTRUCTION. CONSTRUCTION TRAFFIC AT NO TIME SHALL IMPEDE FLOW OF RESIDENT TRAFFIC.

# BROOM CLEAN AT ALL TIMES. THE CONTRACTOR SHALL USE ACCEPTABLE

TOWN OF MILLBURY, MA

REDEVELOPMENT MILLBURY, MA

DOWNTOWN

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Consultants:

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Date: 7-12-2019 Drawn By: DMP

Reviewed By: MSM

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**GENERAL NOTES** 

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### **DEMOLITION & SITE PREPARATION NOTES**

- 1. THE CONTRACTOR SHALL INCLUDE IN THE BID THE COST OF REMOVING ANY EXISTING SITE FEATURES AND APPURTENANCES NECESSARY TO ACCOMPLISH THE CONSTRUCTION OF THE PROPOSED SITE IMPROVEMENTS. THE CONTRACTOR SHALL ALSO INCLUDE IN THE BID THE COST NECESSARY TO RESTORE SUCH ITEMS IF THEY ARE SCHEDULED TO REMAIN AS PART OF THE FINAL SITE IMPROVEMENTS. REFER TO PLANS TO DETERMINE EXCAVATION AND DEMOLITION REQUIREMENTS AND TO DETERMINE THE LOCATION OF THE PROPOSED SITE IMPROVEMENTS.
- 2. THE OWNER RESERVES THE RIGHT TO REVIEW ALL MATERIALS DESIGNATED FOR REMOVAL AND TO RETAIN OWNERSHIP OF SUCH MATERIALS. IF THE OWNER RETAINS ANY MATERIAL THE CONTRACTOR SHALL MAKE ARRANGEMENTS WITH THE OWNER TO HAVE THOSE MATERIALS REMOVED OFF SITE TO A DESIGNATED MUNICIPAL PROPERTY AT NO ADDITIONAL COST. ALL GEOTECHNICALLY OR UNSUITABLE UNCONTAMINATED EXCESS SOIL FROM CONSTRUCTION ACTIVITIES SHALL BE DISPOSED OF BY THE CONTRACTOR AT NO ADDITIONAL COST TO THE TOWN. REMOVAL ACTIVITIES SHALL BE ACCORDANCE WITH STATE AND LOCAL REGULATIONS AT NO ADDITIONAL COST TO THE TOWN.
- 3. UNLESS SPECIFICALLY NOTED TO BE REMOVED AND STOCKPILED (R&S) OR REUSED AND RELOCATED (R&R), ALL SITE FEATURES CALLED TO BE REMOVED AND DEMOLISHED (R&D) SHALL BE REMOVED WITH THEIR FOOTINGS. ATTACHMENTS, BASE MATERIAL, ETC. TRANSPORTED FROM THE SITE TO BE DISPOSED OF IN A LAWFUL MANNER AT AN ACCEPTABLE DISPOSAL SITE AND AT NO ADDITIONAL COST TO THE OWNER.
- 4. ALL EXISTING SITE FEATURES TO REMAIN SHALL BE PROTECTED THROUGHOUT THE CONSTRUCTION PERIOD. ANY FEATURES DAMAGED DURING CONSTRUCTION OPERATIONS SHALL BE REPAIRED OR REPLACED TO THE SATISFACTION OF THE OWNER AND/OR OWNER'S REPRESENTATIVE AT NO ADDITIONAL COST.
- 5. DURING EARTHWORK OPERATIONS, CONTRACTOR SHALL TAKE CARE TO NOT DISTURB EXISTING MATERIALS TO REMAIN. OUTSIDE THE LIMITS OF EXCAVATION AND BACKFILL AND SHALL TAKE WHATEVER MEASURES NECESSARY, AT THE CONTRACTOR'S EXPENSE. TO PREVENT ANY EXCAVATED MATERIAL FROM COLLAPSING. ALL BACKFILL MATERIALS SHALL BE PLACED AND COMPACTED AS SPECIFIED TO THE SUBGRADE REQUIRED FOR THE INSTALLATION OF THE REMAINDER OF THE CONTRACT WORK.
- 6. IT SHALL BE THE CONTRACTOR'S OPTION, WITH CONCURRENCE OF THE OWNER'S REPRESENTATIVE, TO REUSE EXISTING BITUMINOUS CONCRETE PAVEMENT BASE COURSE AND/ OR SUBBASE GRAVEL MATERIALS IF IT MEETS THE REQUIREMENTS OF THE SPECIFICATIONS FOR DENSE GRADED CRUSHED
- 7. STRIP & STOCKPILE EXISTING TOPSOIL FOR LATER REUSE AS REQUIRED. STOCKPILE SHALL HAVE APPROPRIATE EROSION AND SEDIMENT CONTROLS. THE CONTRACTOR SHALL CONFIRM THAT THE TOPSOIL IS SUITABLE FOR REUSE AND IT MEETS THE REQUIREMENTS OF THE SPECIFICATIONS FOR TOPSOIL LOAM
- 8. CLEAR AND GRUB VEGETATION SHALL INCLUDE REMOVAL OF ALL GRASS/LAWN, SHRUBS, AND UNDERBRUSH, REMOVAL OF ROOTS, ROUGH GRADING.
- 9. INSTALLATION OF LOAM (IF APPLICABLE), FINE GRADING, SEEDING AND TURF OR VEGETATION ESTABLISHMENT BY THE CONTRACTOR.
- 10. THE CONTRACTOR SHALL PROTECT EXISTING TREES TO REMAIN. CONTRACTOR SHALL INSTALL TREE PROTECTION BARRIERS AFTER CLEARING TURF AND UNDERBRUSH BY HAND AND TAKE DUE CARE TO PREVENT INJURY TO TREES DURING CLEARING OPERATIONS.
- 11. THE STORAGE OF MATERIALS AND EQUIPMENT WILL BE PERMITTED AT LOCATIONS DESIGNATED BY OWNER OR OWNER'S REPRESENTATIVE. PROTECTION OF STORED MATERIALS AND EQUIPMENT SHALL BE THE SOLE RESPONSIBILITY OF THE CONTRACTOR.
- 12. REFER TO SHEET E1.00 FOR ALL ELECTRICAL DEMOLITION REFERENCES NOT NOTED IN SHEETS L2.00-L2.07. IF ANY NOTES ARE CONFLICTING, E1.00 NOTES WILL TAKE PRECEDENCE.

### **EROSION AND SEDIMENT CONTROL NOTES**

- 1. ALL SEDIMENT AND EROSION CONTROL DEVICES SHALL BE PUT INTO PLACE PRIOR TO BEGINNING ANY CONSTRUCTION OR DEMOLITION. REFER TO PLANS FOR APPROXIMATE LOCATION OF EROSION AND SEDIMENT CONTROL. REFER TO SPECS AND DETAILS FOR TYPE OF EROSION AND SEDIMENT CONTROL.
- THE CONTRACTOR SHALL BE RESPONSIBLE FOR THE CONTINUAL MAINTENANCE OF ALL CONTROL DEVICES THROUGHOUT THE DURATION OF THE PROJECT.
- 3. CONTRACTOR SHALL MEET ALL OF THE STATE OF MASSACHUSETTS AND THE TOWN OF MILLBURY WETLAND ORDINANCE REGULATIONS FOR SEDIMENT AND EROSION CONTROL.
- EXCAVATED MATERIAL STOCKPILED ON THE SITE SHALL BE SURROUNDED BY A RING OF UNBROKEN SEDIMENT AND EROSION CONTROL FENCE. THE LIMITS OF ALL GRADING AND DISTURBANCE SHALL BE KEPT TO A MINIMUM WITHIN THE APPROVED AREA OF CONSTRUCTION. ALL AREAS OUTSIDE OF THE LIMIT OF CONTRACT SHALL REMAIN TOTALLY UNDISTURBED UNLESS OTHERWISE APPROVED BY OWNER'S REPRESENTATIVE.
- ALL CATCH BASINS AND DRAIN GRATES WITHIN THE LIMIT OF WORK SHALL BE PROTECTED WITH SILT SACKS DURING THE ENTIRE DURATION OF CONSTRUCTION.
- EROSION CONTROL BARRIERS TO BE INSTALLED AT THE TOE OF SLOPES. SEE GRADING & DRAINAGE PLANS, NOTES, DETAILS AND SPECIFICATIONS.
- THE CONTRACTOR SHALL PROVIDE DUST CONTROL FOR CONSTRUCTION OPERATIONS AS APPROVED BY THE OWNER'S REPRESENTATIVE AND MASSACHUSETTS D.E.P. REQUIREMENTS.
- ALL POINTS OF CONSTRUCTION EGRESS OR INGRESS SHALL BE MAINTAINED TO PREVENT TRACKING OR FLOWING OF SEDIMENT ON TO PUBLIC/PRIVATE ROADS.
- ALL MATERIAL HAULING VEHICLES SHALL BE COMPLETELY COVERED PRIOR TO LEAVING THE SITE.
- 10. CONTRACTOR SHALL BE RESPONSIBLE FOR WHEEL CLEANING OF ALL CONSTRUCTION VEHICLES PRIOR TO EXITING THE SITE. CONTRACTOR SHALL ENSURE THAT MATERIAL HAULING VEHICLES REMAIN ON PAVED SURFACES AS

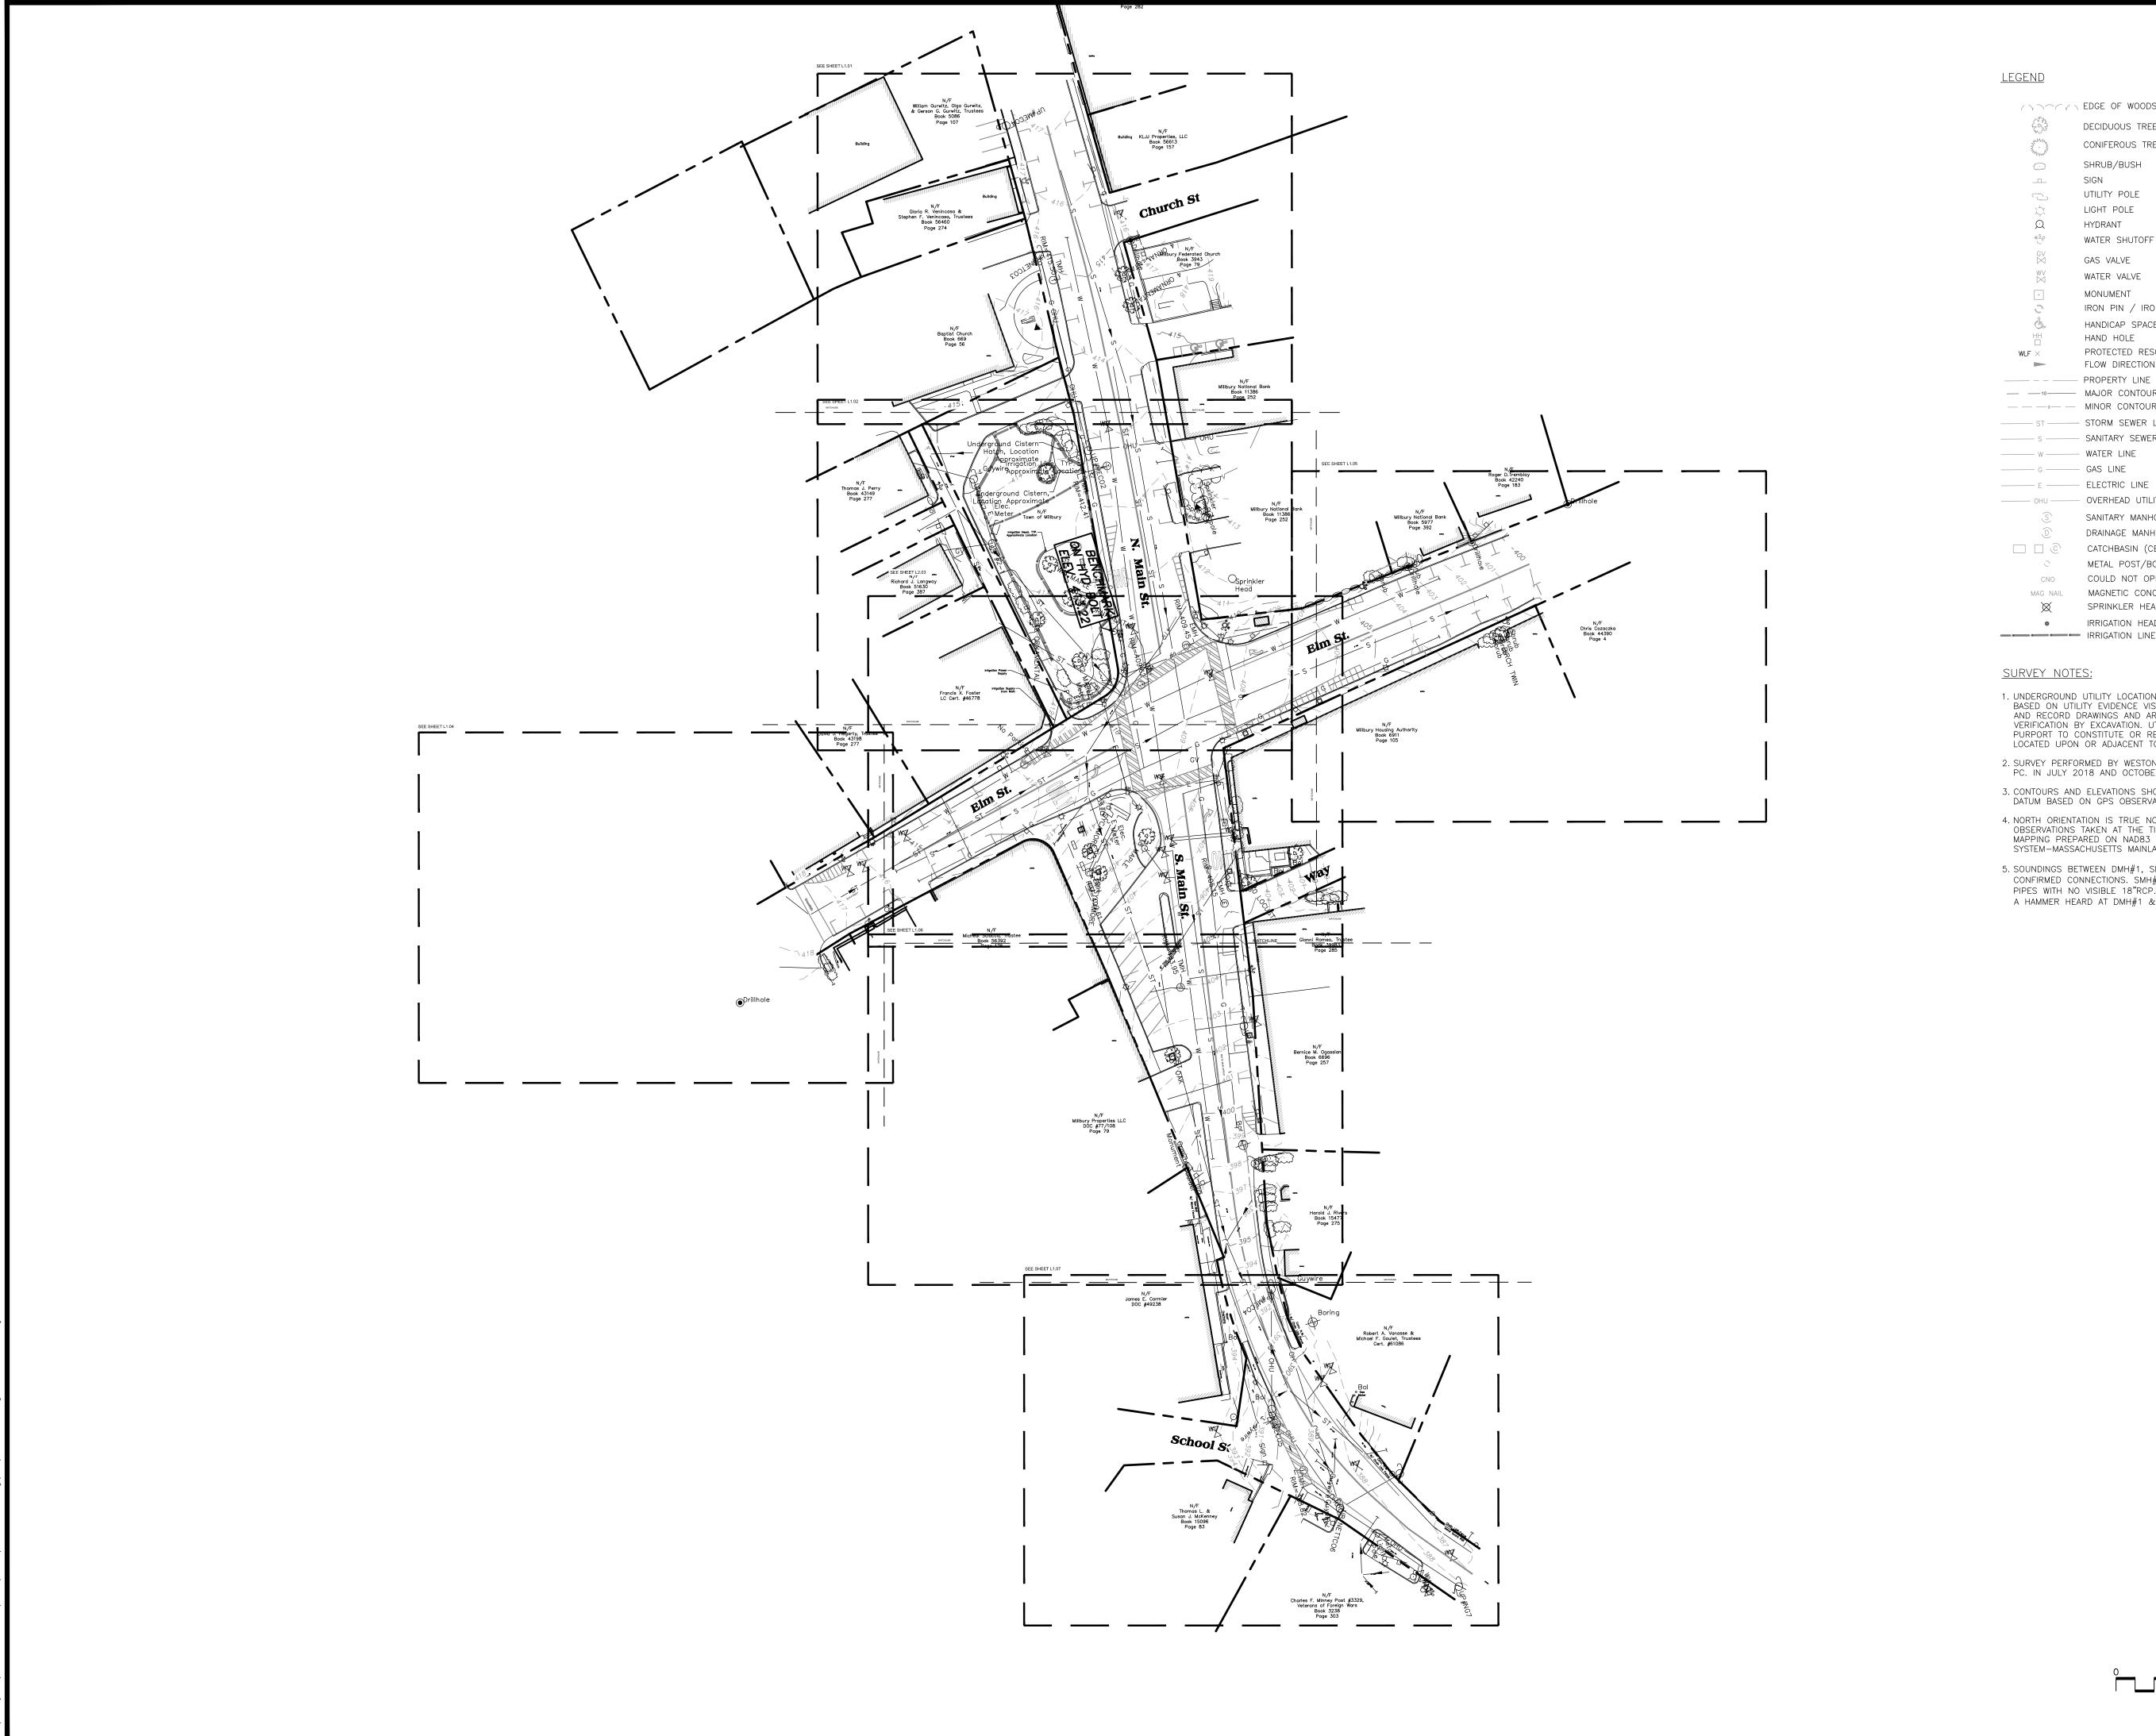
MUCH AS POSSIBLE

### LAYOUT NOTES

- 1. COORDINATE ALL LAYOUT ACTIVITIES WITH THE SCOPE OF WORK CALLED FOR BY DEMOLITION, GRADING AND UTILITIES OPERATIONS ENCOMPASSED BY THIS CONTRACT. SET, PROTECT AND REPLACE REFERENCE STAKES AS NECESSARY OR AS REQUIRED BY THE OWNER'S REPRESENTATIVE.
- 2. ALL WORK SHALL BE PERFORMED BY CONTRACTOR UNLESS SPECIFICALLY INDICATED THAT THE WORK WILL BE PERFORMED "BY OWNER".
- 3. THE LAYOUT OF SITE AMENITIES AND FENCES MUST BE APPROVED BY THE OWNER'S REPRESENTATIVE PRIOR TO INSTALLATION.
- 4. ALL PROPOSED SITE FEATURES SHALL BE LAID OUT AND STAKED FOR REVIEW AND APPROVAL BY THE OWNER'S REPRESENTATIVE PRIOR TO COMMENCEMENT OF INSTALLATION. ANY REQUIRED ADJUSTMENTS TO THE LAYOUT SHALL BE UNDERTAKEN AS DIRECTED, AT NO ADDITIONAL COST TO THE OWNER.
- 5. ALL PROPOSED PAVEMENTS SHALL MEET THE LINE AND GRADE OF EXISTING ADJACENT PAVEMENT SURFACES AND SHALL BE TREATED WITH AN RS-1 TACK COAT AT POINT OF CONNECTION. ALL PATHWAY WIDTHS SHALL BE AS NOTED ON THE LAYOUT AND MATERIALS PLAN.
- 6. THE CONTRACTOR SHALL VERIFY ALL DIMENSIONS AND GRADES ON THE GROUND AND REPORT ANY DISCREPANCIES IMMEDIATELY TO THE OWNER.
- 7. THE CONTRACTOR SHALL BE RESPONSIBLE FOR FIELD MEASUREMENTS OF ALL PROPOSED FENCES, GATES.

### **GRADING & DRAINAGE NOTES**

- ALL WORK RELATING TO INSTALLATION, RENOVATION OR MODIFICATION OF DRAINAGE SERVICES SHALL BE PERFORMED IN ACCORDANCE WITH THE STANDARDS OF THE TOWN OF MILLBURY AND ITS DEPARTMENT OF PUBLIC WORKS.
- 2. THE CONTRACTOR SHALL VERIFY ALL DIMENSIONS, GRADES AND INVERT ELEVATIONS IN THE FIELD AND REPORT ANY DISCREPANCIES IMMEDIATELY TO THE OWNER AND OWNER'S REPRESENTATIVE.
- 3. ALL NEW WALKWAYS MUST CONFORM TO CURRENT AMERICANS WITH DISABILITIES ACT (ADA) REGULATIONS: WALKWAYS SHALL MAINTAIN A CROSS PITCH OF NOT MORE THAN ONE AND A HALF (1.5%) PERCENT MAXIMUM AND THE RUNNING SLOPE (PARALLEL TO THE DIRECTION OF TRAVEL) OF 4.5%
- 4. MINIMUM SLOPE ON ALL WALKWAYS WILL BE 1:100 OR 1% TO PROVIDE POSITIVE DRAINAGE. ANY DISCREPANCIES NOT ALLOWING THIS TO OCCUR SHALL BE REPORTED TO THE OWNER'S REPRESENTATIVE PRIOR TO CONTINUING WORK.
- 5. ALL UTILITY GRATES, COVERS OR OTHER SURFACE ELEMENTS INTENDED TO BE EXPOSED AT GRADE SHALL BE FLUSH WITH THE ADJACENT FINISHED GRADE AND ADJUSTED TO PROVIDE A SMOOTH TRANSITION AT ALL EDGES. REGARDLESS OF WHETHER THEY ARE INDICATED AS ADJ. ON THE PLANS.
- 6. THE CONTRACTOR SHALL SET SUBGRADE ELEVATIONS TO ALLOW FOR POSITIVE DRAINAGE AND PROVIDE EROSION CONTROL DEVICES, STRUCTURES, MATERIALS AND CONSTRUCTION METHODS TO DIRECT SILT MIGRATION AWAY FROM DRAINAGE AND OTHER UTILITY SYSTEMS, PUBLIC/ PRIVATE STREETS AND WORK AREAS. CLEAN BASINS REGULARLY AND AT THE END OF THE PROJECT.
- CONTRACTOR SHALL ENSURE ALL AREAS ARE PROPERLY PITCHED TO DRAIN, WITH NO SURFACE WATER PONDING OR PUDDLING.
- 8. EXCAVATION REQUIRED WITHIN PROXIMITY OF KNOWN EXISTING UTILITY LINES SHALL BE DONE BY HAND. CONTRACTOR SHALL REPAIR ANY DAMAGE TO EXISTING UTILITY LINES OR STRUCTURES INCURRED DURING CONSTRUCTION OPERATIONS AT NO COST TO THE OWNER.
- WHERE NEW EARTHWORK MEETS EXISTING EARTHWORK, CONTRACTOR SHALL BLEND NEW EARTHWORK SMOOTHLY INTO EXISTING, PROVIDING VERTICAL CURVES OR POUNDS AT ALL TOP AND BOTTOM OF SLOPES.
- 10. WHERE A SPECIFIC LIMIT OF WORK LINE IS NOT OBVIOUS OR IMPLIED, BLEND GRADES TO EXISTING CONDITIONS WITHIN 5 FEET OF PROPOSED CONTOURS.
- 11. RESTORE ALL DISTURBED AREAS AND LIMITS OF ALL REMOVALS TO LOAM AND SEED UNLESS OTHERWISE
- 12. WHERE NEW IMPROVEMENTS MEET EXISTING CONDITIONS, MEET LINE AND GRADE OF EXISTING ADJACENT PAVEMENTS, TYPICAL



( ) \ C ( ) EDGE OF WOODS DECIDUOUS TREE CONIFEROUS TREE SHRUB/BUSH SIGN UTILITY POLE LIGHT POLE HYDRANT WATER SHUTOFF GAS VALVE WATER VALVE MONUMENT

IRON PIN / IRON ROD HANDICAP SPACE HAND HOLE PROTECTED RESOURCE AREA FLOW DIRECTION

- PROPERTY LINE --- MAJOR CONTOUR LINE — — — • — MINOR CONTOUR LINE ------ ST ------ STORM SEWER LINE ----- w ----- WATER LINE ---- G ---- GAS LINE

----- OHU ----- OVERHEAD UTILITIES SANITARY MANHOLE (SMH) DRAINAGE MANHOLE (DMH) ☐ ☐ ⓒ CATCHBASIN (CB) METAL POST/BOLLARD (BOL)

COULD NOT OPEN MAG NAIL MAGNETIC CONCRETE NAIL SPRINKLER HEAD

 IRRIGATION HEAD (APPROXIMATE LOCATION) 

- 1. UNDERGROUND UTILITY LOCATIONS SHOWN HEREON ARE BASED ON UTILITY EVIDENCE VISIBLE AT GROUND SURFACE AND RECORD DRAWINGS AND ARE SUBJECT TO FIELD VERIFICATION BY EXCAVATION. UTILITIES SHOWN DO NOT PURPORT TO CONSTITUTE OR REPRESENT ALL UTILITIES LOCATED UPON OR ADJACENT TO THE SURVEYED PREMISES.
- 2. SURVEY PERFORMED BY WESTON & SAMPSON PE, LS, LA, PC. IN JULY 2018 AND OCTOBER 2018.
- 3. CONTOURS AND ELEVATIONS SHOWN ON NAVD88 VERTICAL DATUM BASED ON GPS OBSERVATIONS.
- 4. NORTH ORIENTATION IS TRUE NORTH BASED ON GPS OBSERVATIONS TAKEN AT THE TIME OF THE FIELD SURVEY. MAPPING PREPARED ON NAD83 STATE PLANE COORDINATE SYSTEM-MASSACHUSETTS MAINLAND ZONE.
- 5. SOUNDINGS BETWEEN DMH#1, SMH#3, AND DMH#2 CONFIRMED CONNECTIONS. SMH#3(DRY) HAS 8" CLAY PIPES WITH NO VISIBLE 18"RCP. HOWEVER, SOUNDING WITH A HAMMER HEARD AT DMH#1 & DMH#2.

TOWN OF MILLBURY, MA



DOWNTOWN REDEVELOPMENT MILLBURY, MA

427 Main Street, Suite 400, Worcester, MA 01608 508.762.1676 800.SAMPSON www.westonandsampson.com

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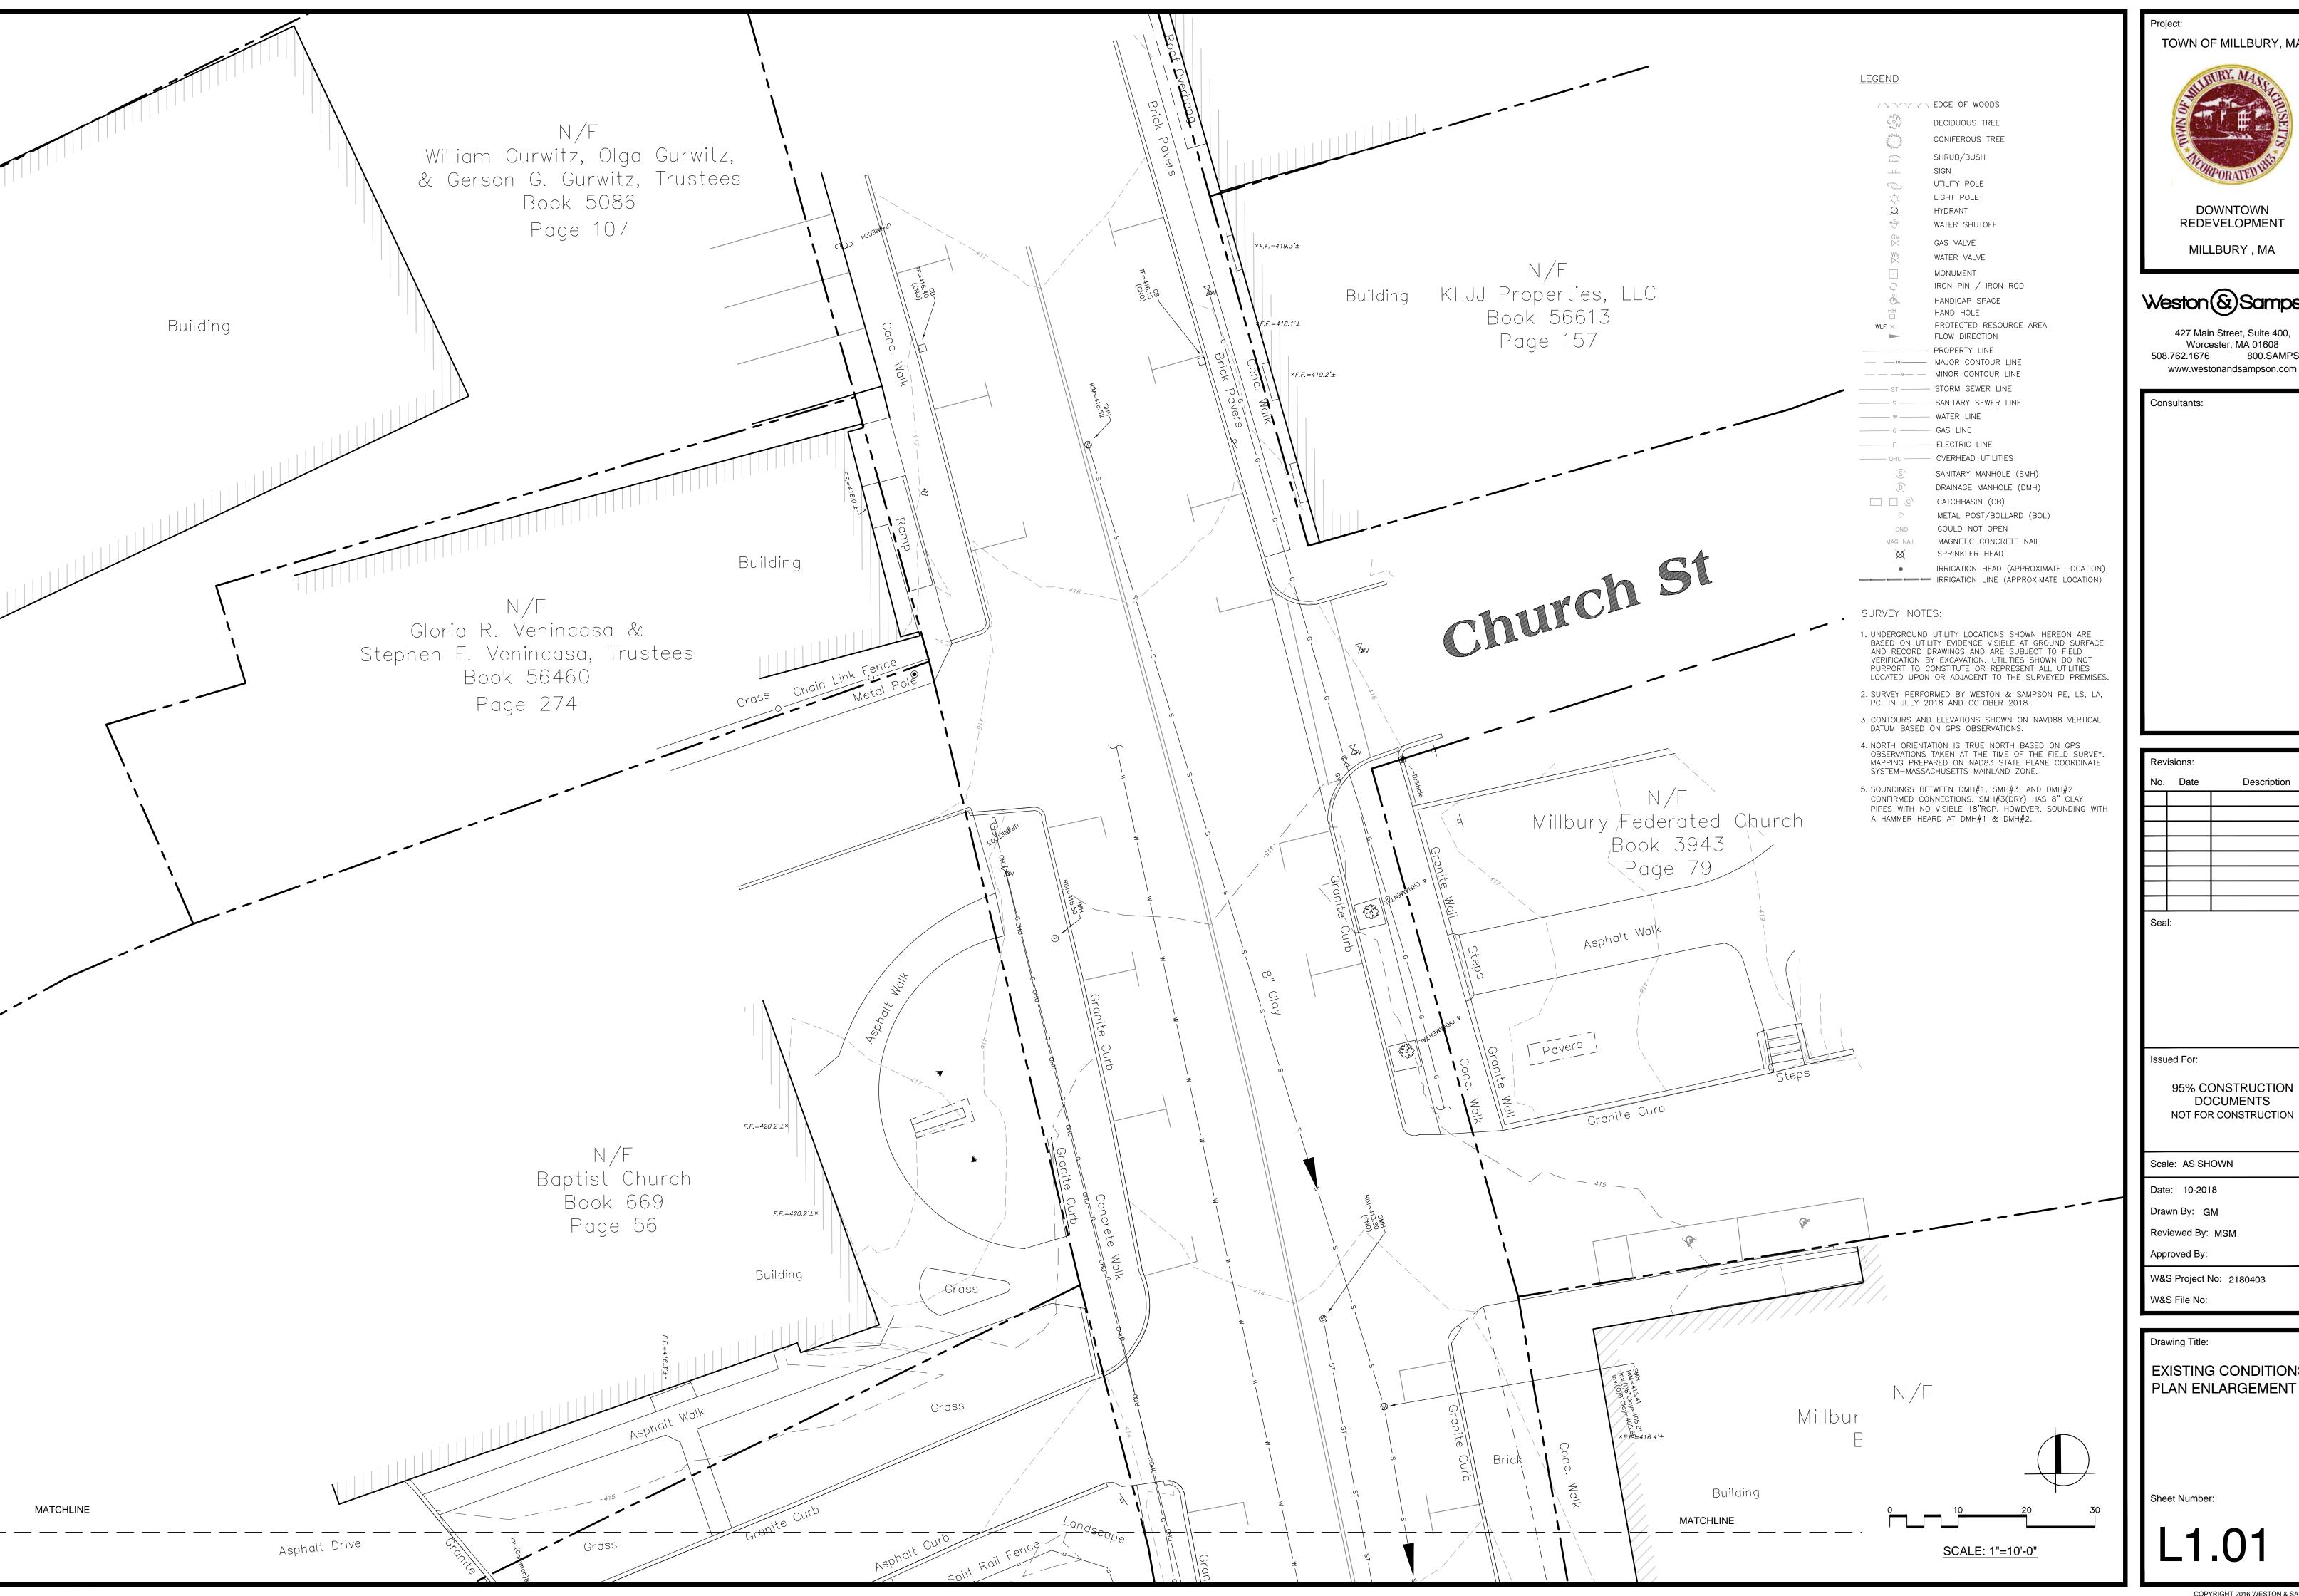
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OVERALL EXISTING CONDITIONS PLAN

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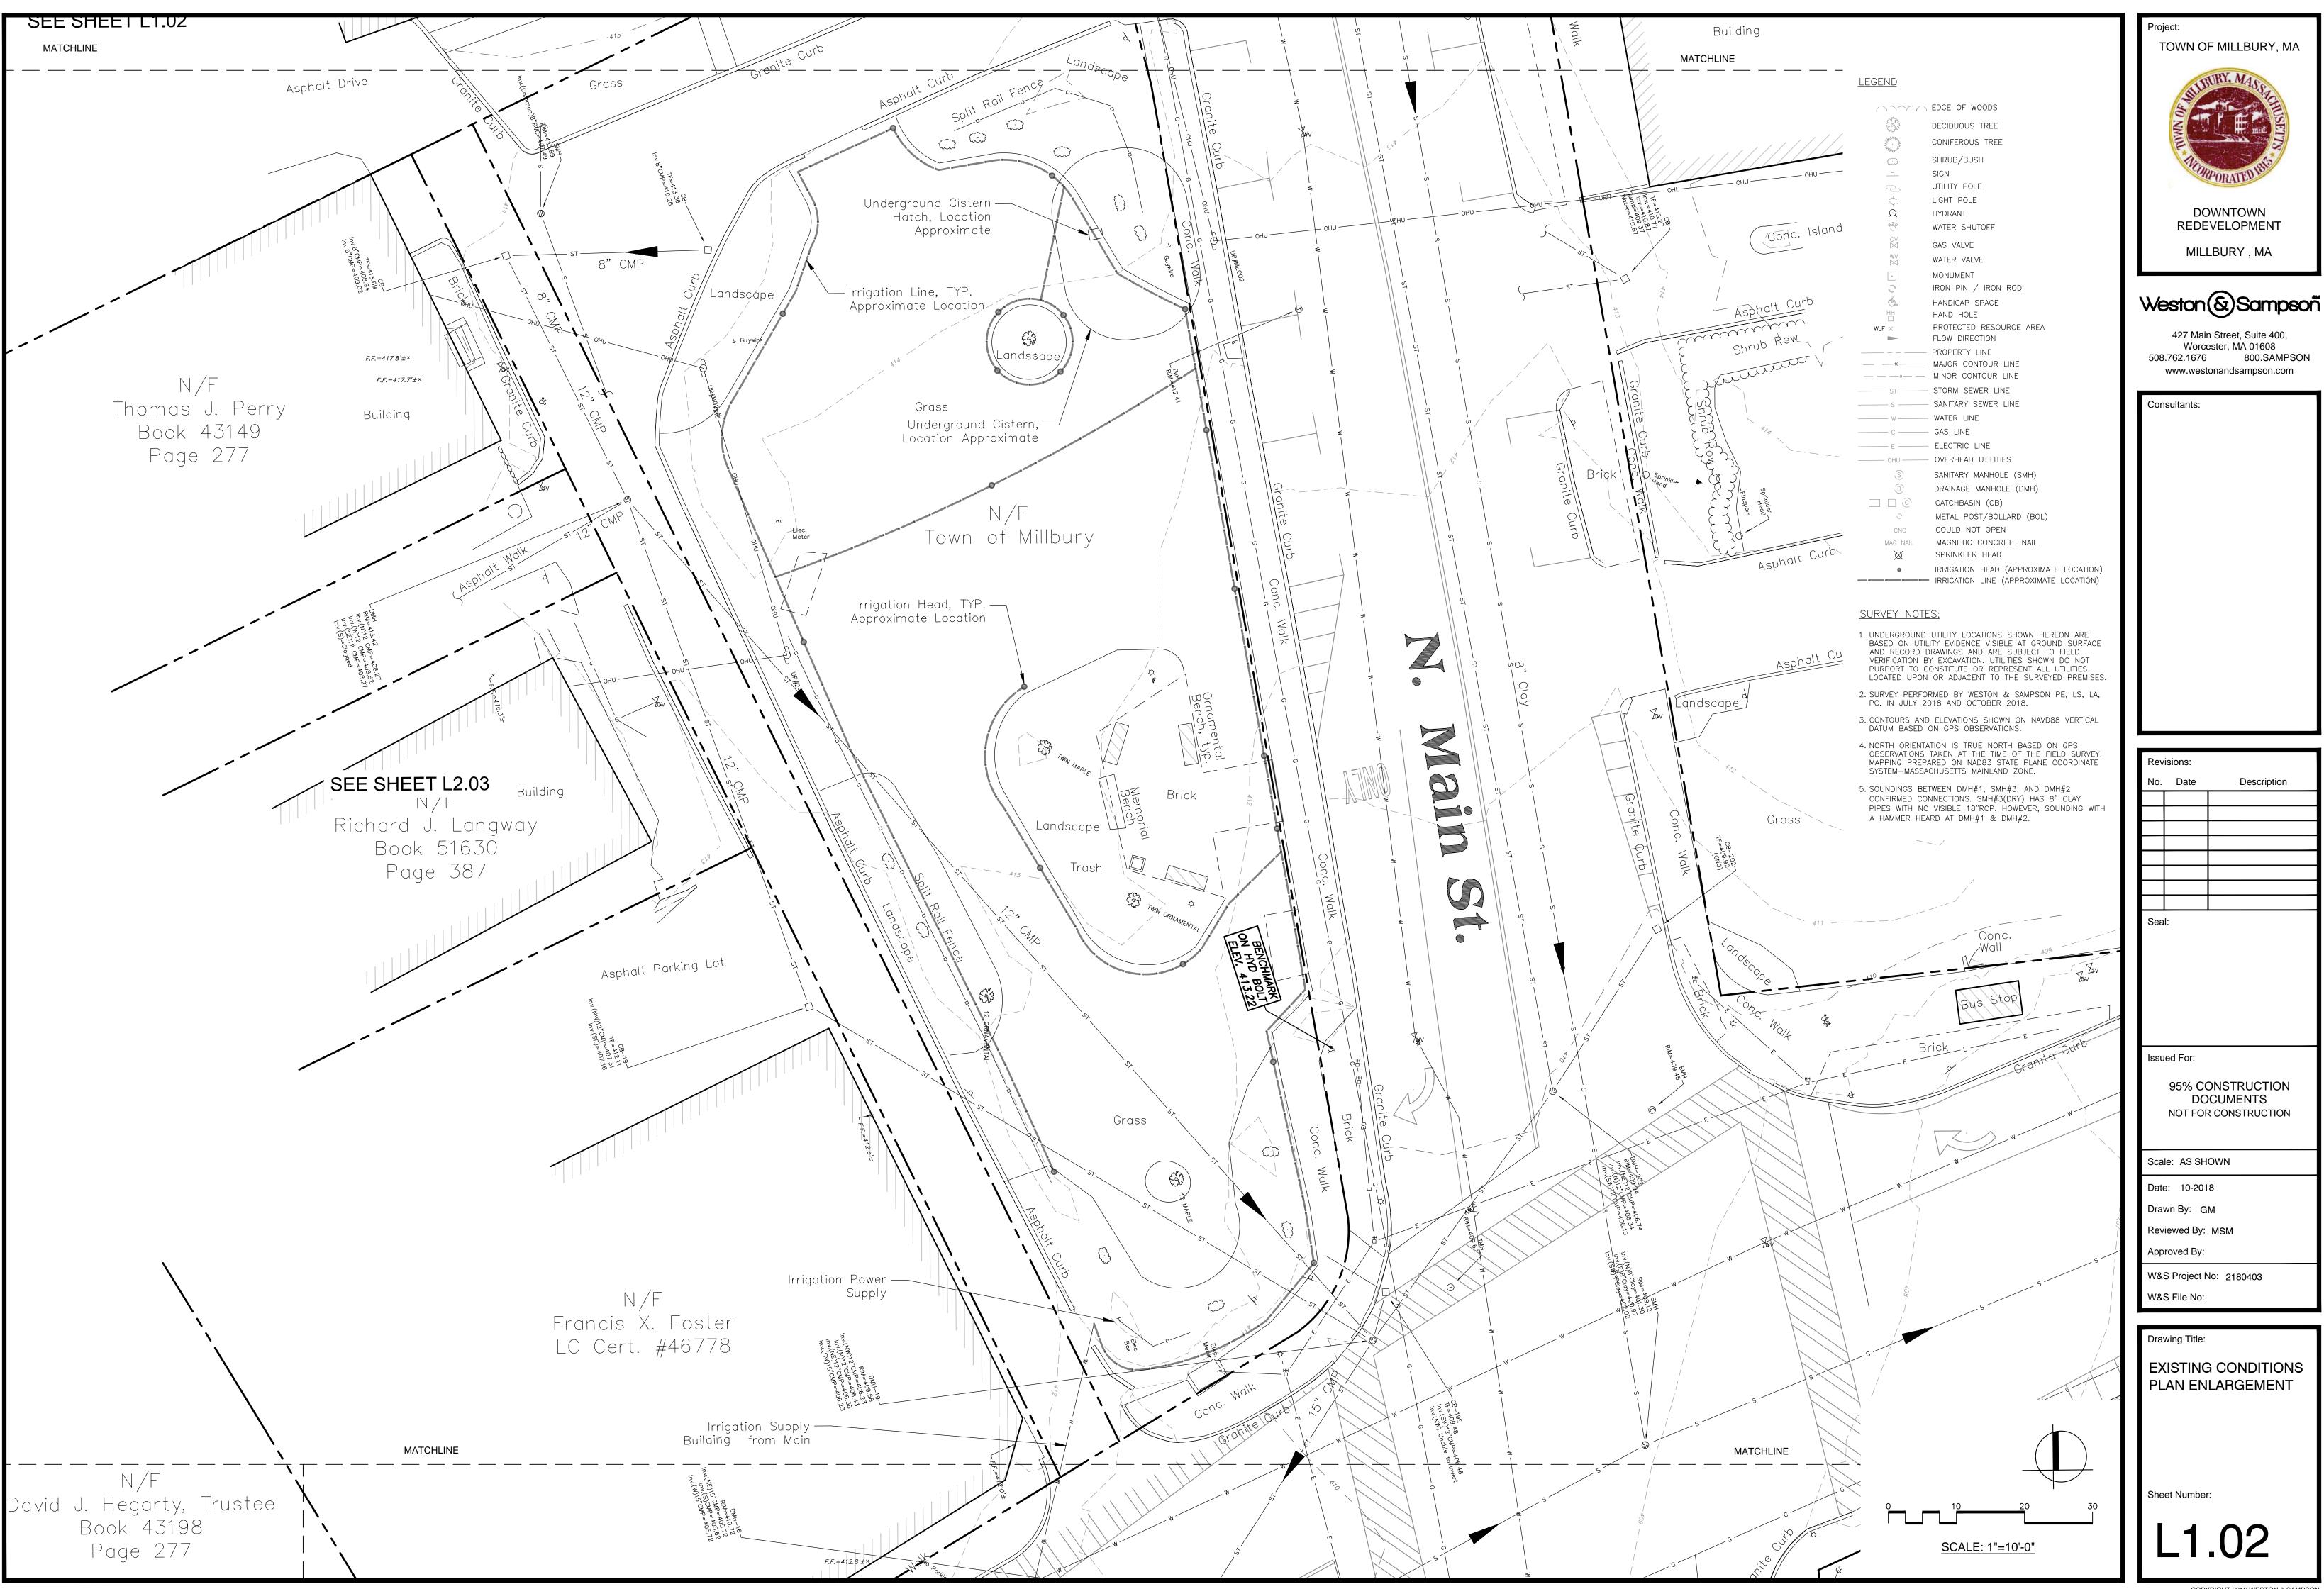
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EXISTING CONDITIONS PLAN ENLARGEMENT



MILLBURY, MA

DOWNTOWN

REDEVELOPMENT

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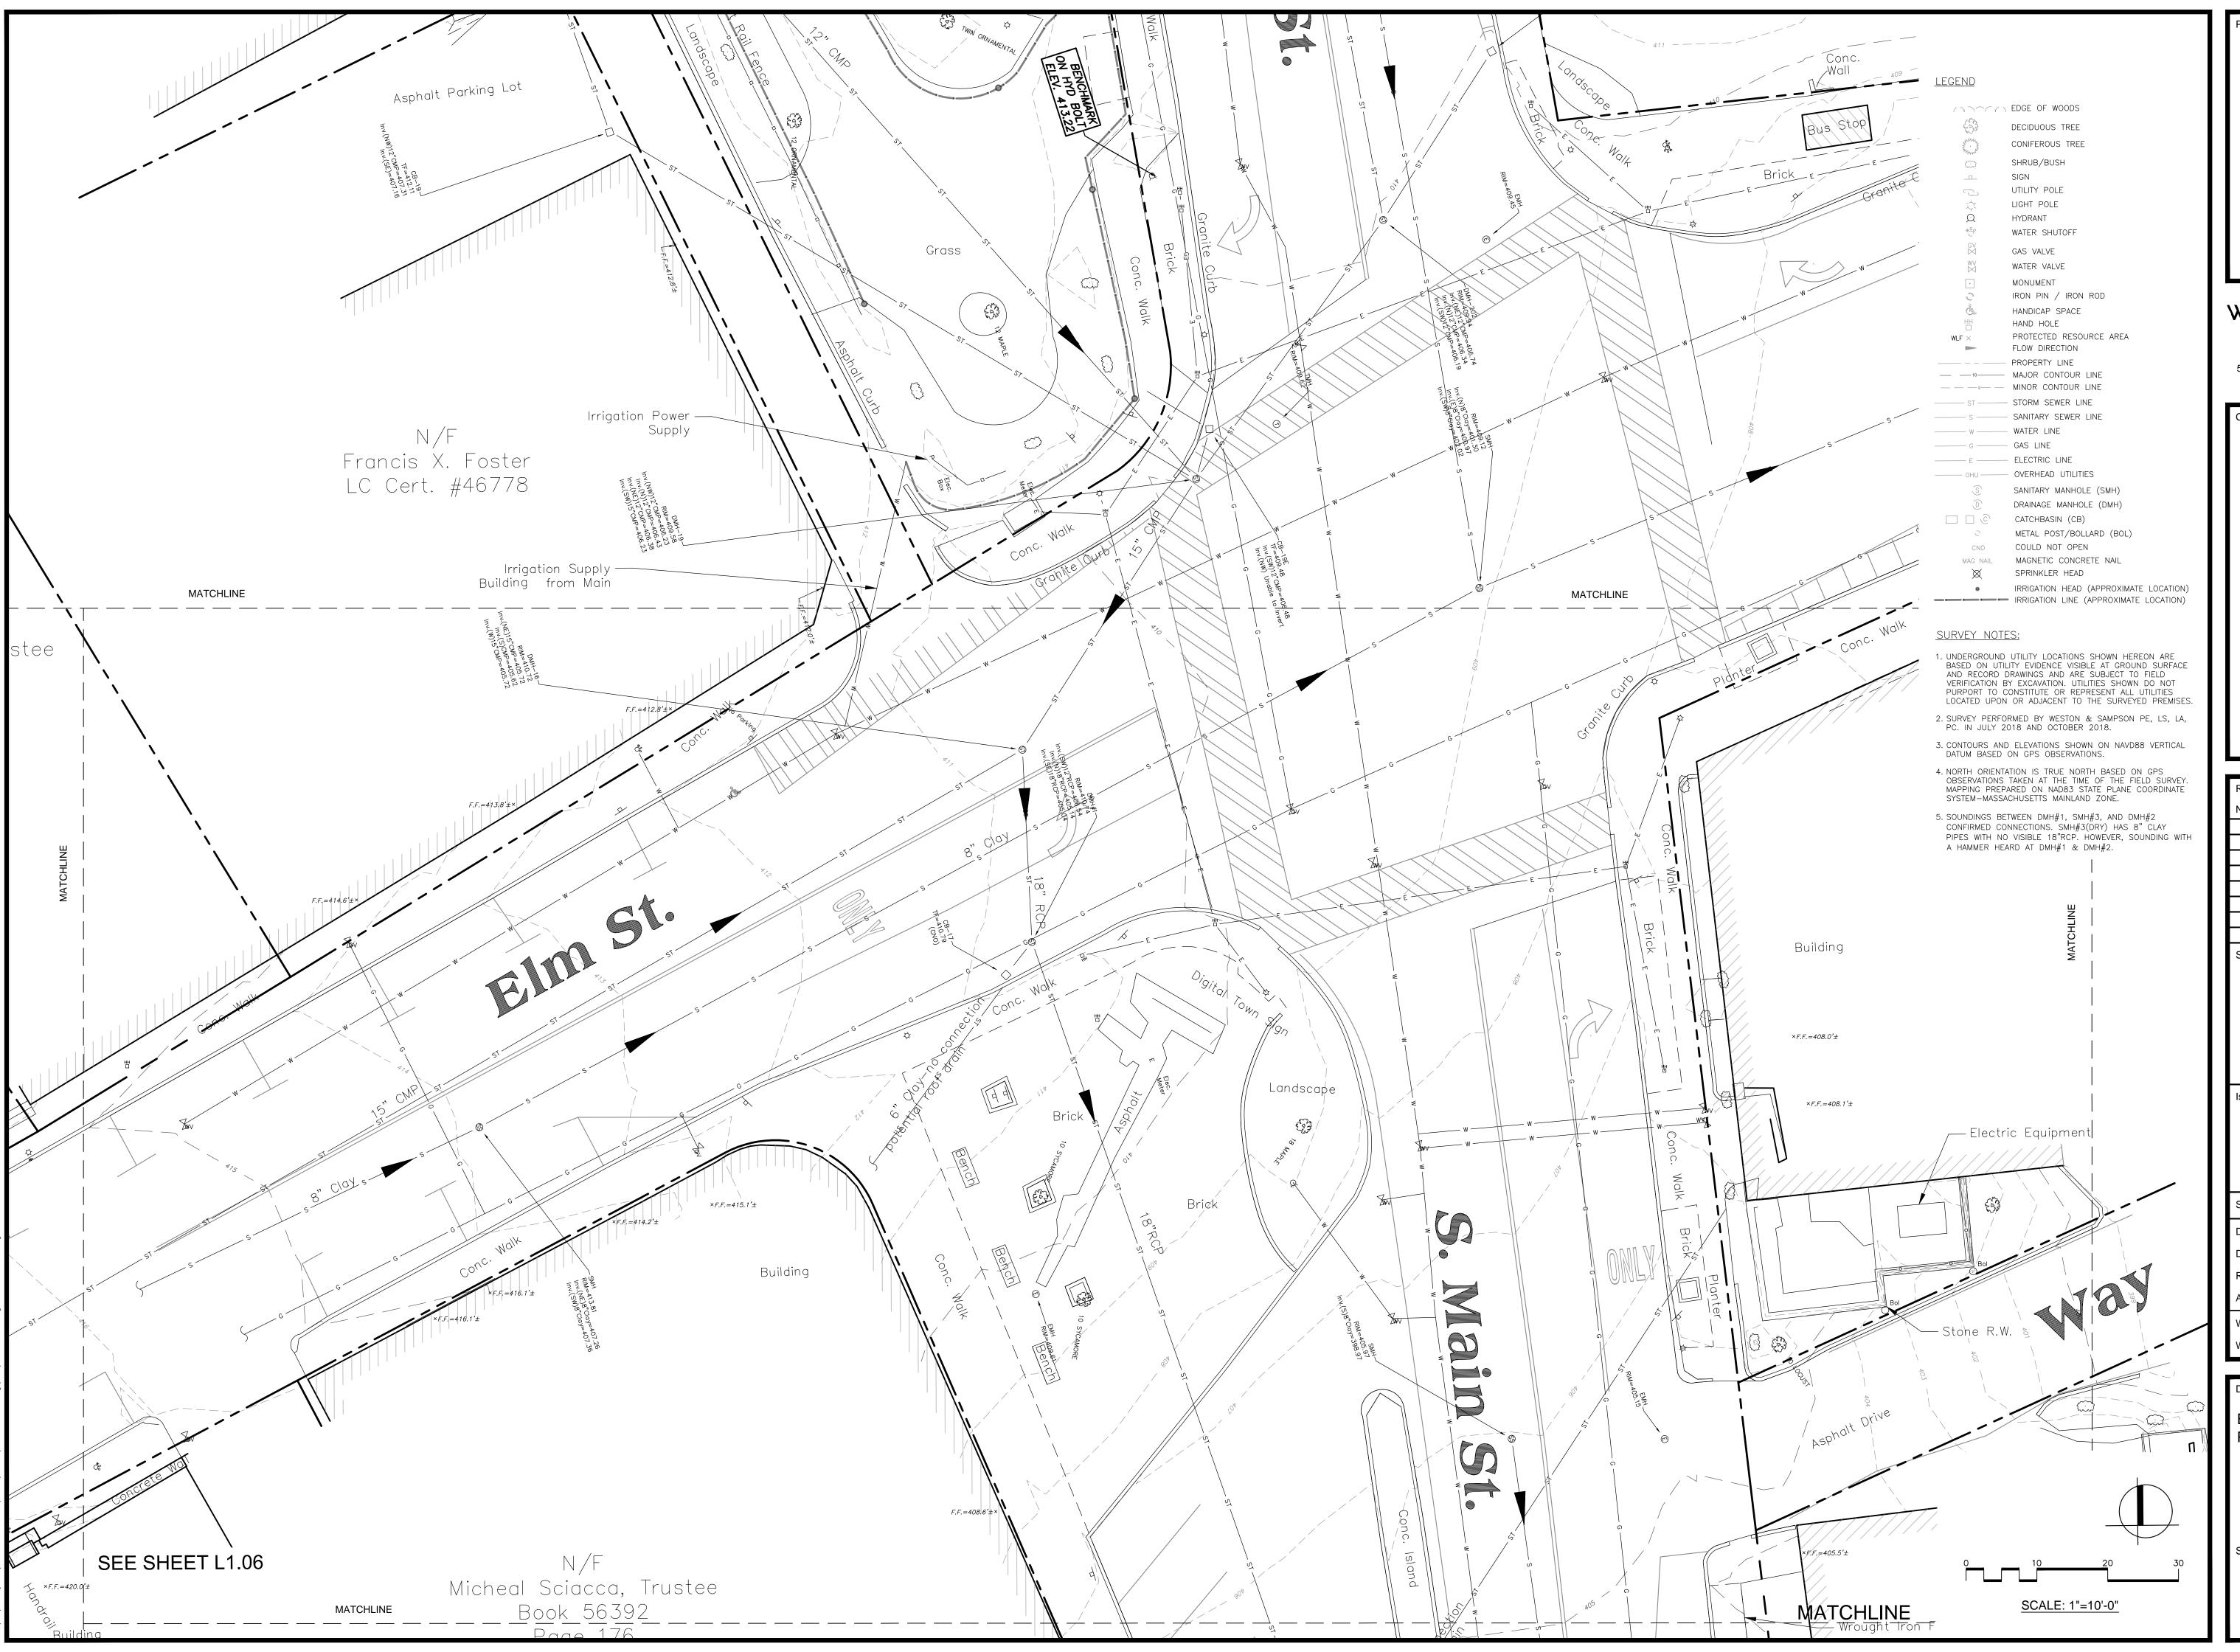
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MILLBURY, MA

Weston & Sampson

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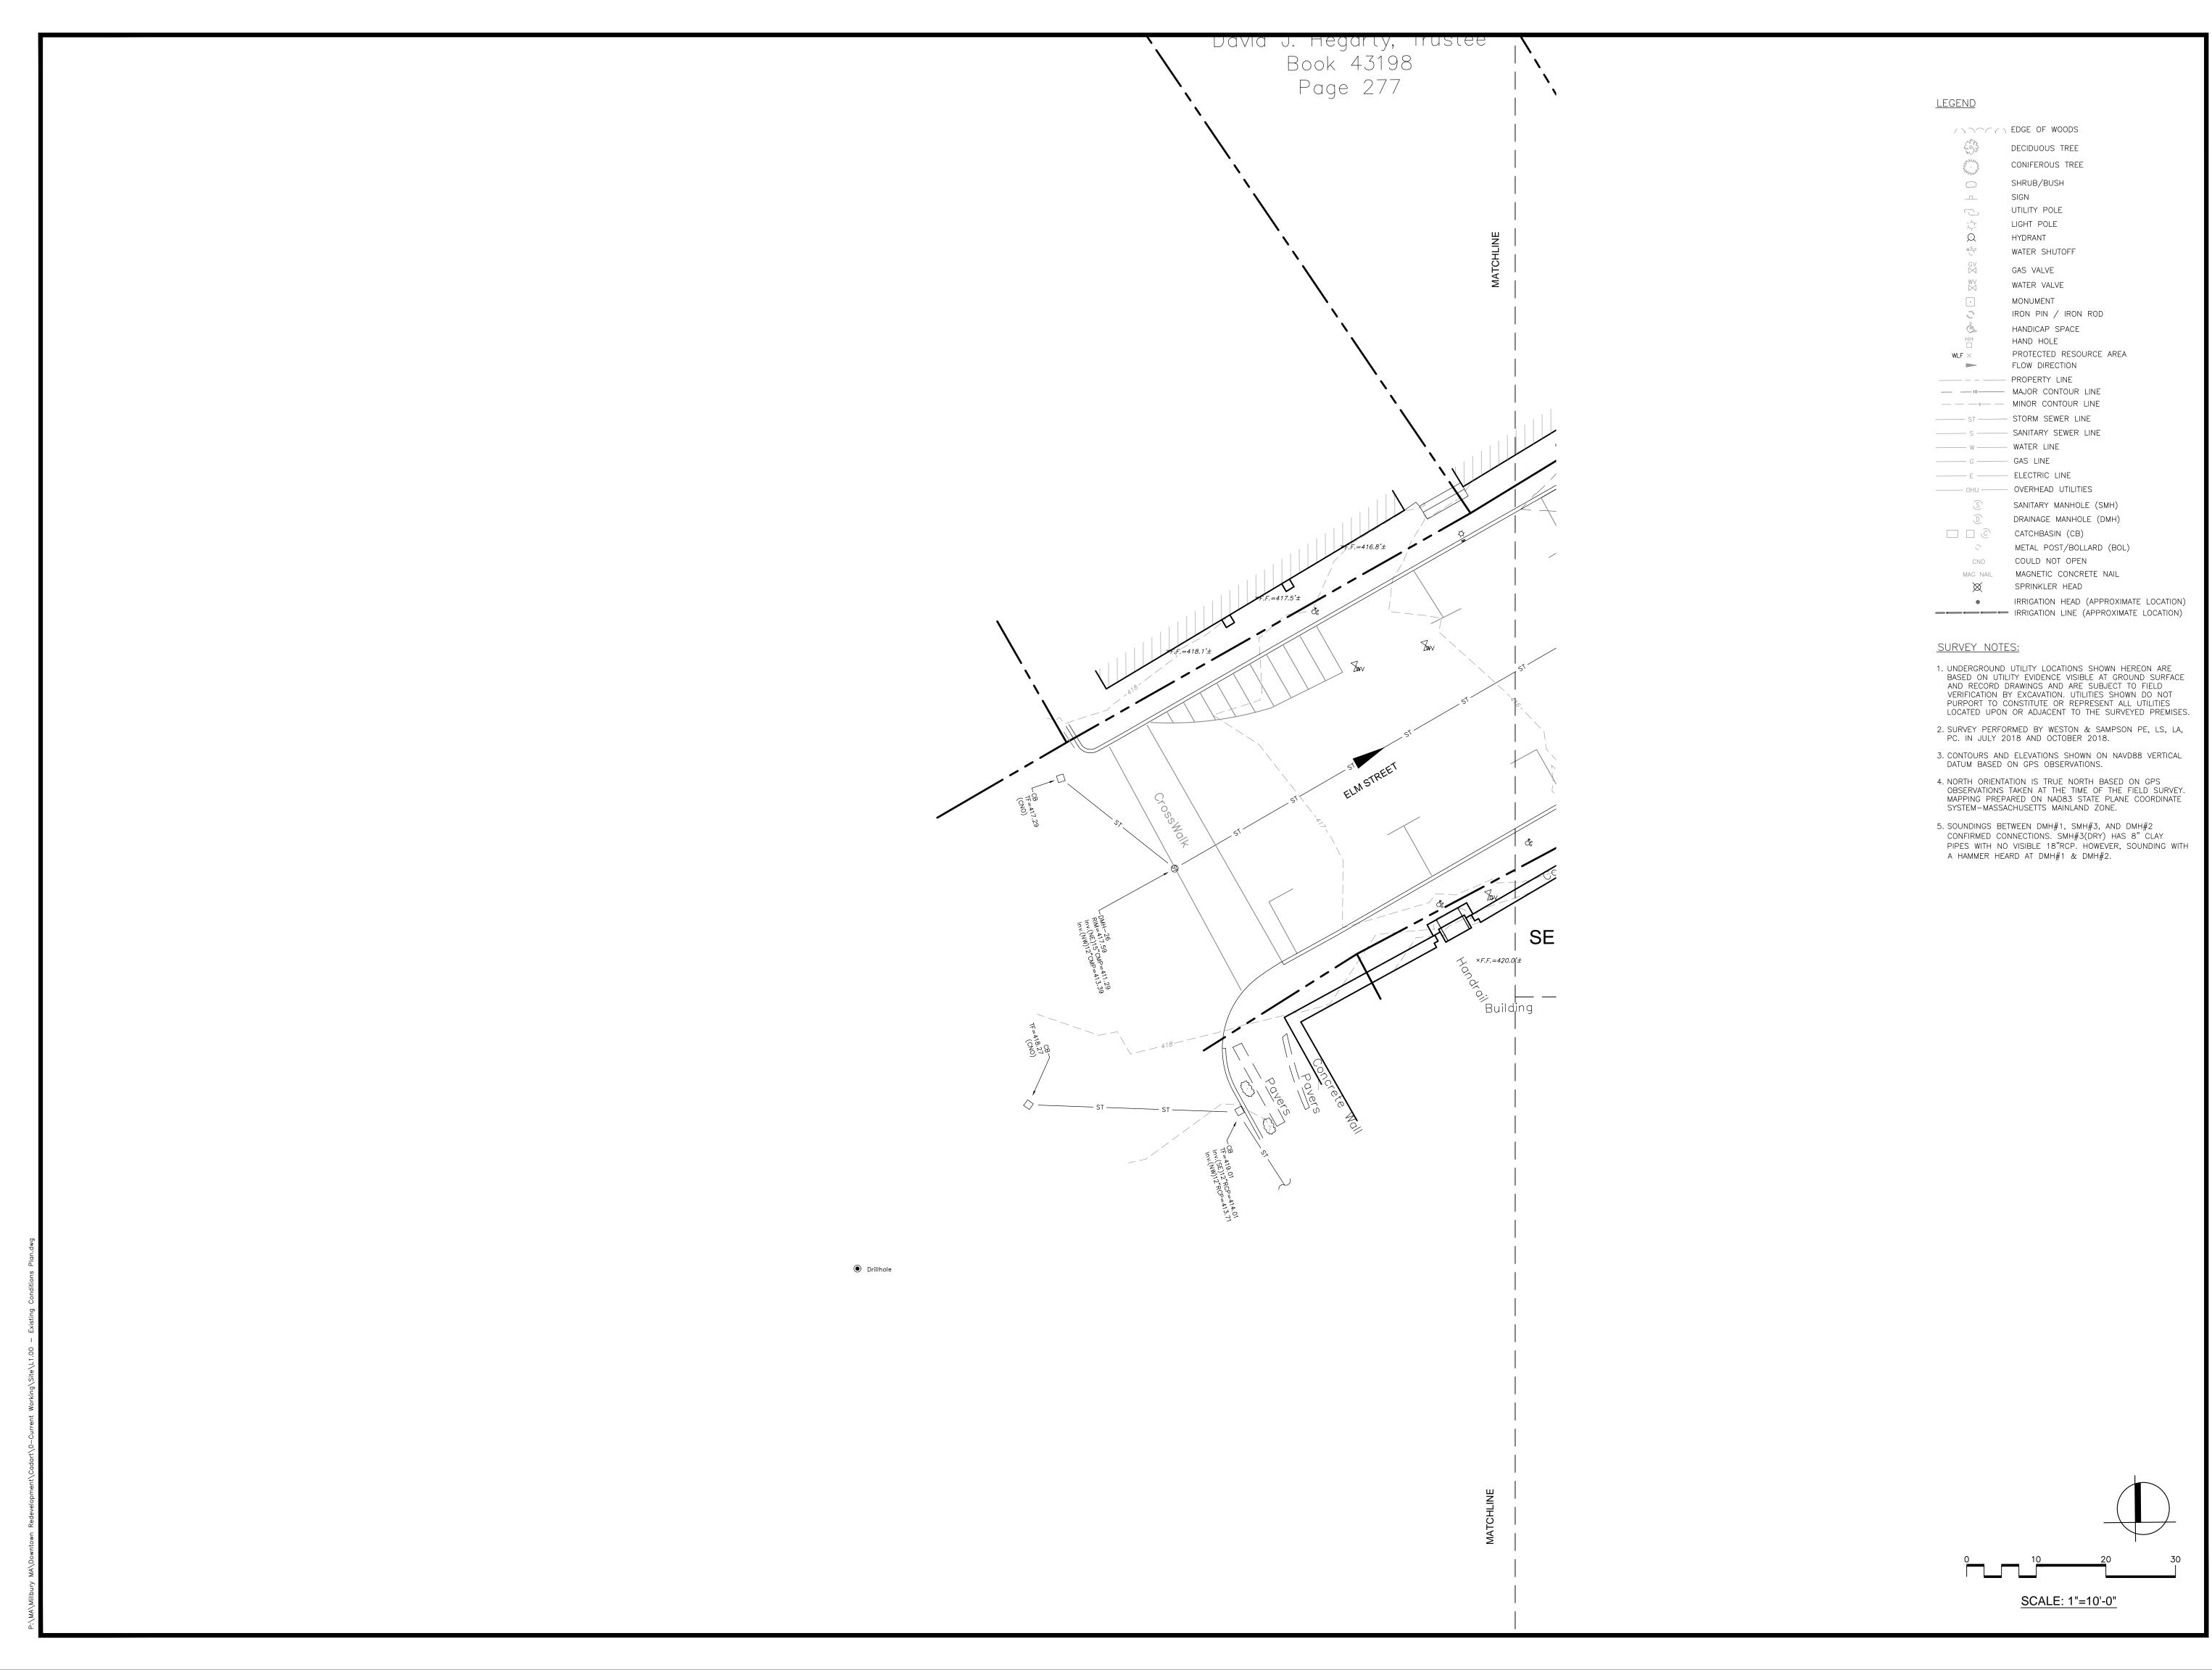
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Drawing Title:

EXISTING CONDITIONS PLAN ENLARGEMENT

Sheet Number:

L1.03



Project:
TOWN OF MILLBURY, MA



REDEVELOPMENT
MILLBURY, MA

DOWNTOWN

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Date: 10-2018

Drawn By: GM

Reviewed By: MSM
Approved By:


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Drawing Title:

EXISTING CONDITIONS PLAN ENLARGEMENT

Sheet Number:

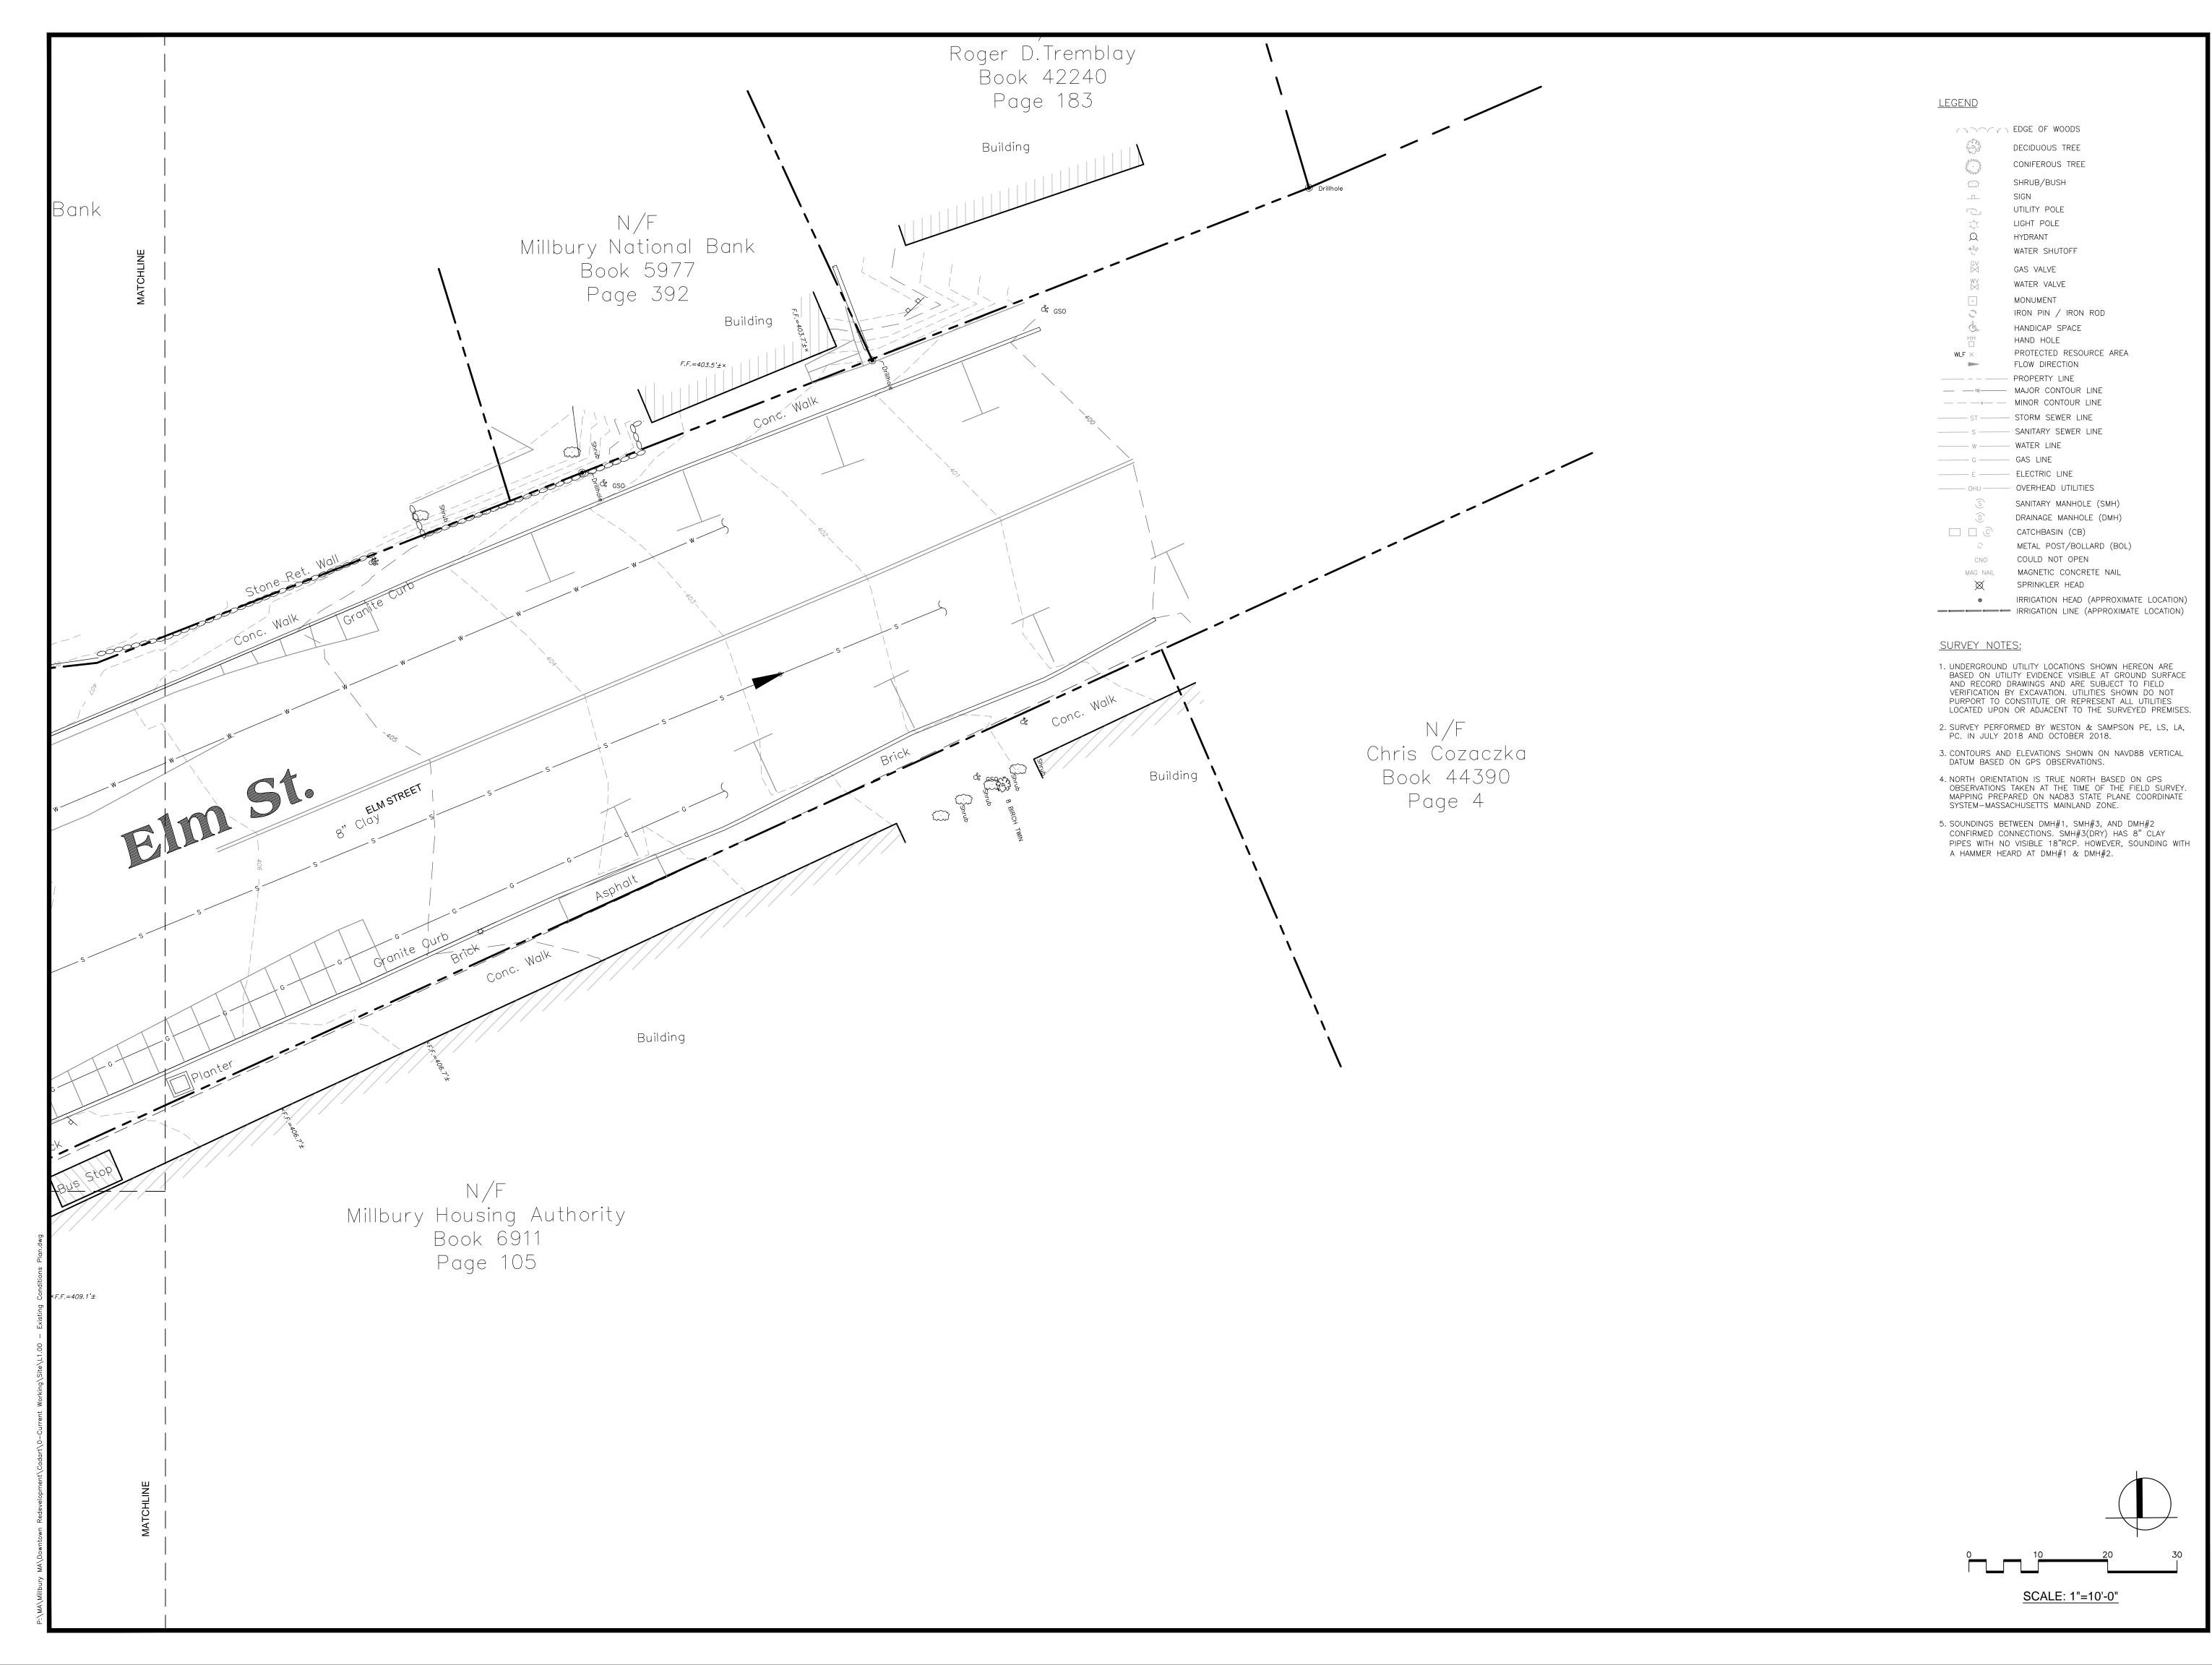L1.04



REDEVELOPMENT MILLBURY, MA

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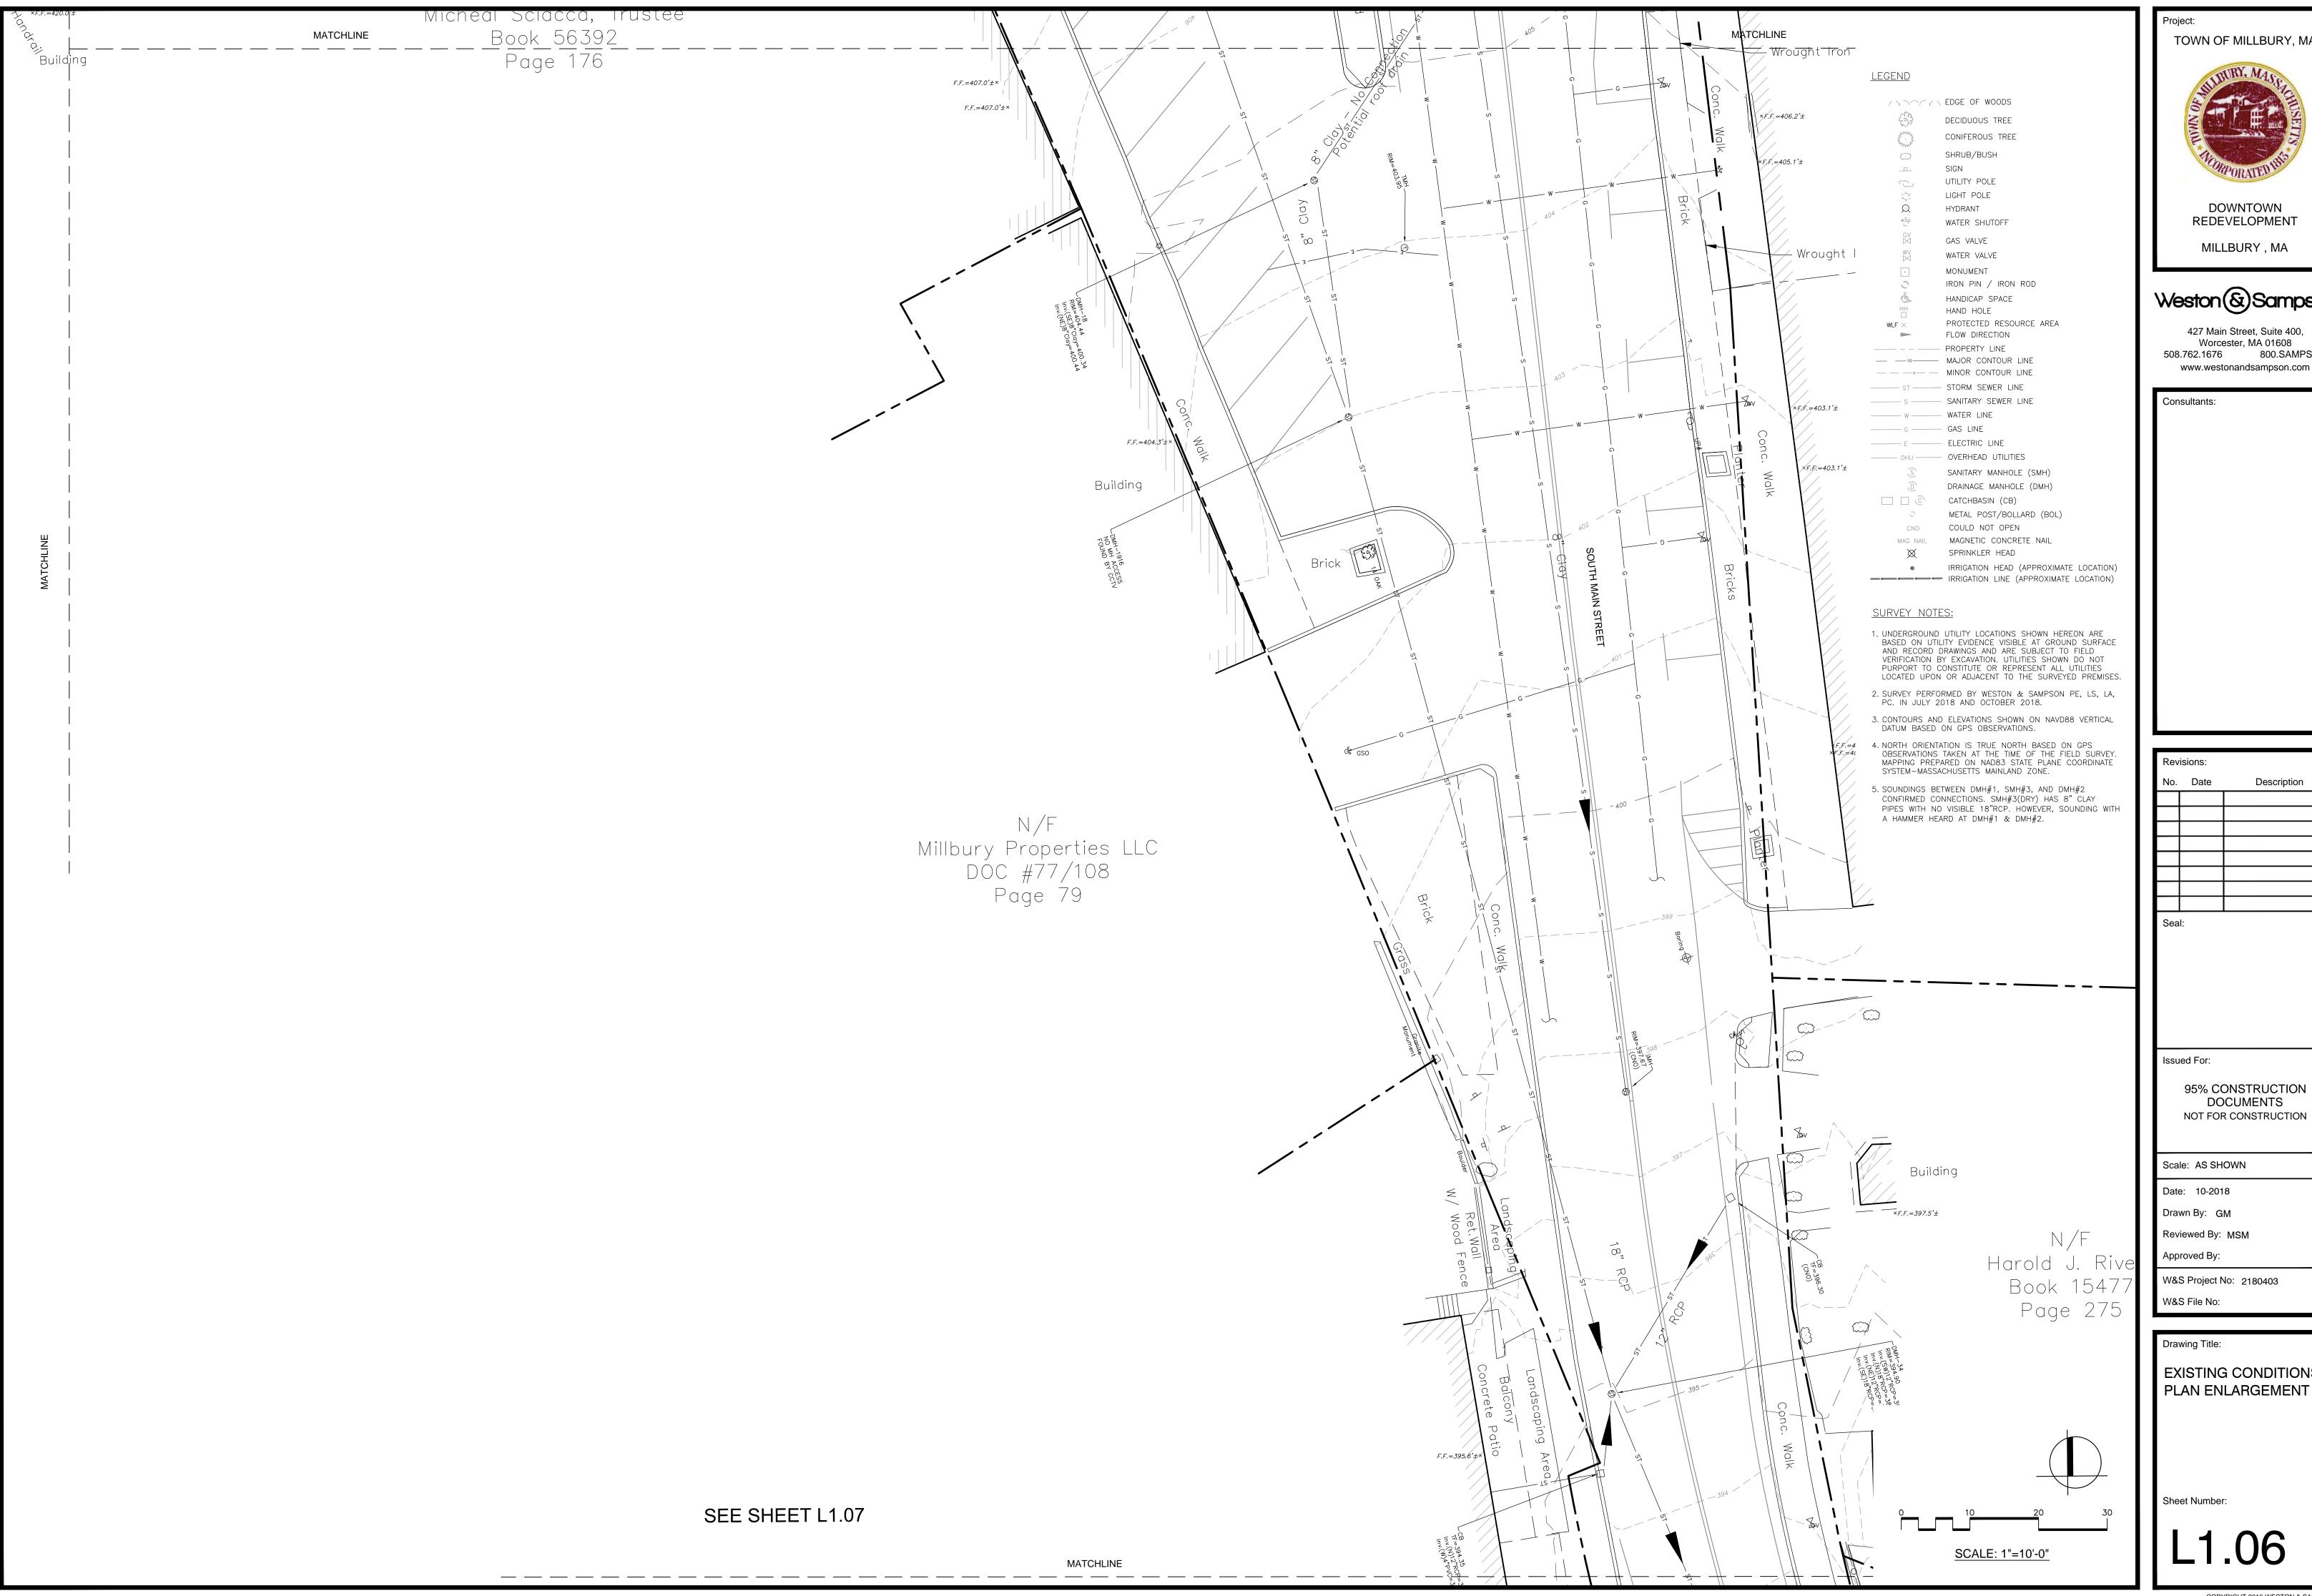
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EXISTING CONDITIONS PLAN ENLARGEMENT

Sheet Number:





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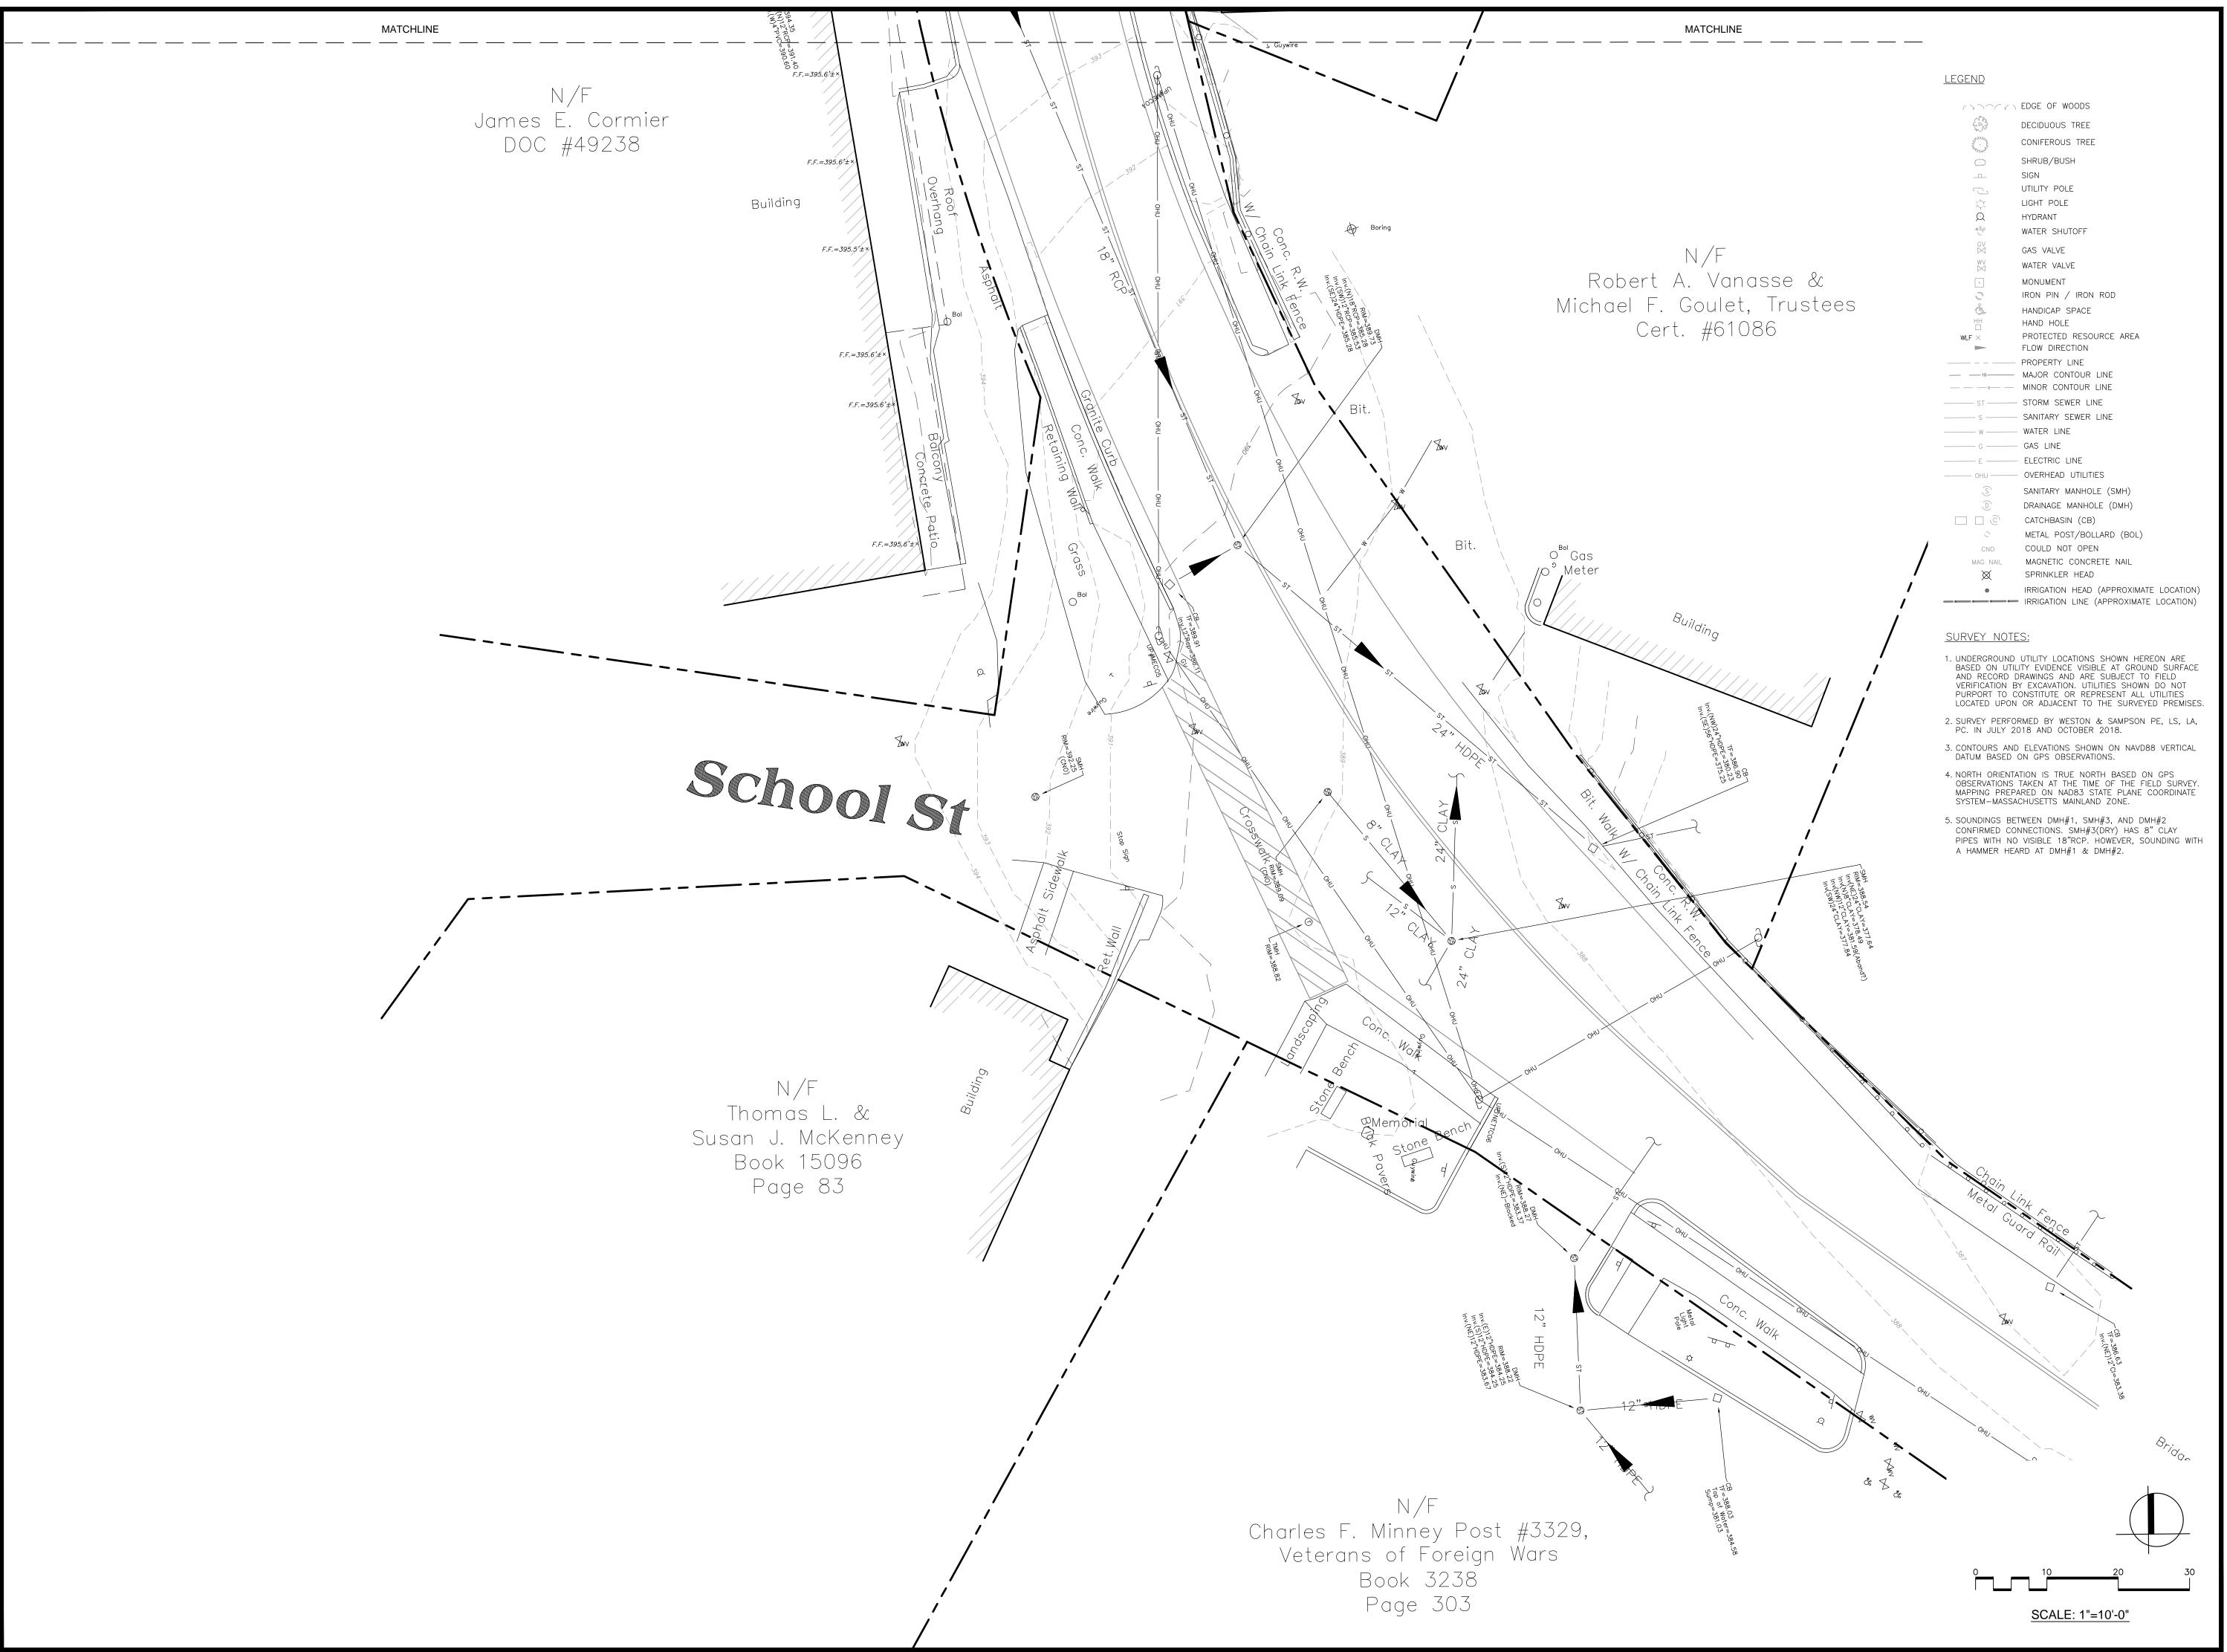
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EXISTING CONDITIONS PLAN ENLARGEMENT

L1.06





REDEVELOPMENT
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W&S Project No: 2180403

Drawing Title:

EXISTING CONDITIONS PLAN ENLARGEMENT

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L1.07



DOWNTOWN REDEVELOPMENT

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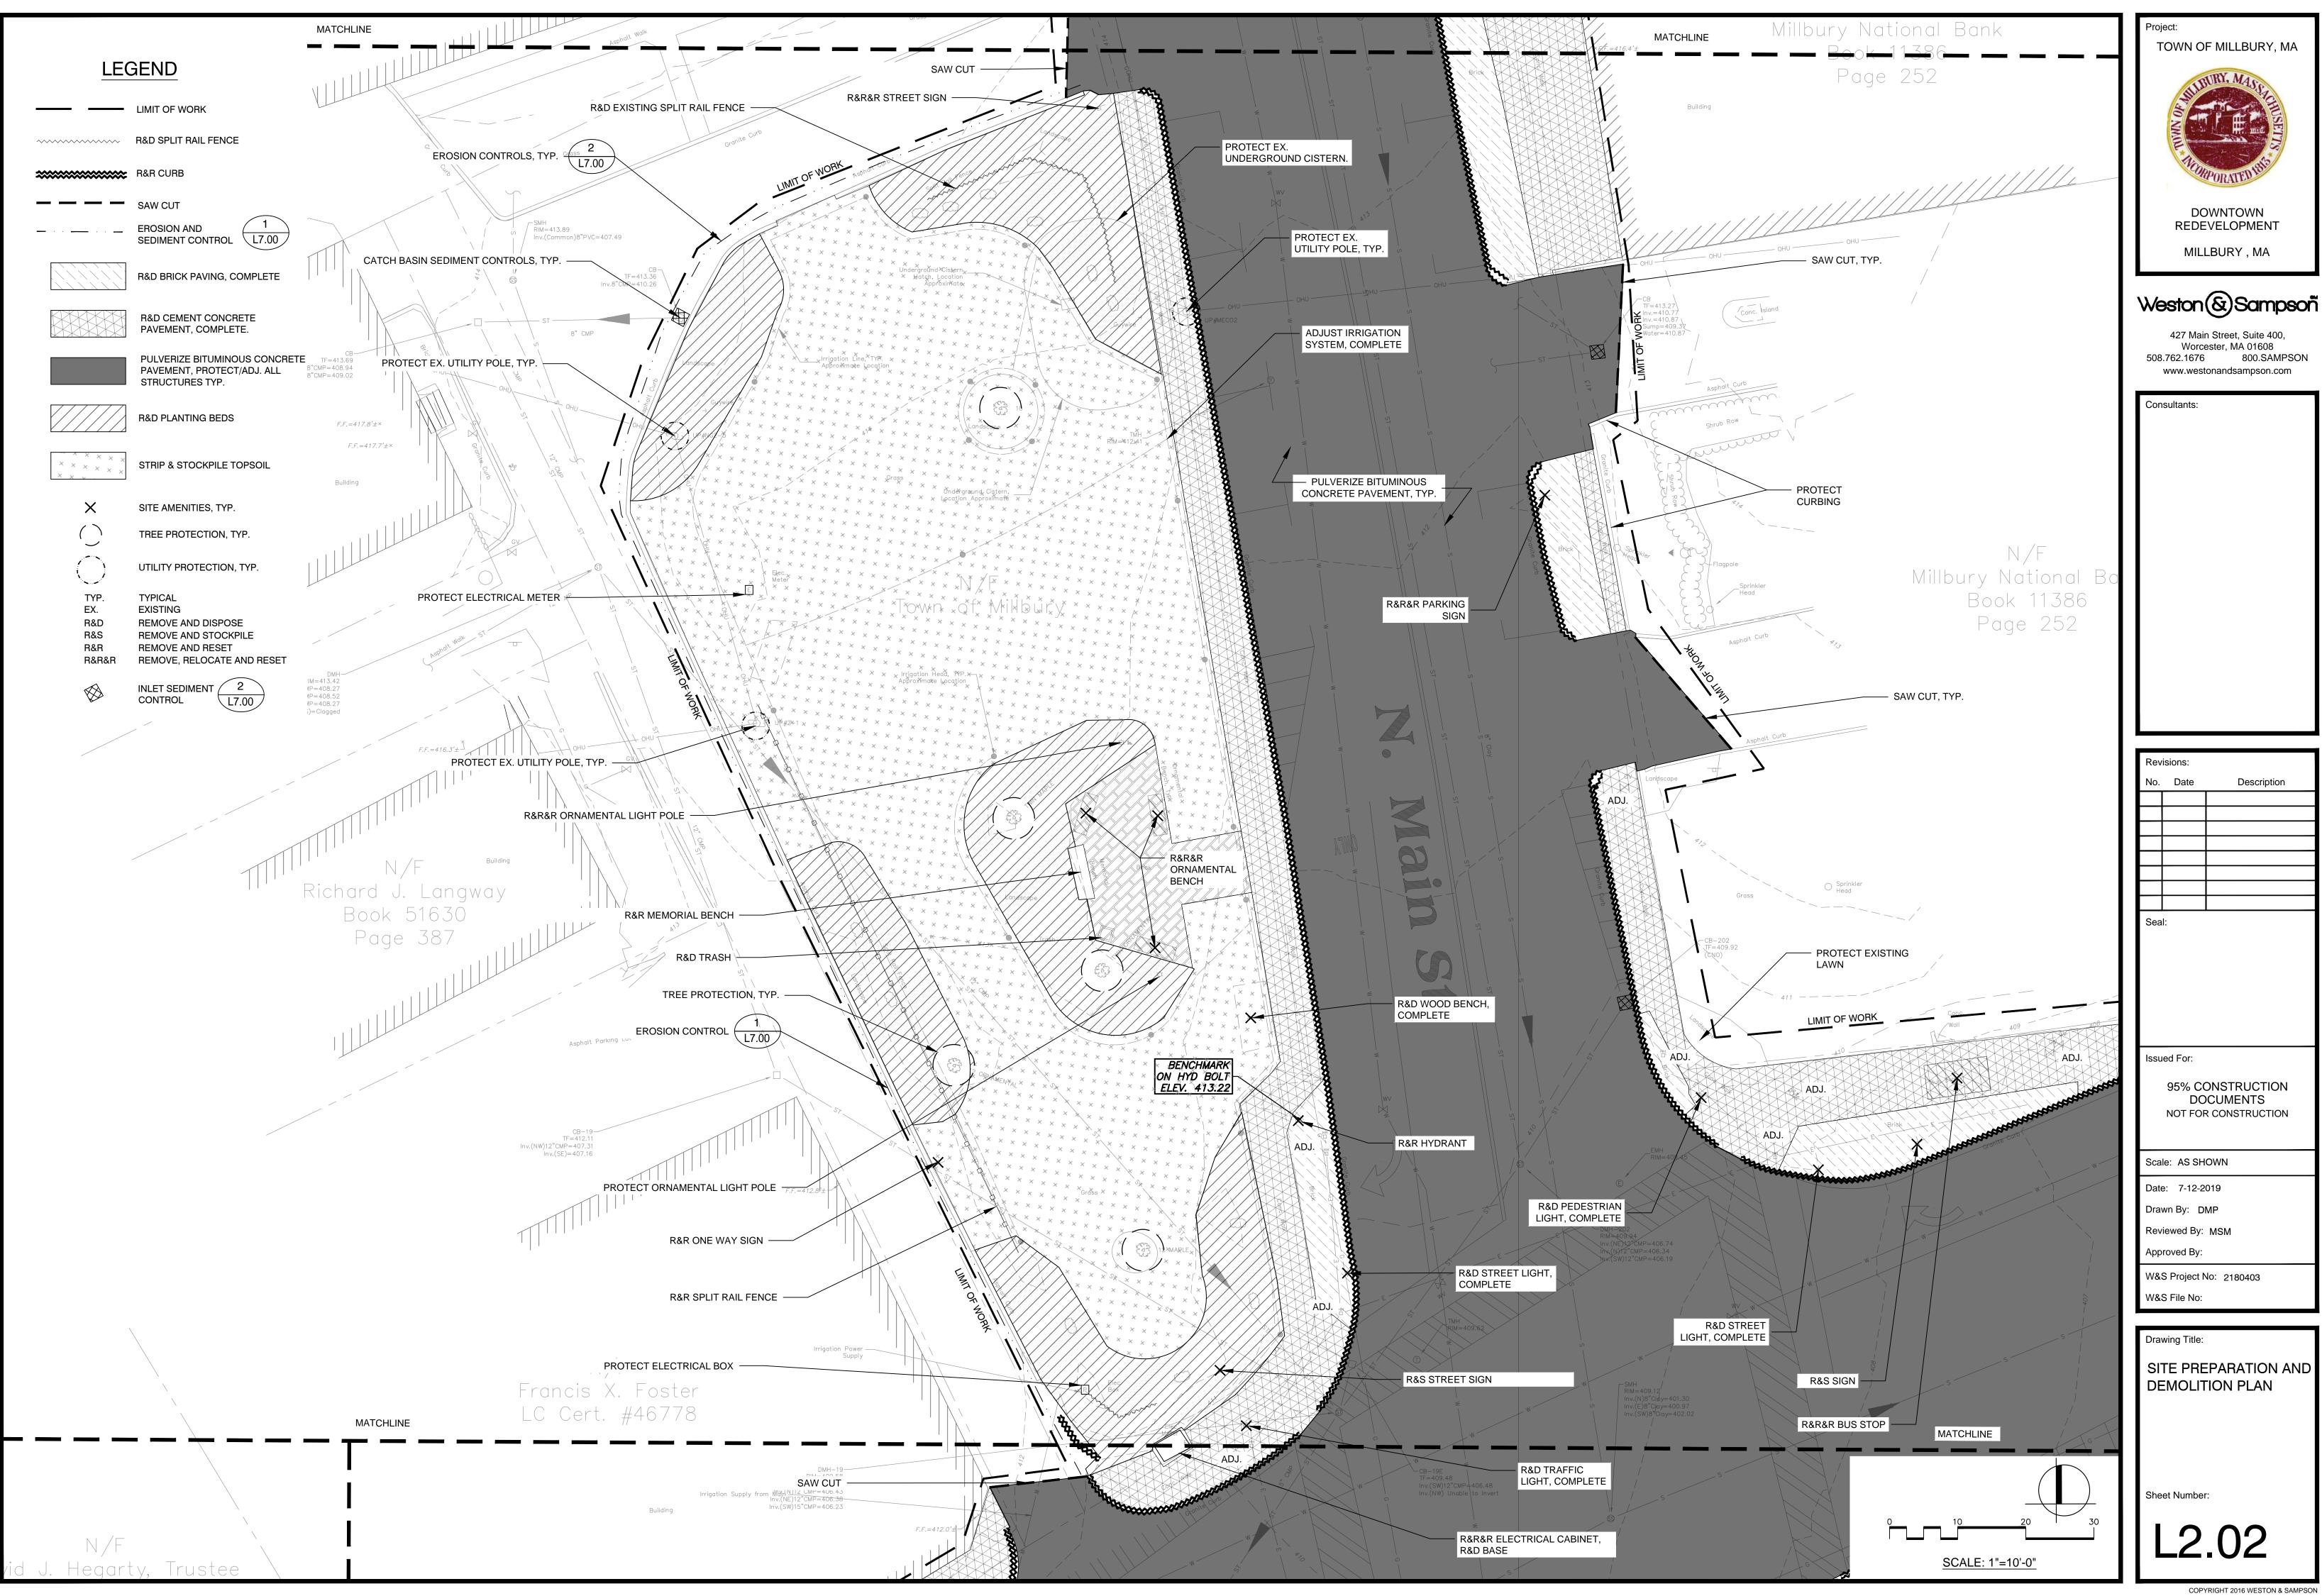
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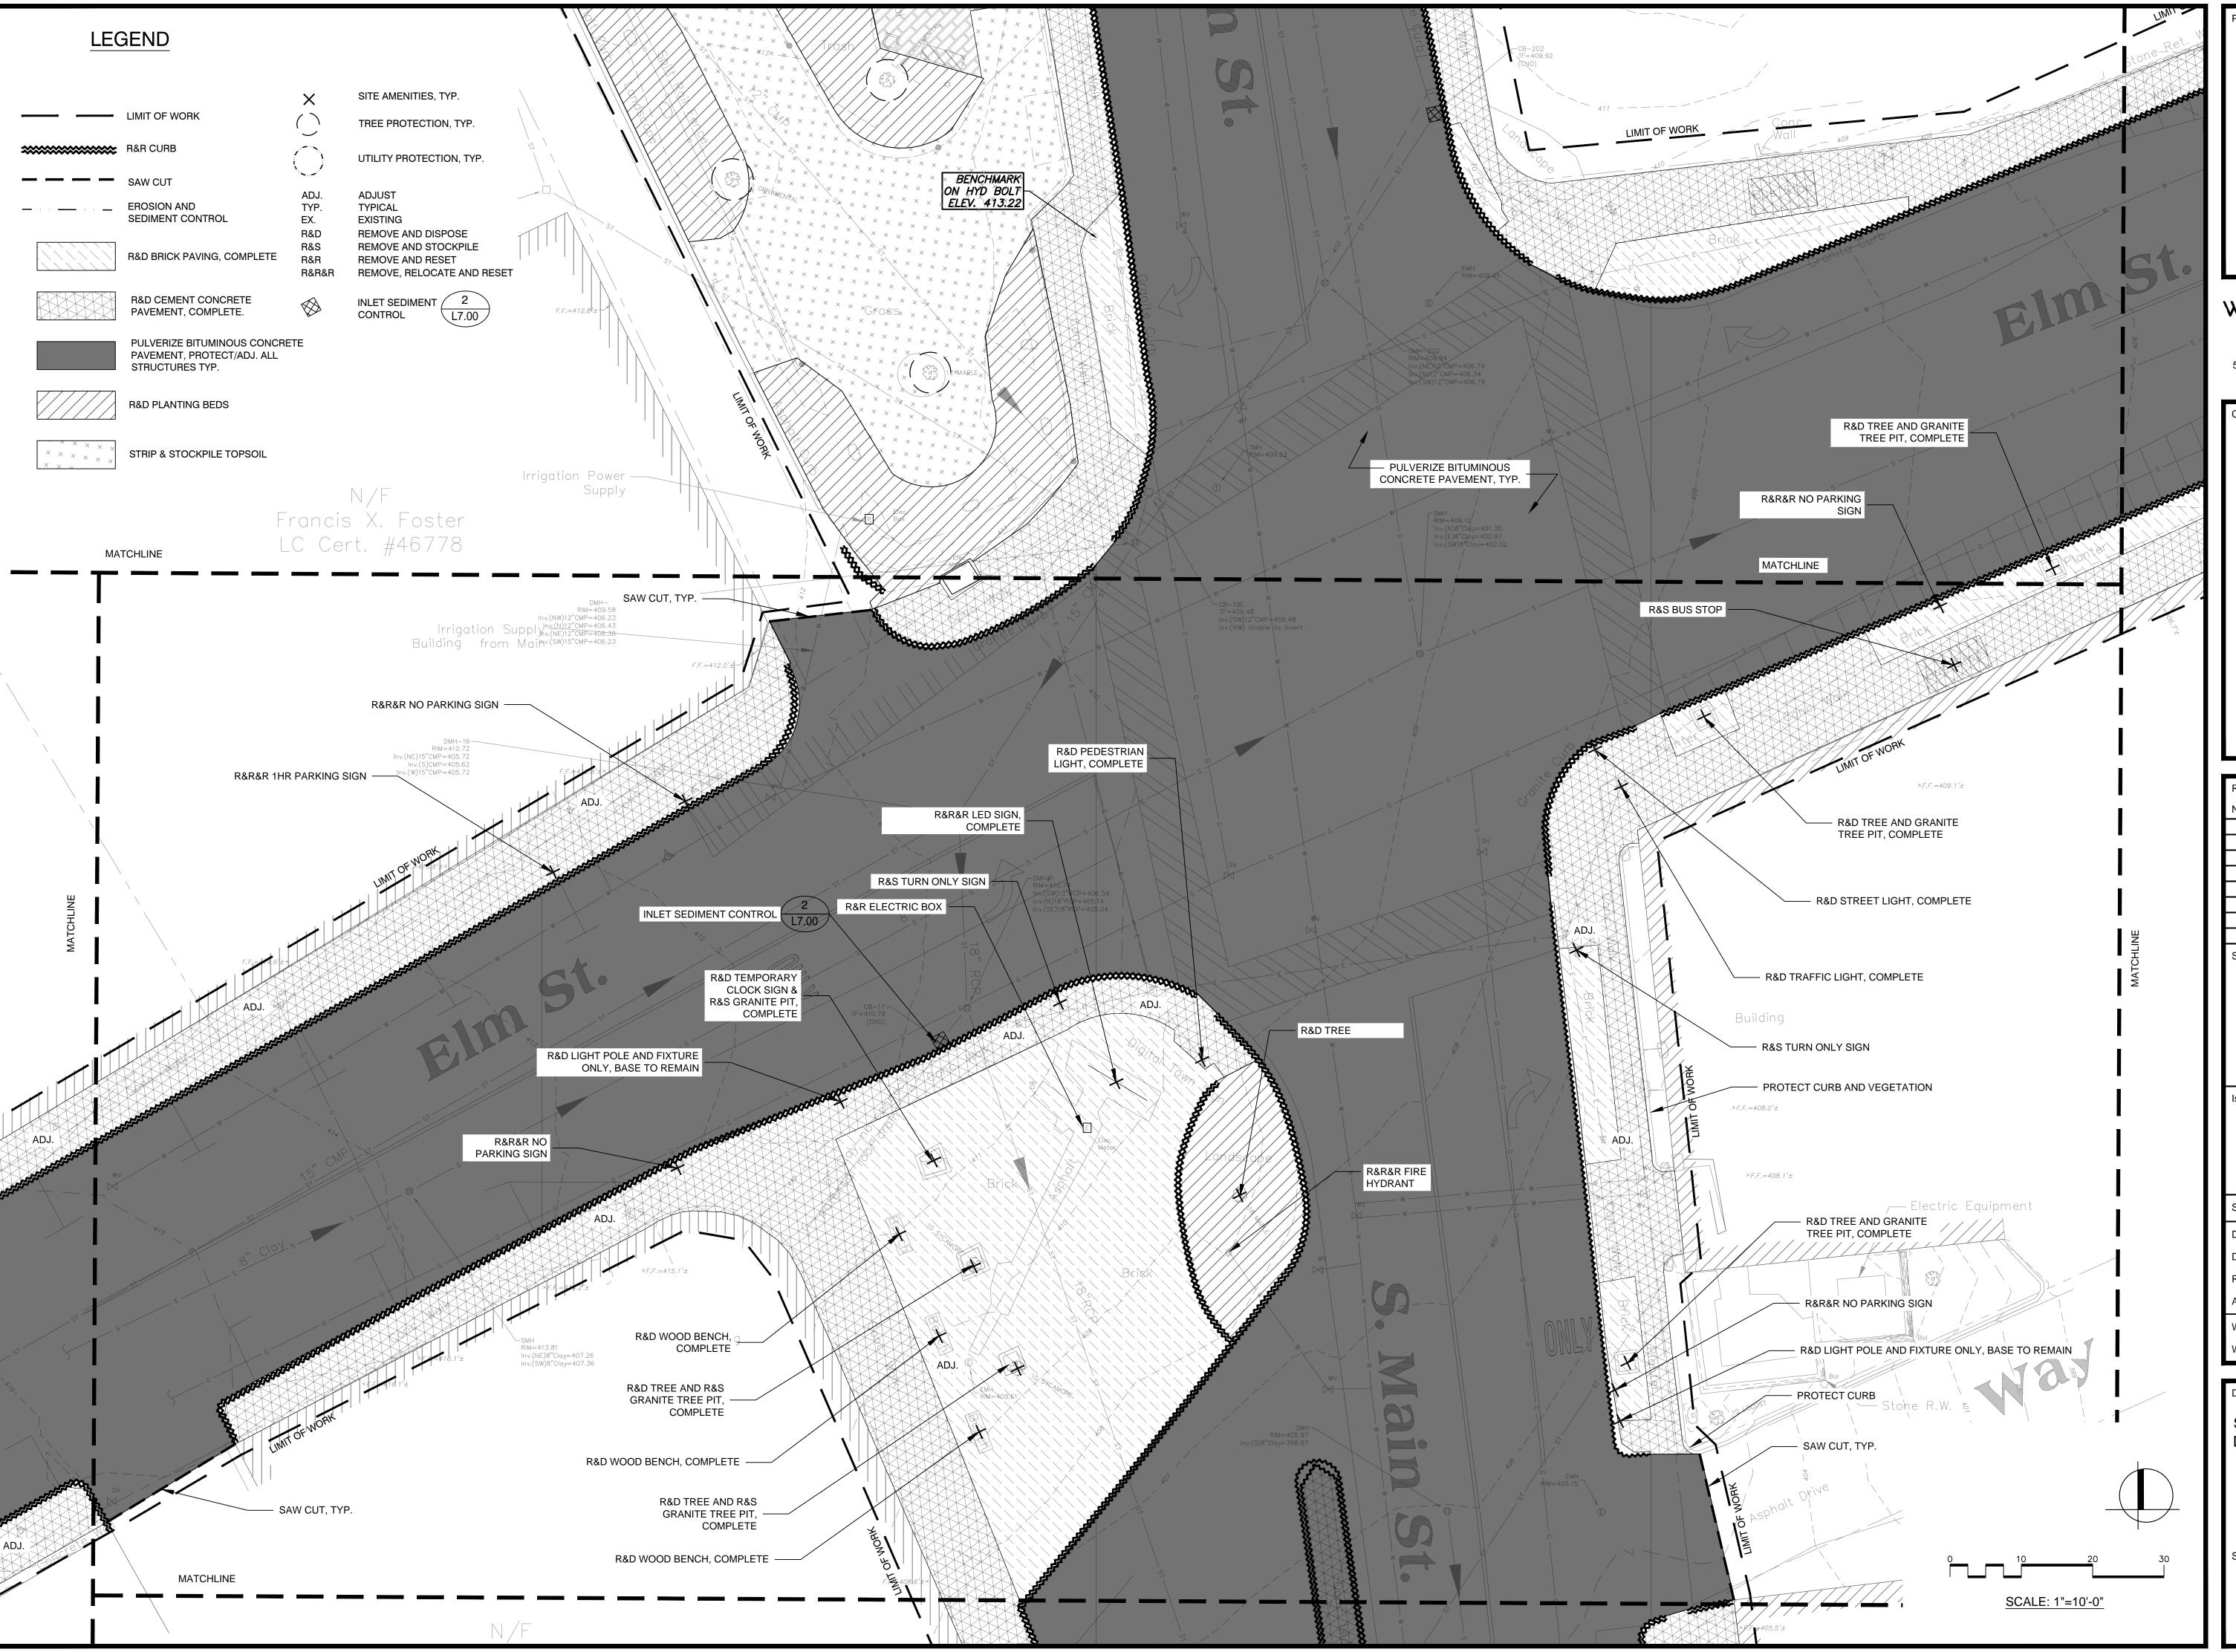
Drawing Title:

SITE PREPARATION AND DEMOLITION PLAN

Sheet Number:

L2.01





Project:
TOWN OF MILLBURY, MA

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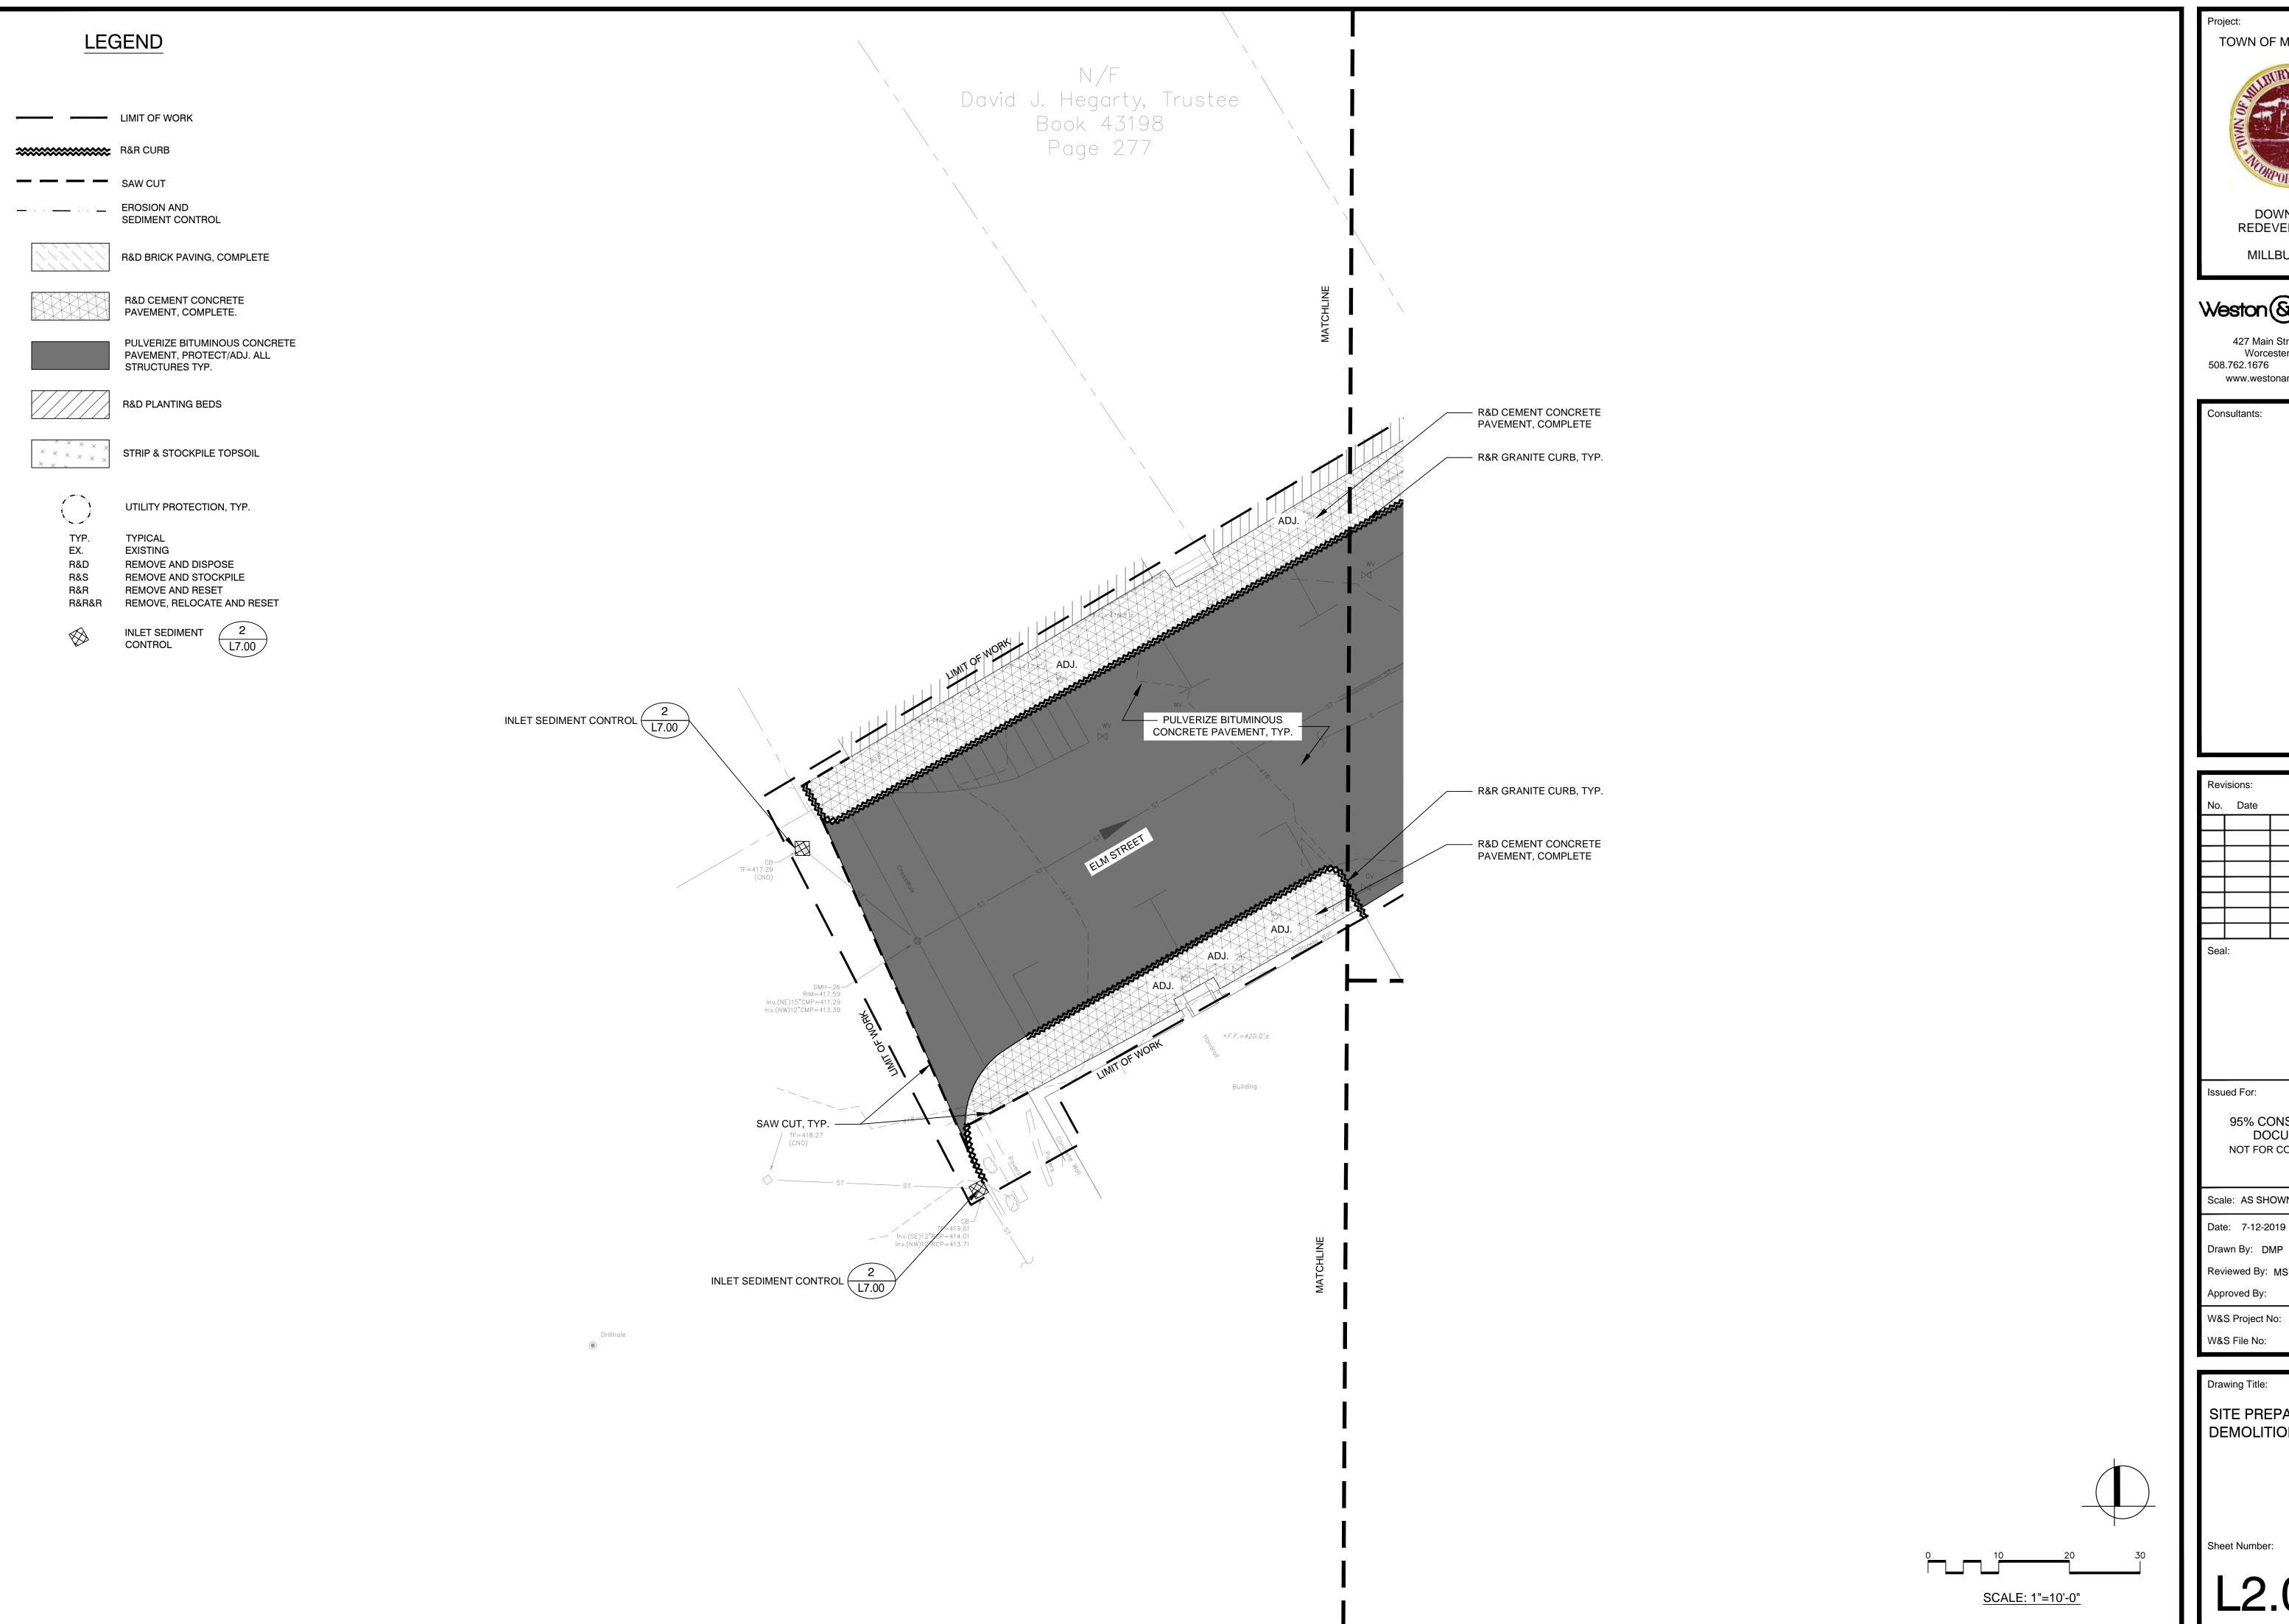
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SITE PREPARATION AND DEMOLITION PLAN

Sheet Number:

L2.03



DOWNTOWN REDEVELOPMENT

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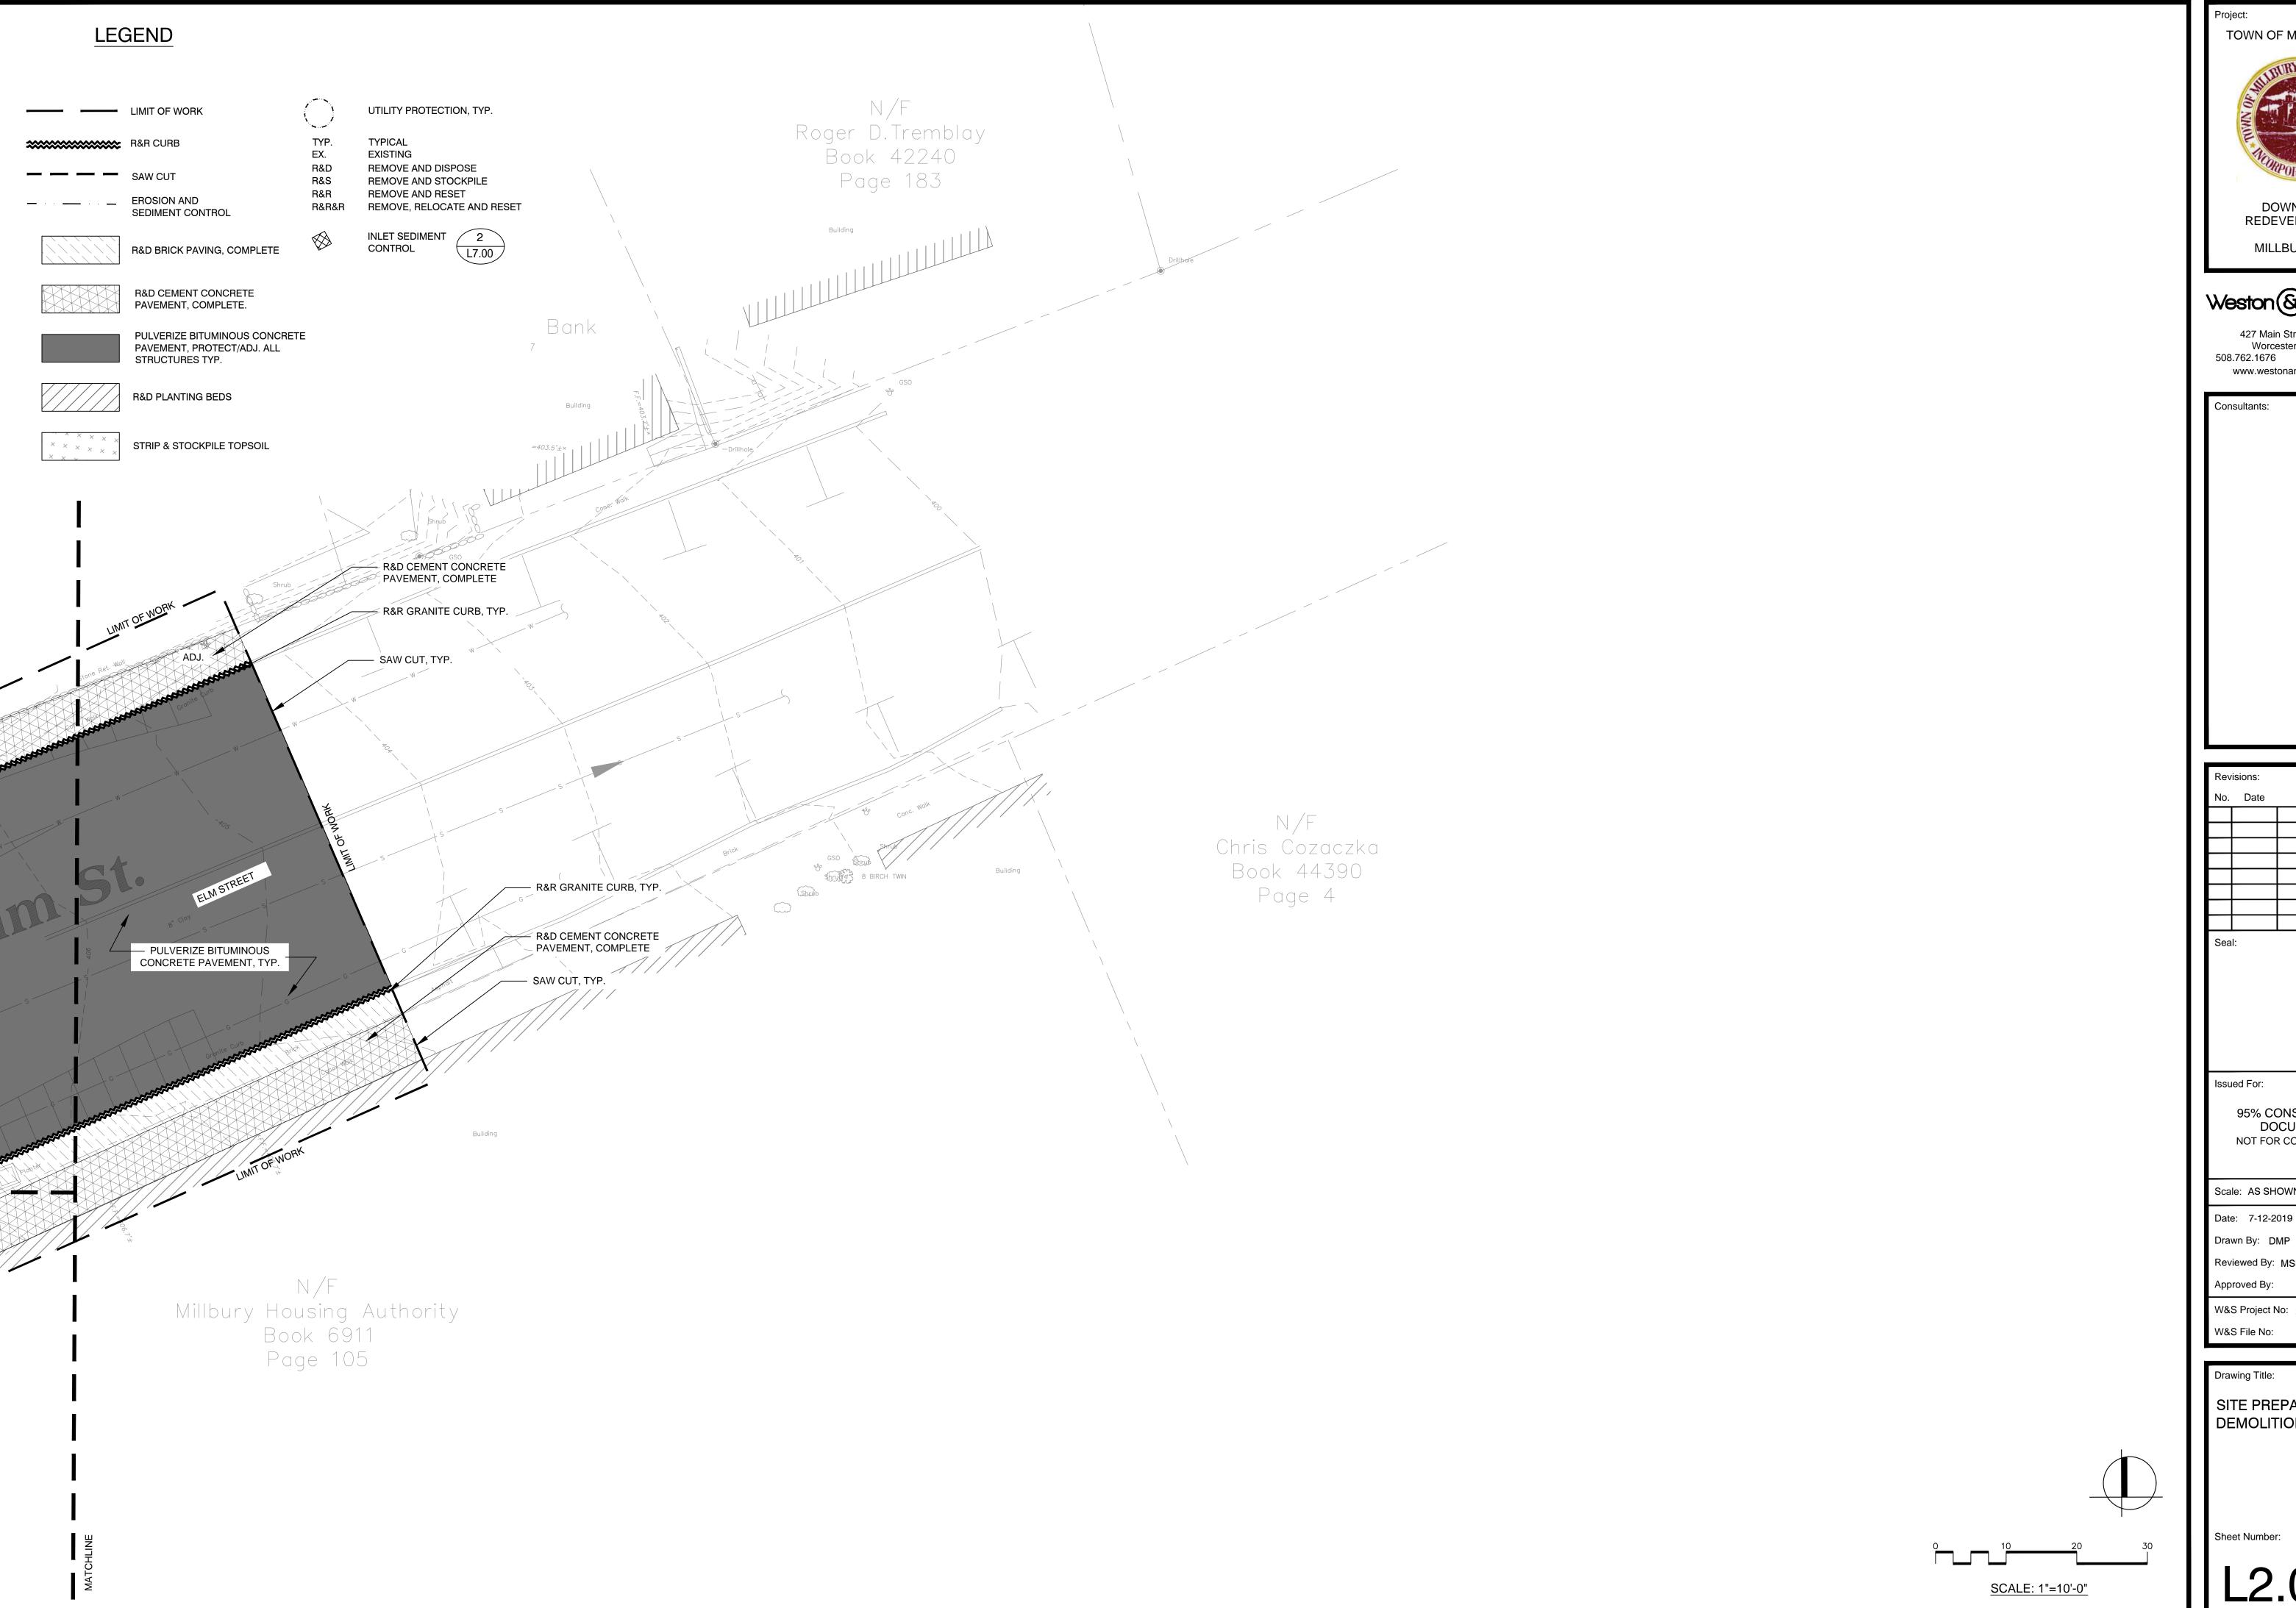
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Drawing Title:

SITE PREPARATION AND DEMOLITION PLAN

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TOWN OF MILLBURY, MA DOWNTOWN REDEVELOPMENT

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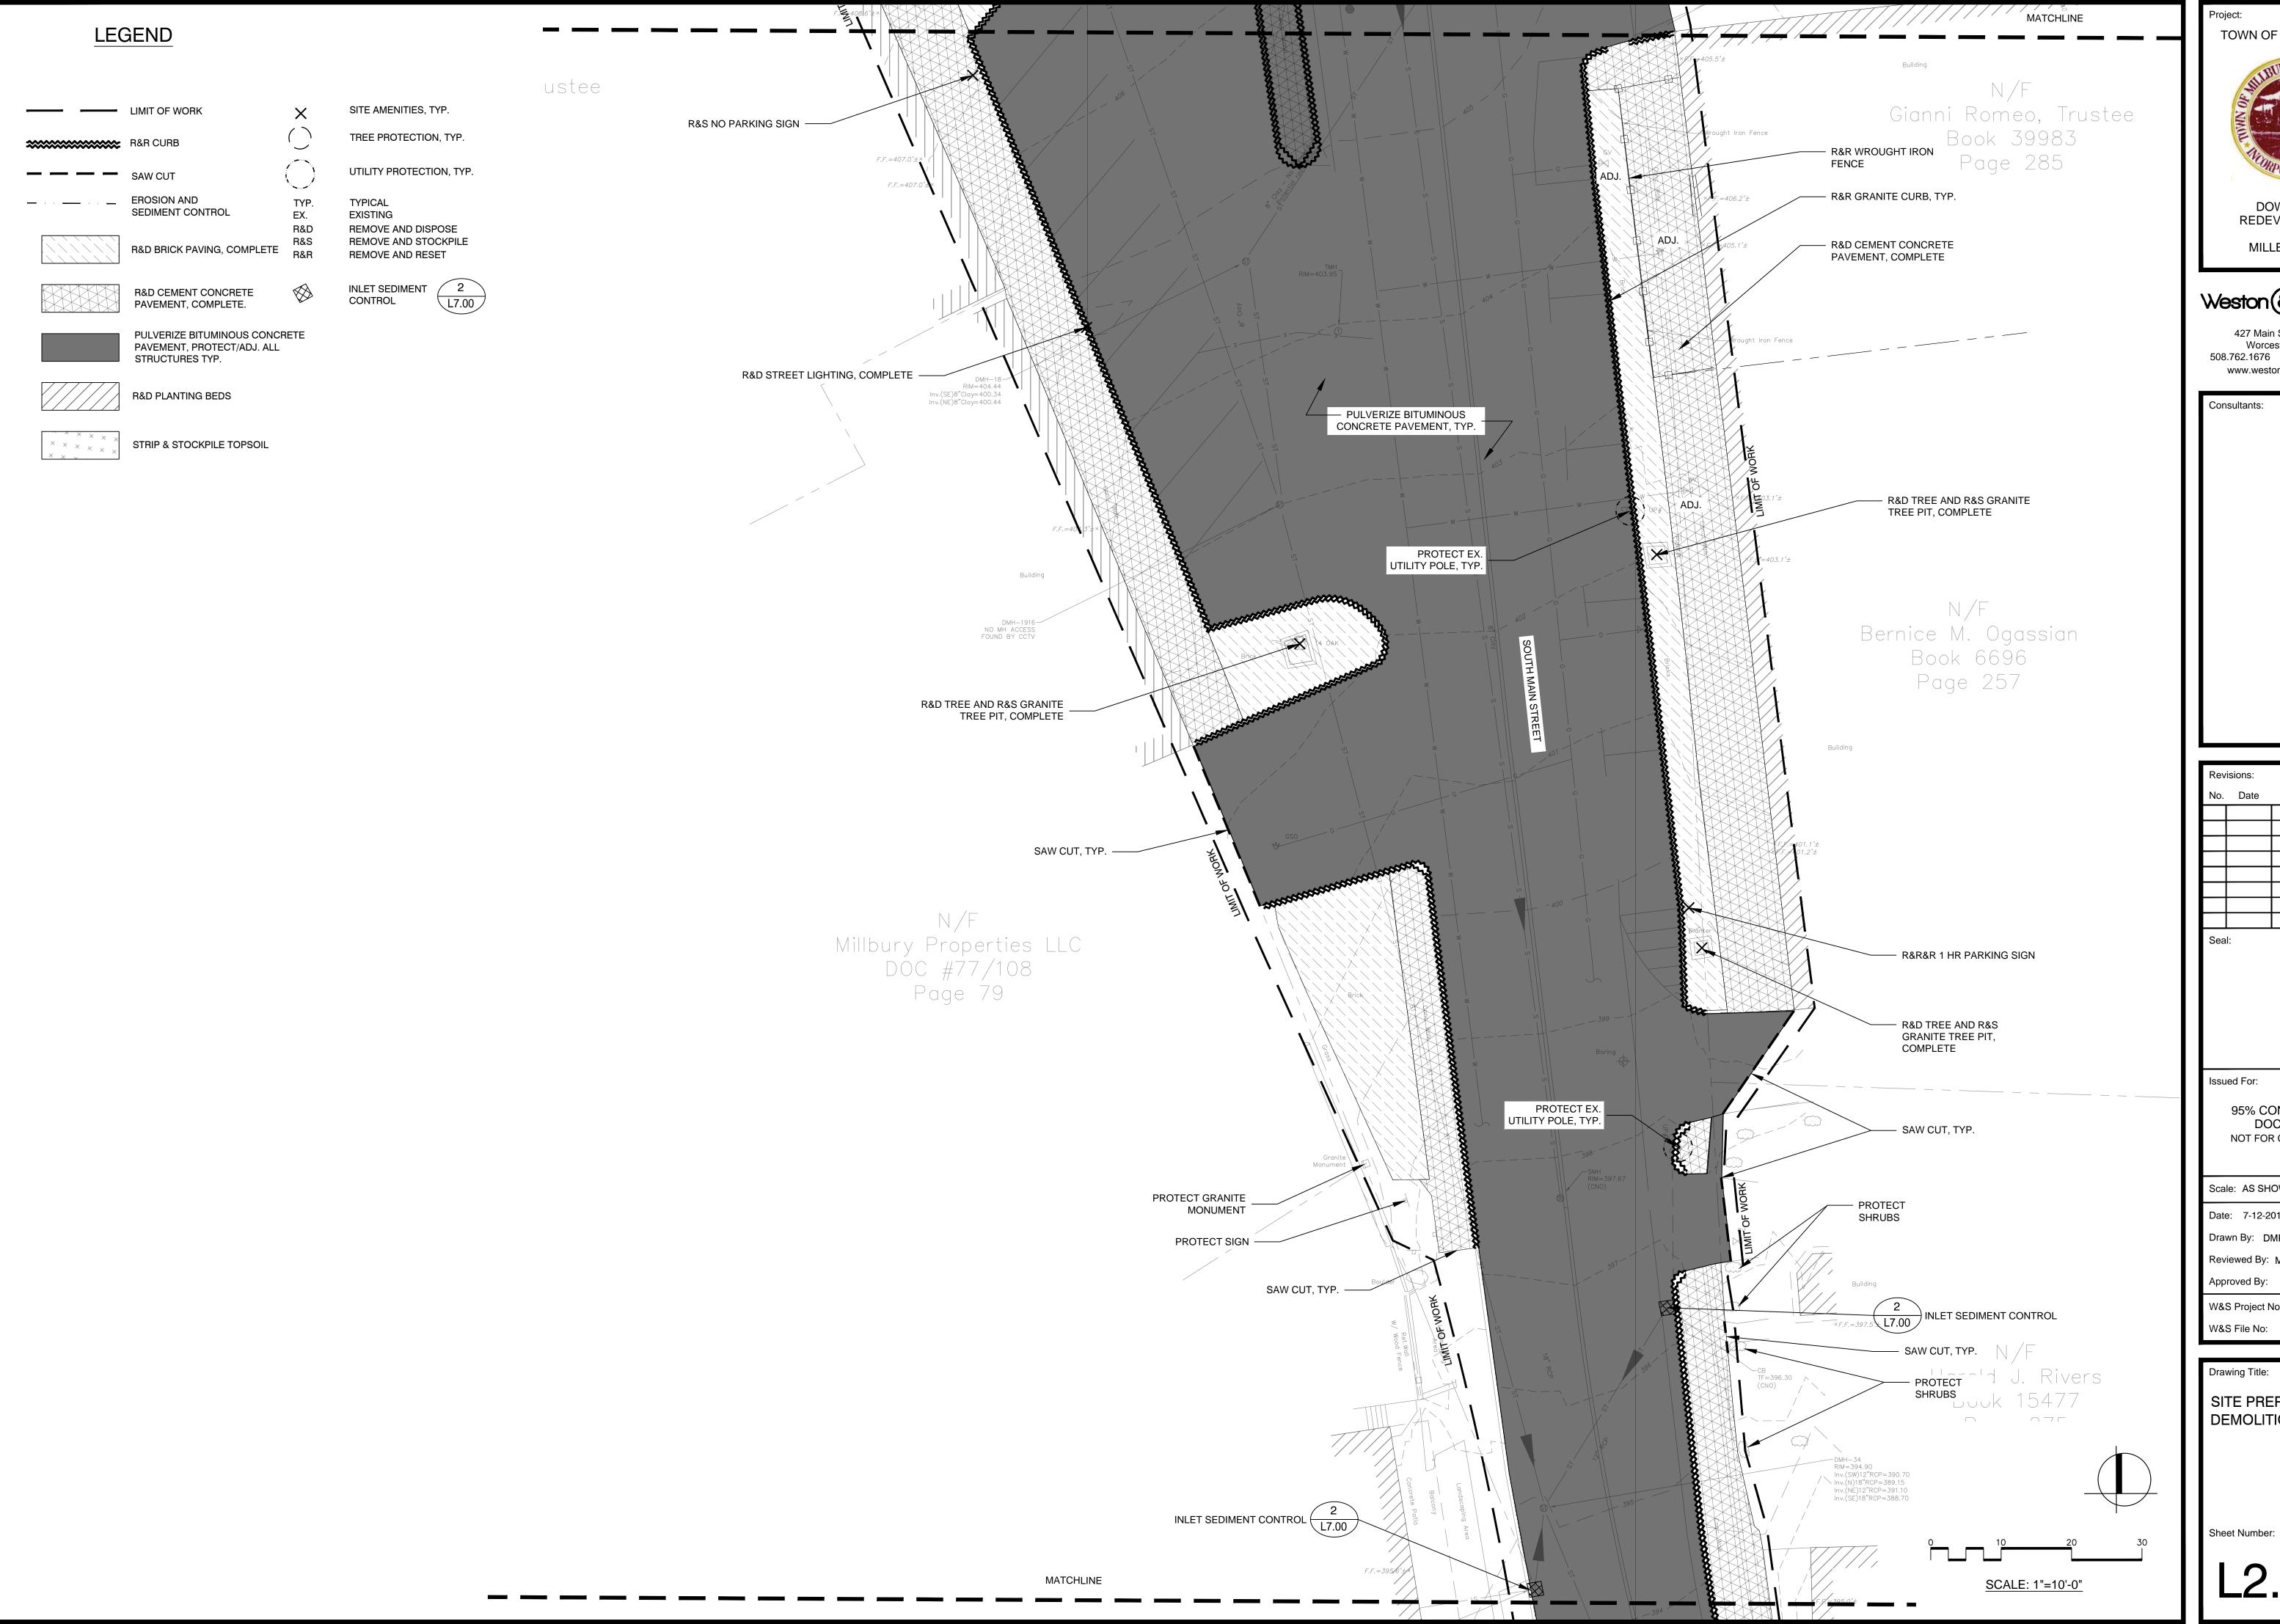
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Drawing Title:

SITE PREPARATION AND DEMOLITION PLAN

Sheet Number:

L2.05



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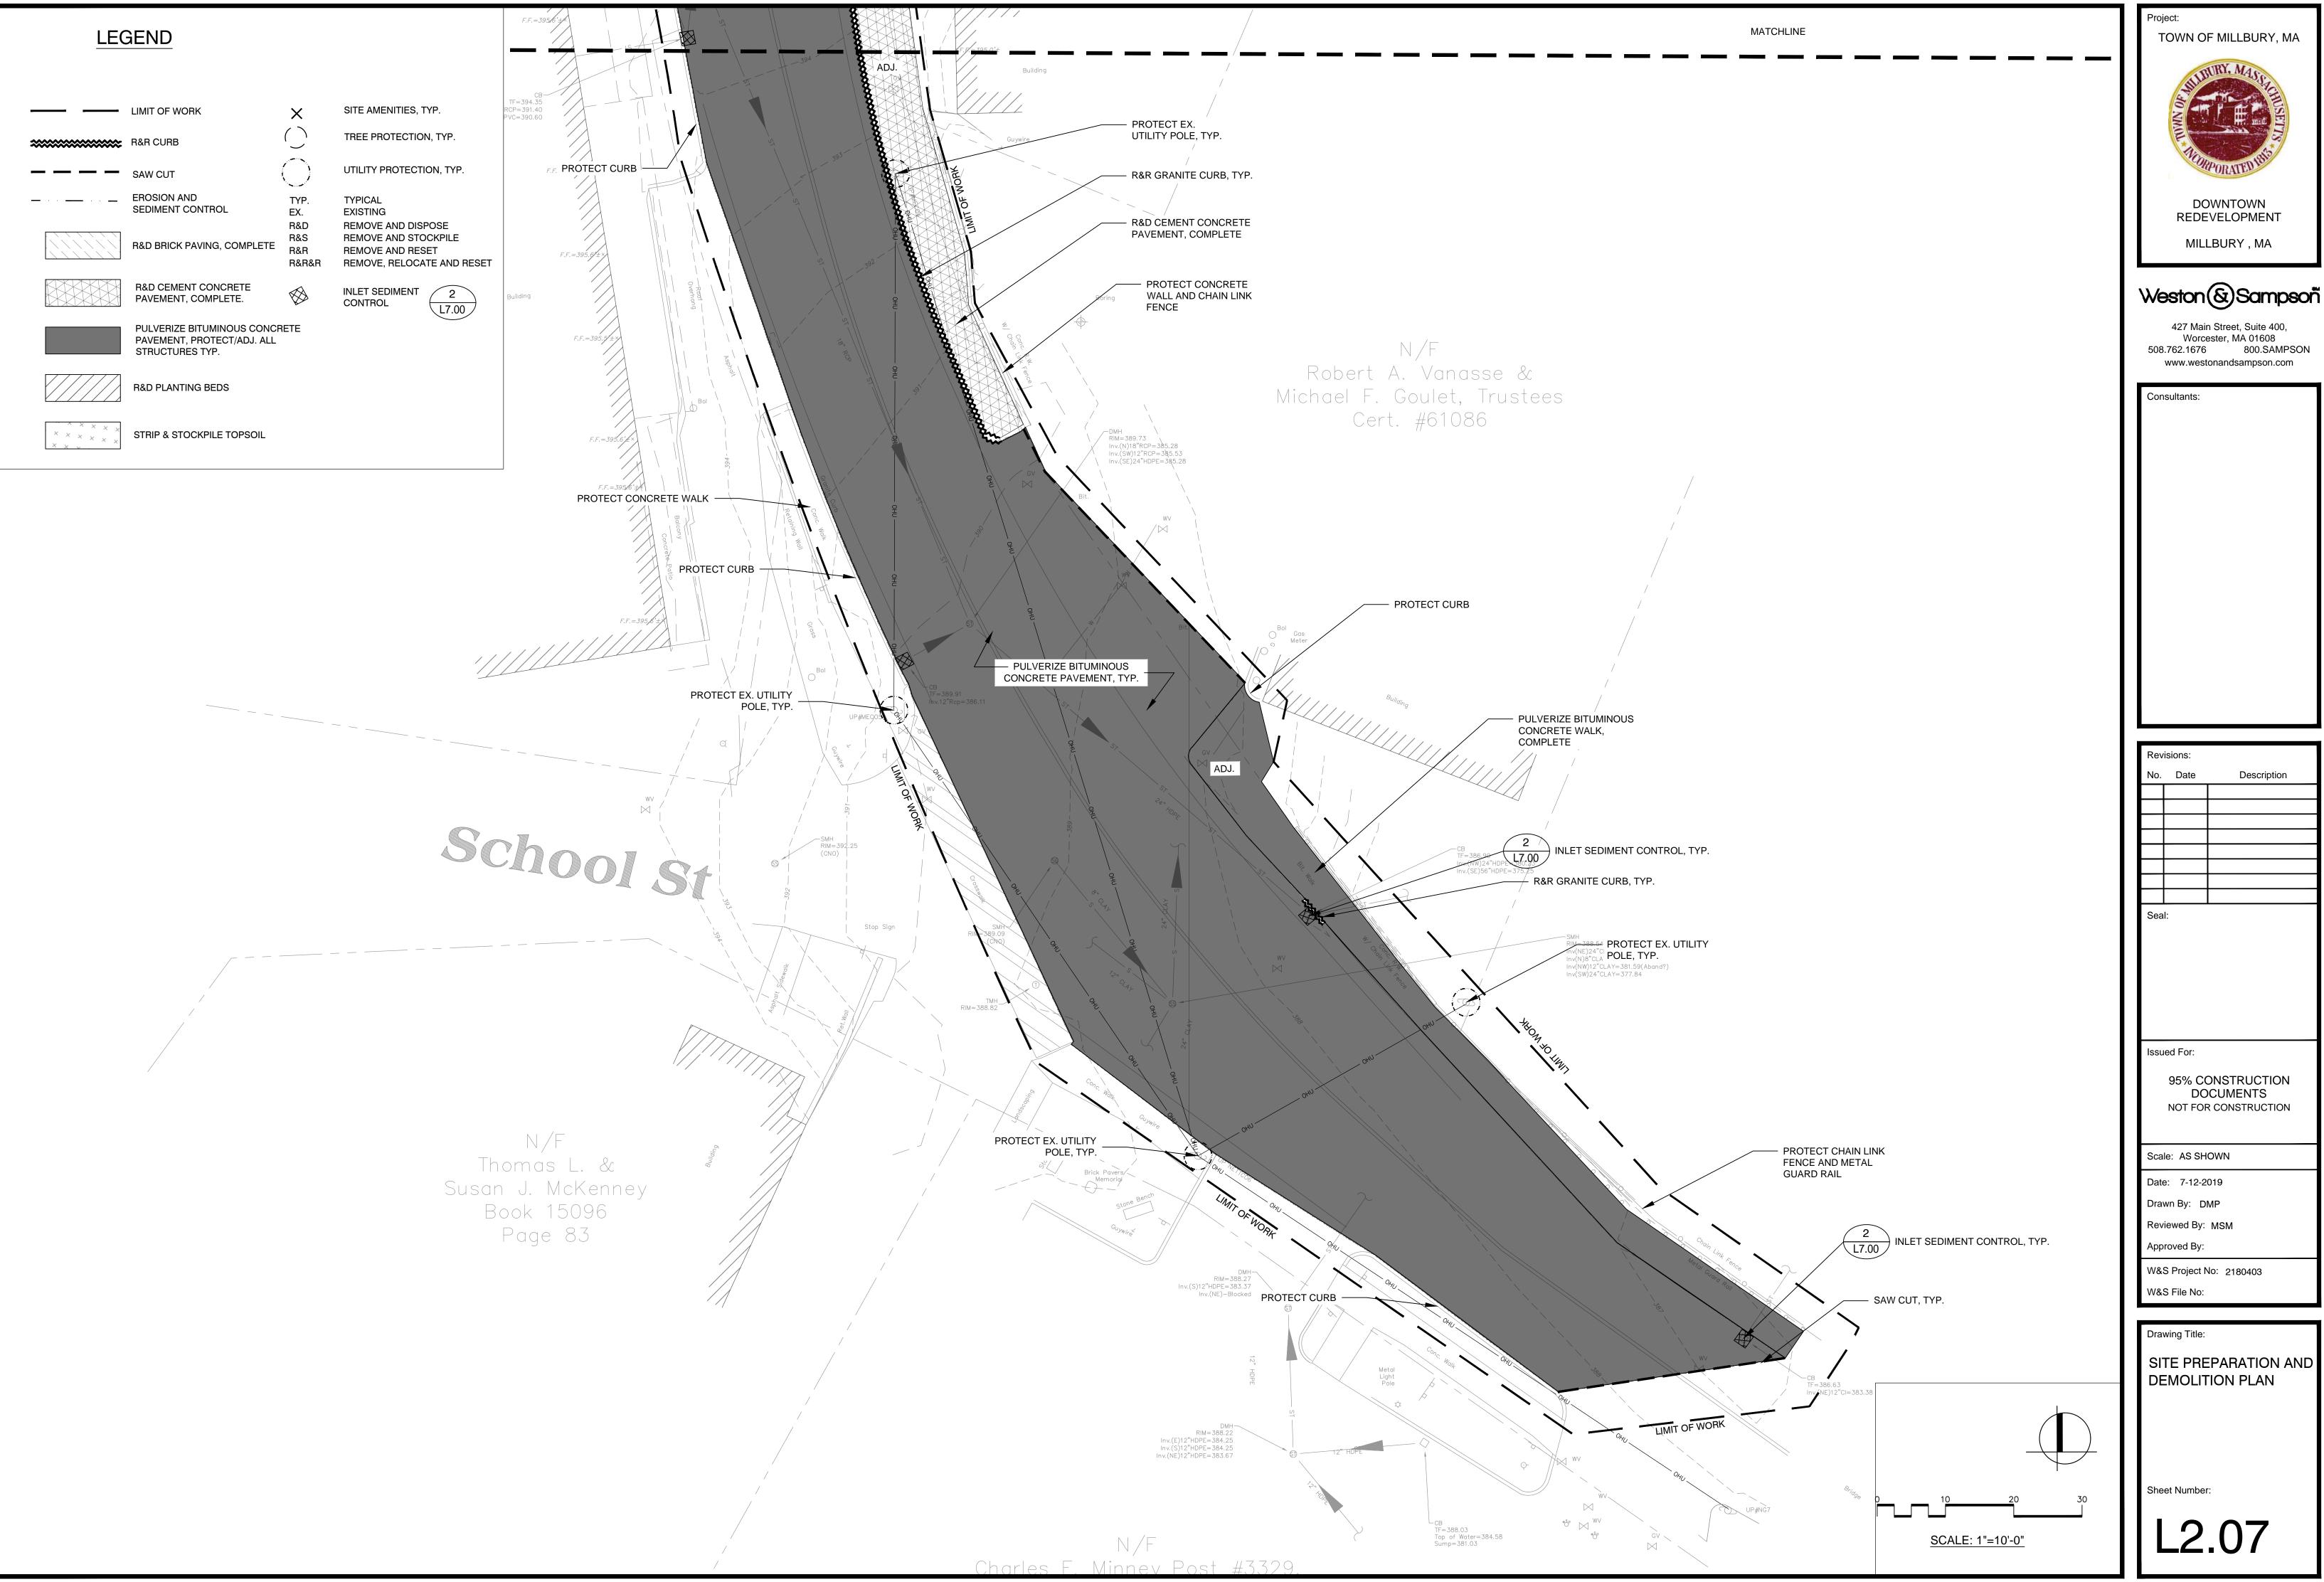
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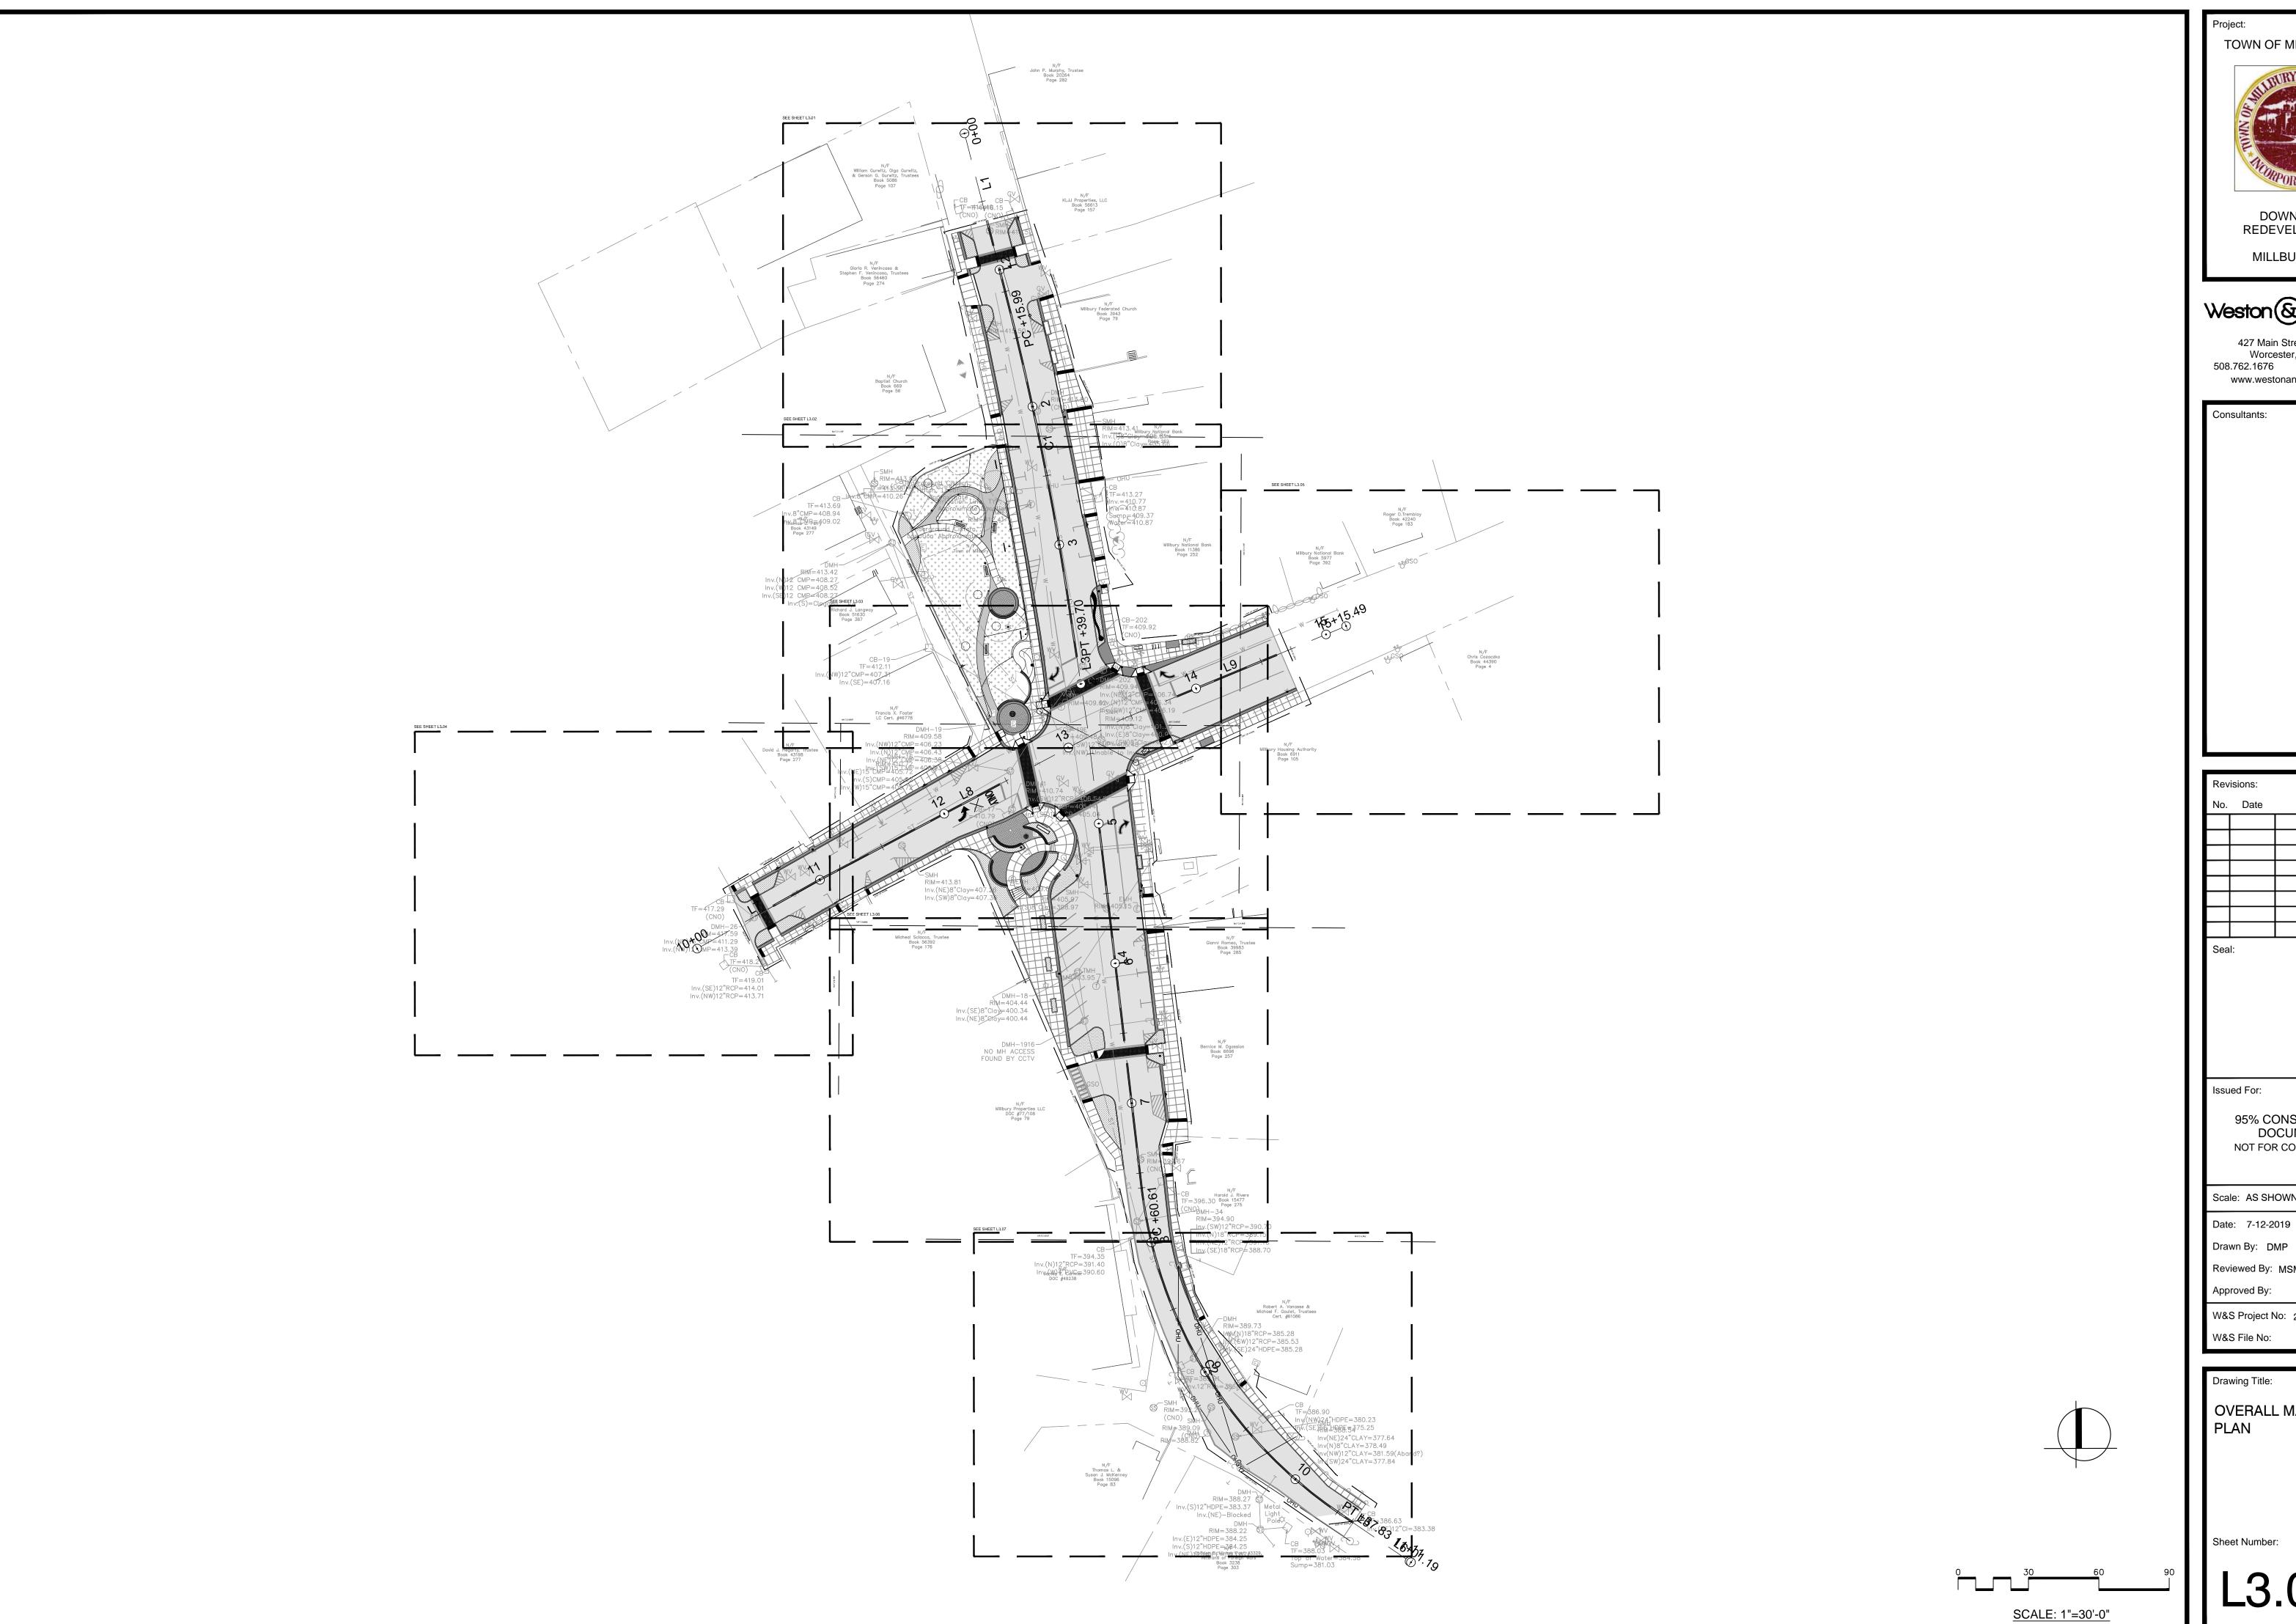
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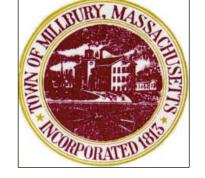
Drawing Title:

SITE PREPARATION AND DEMOLITION PLAN

L2.06







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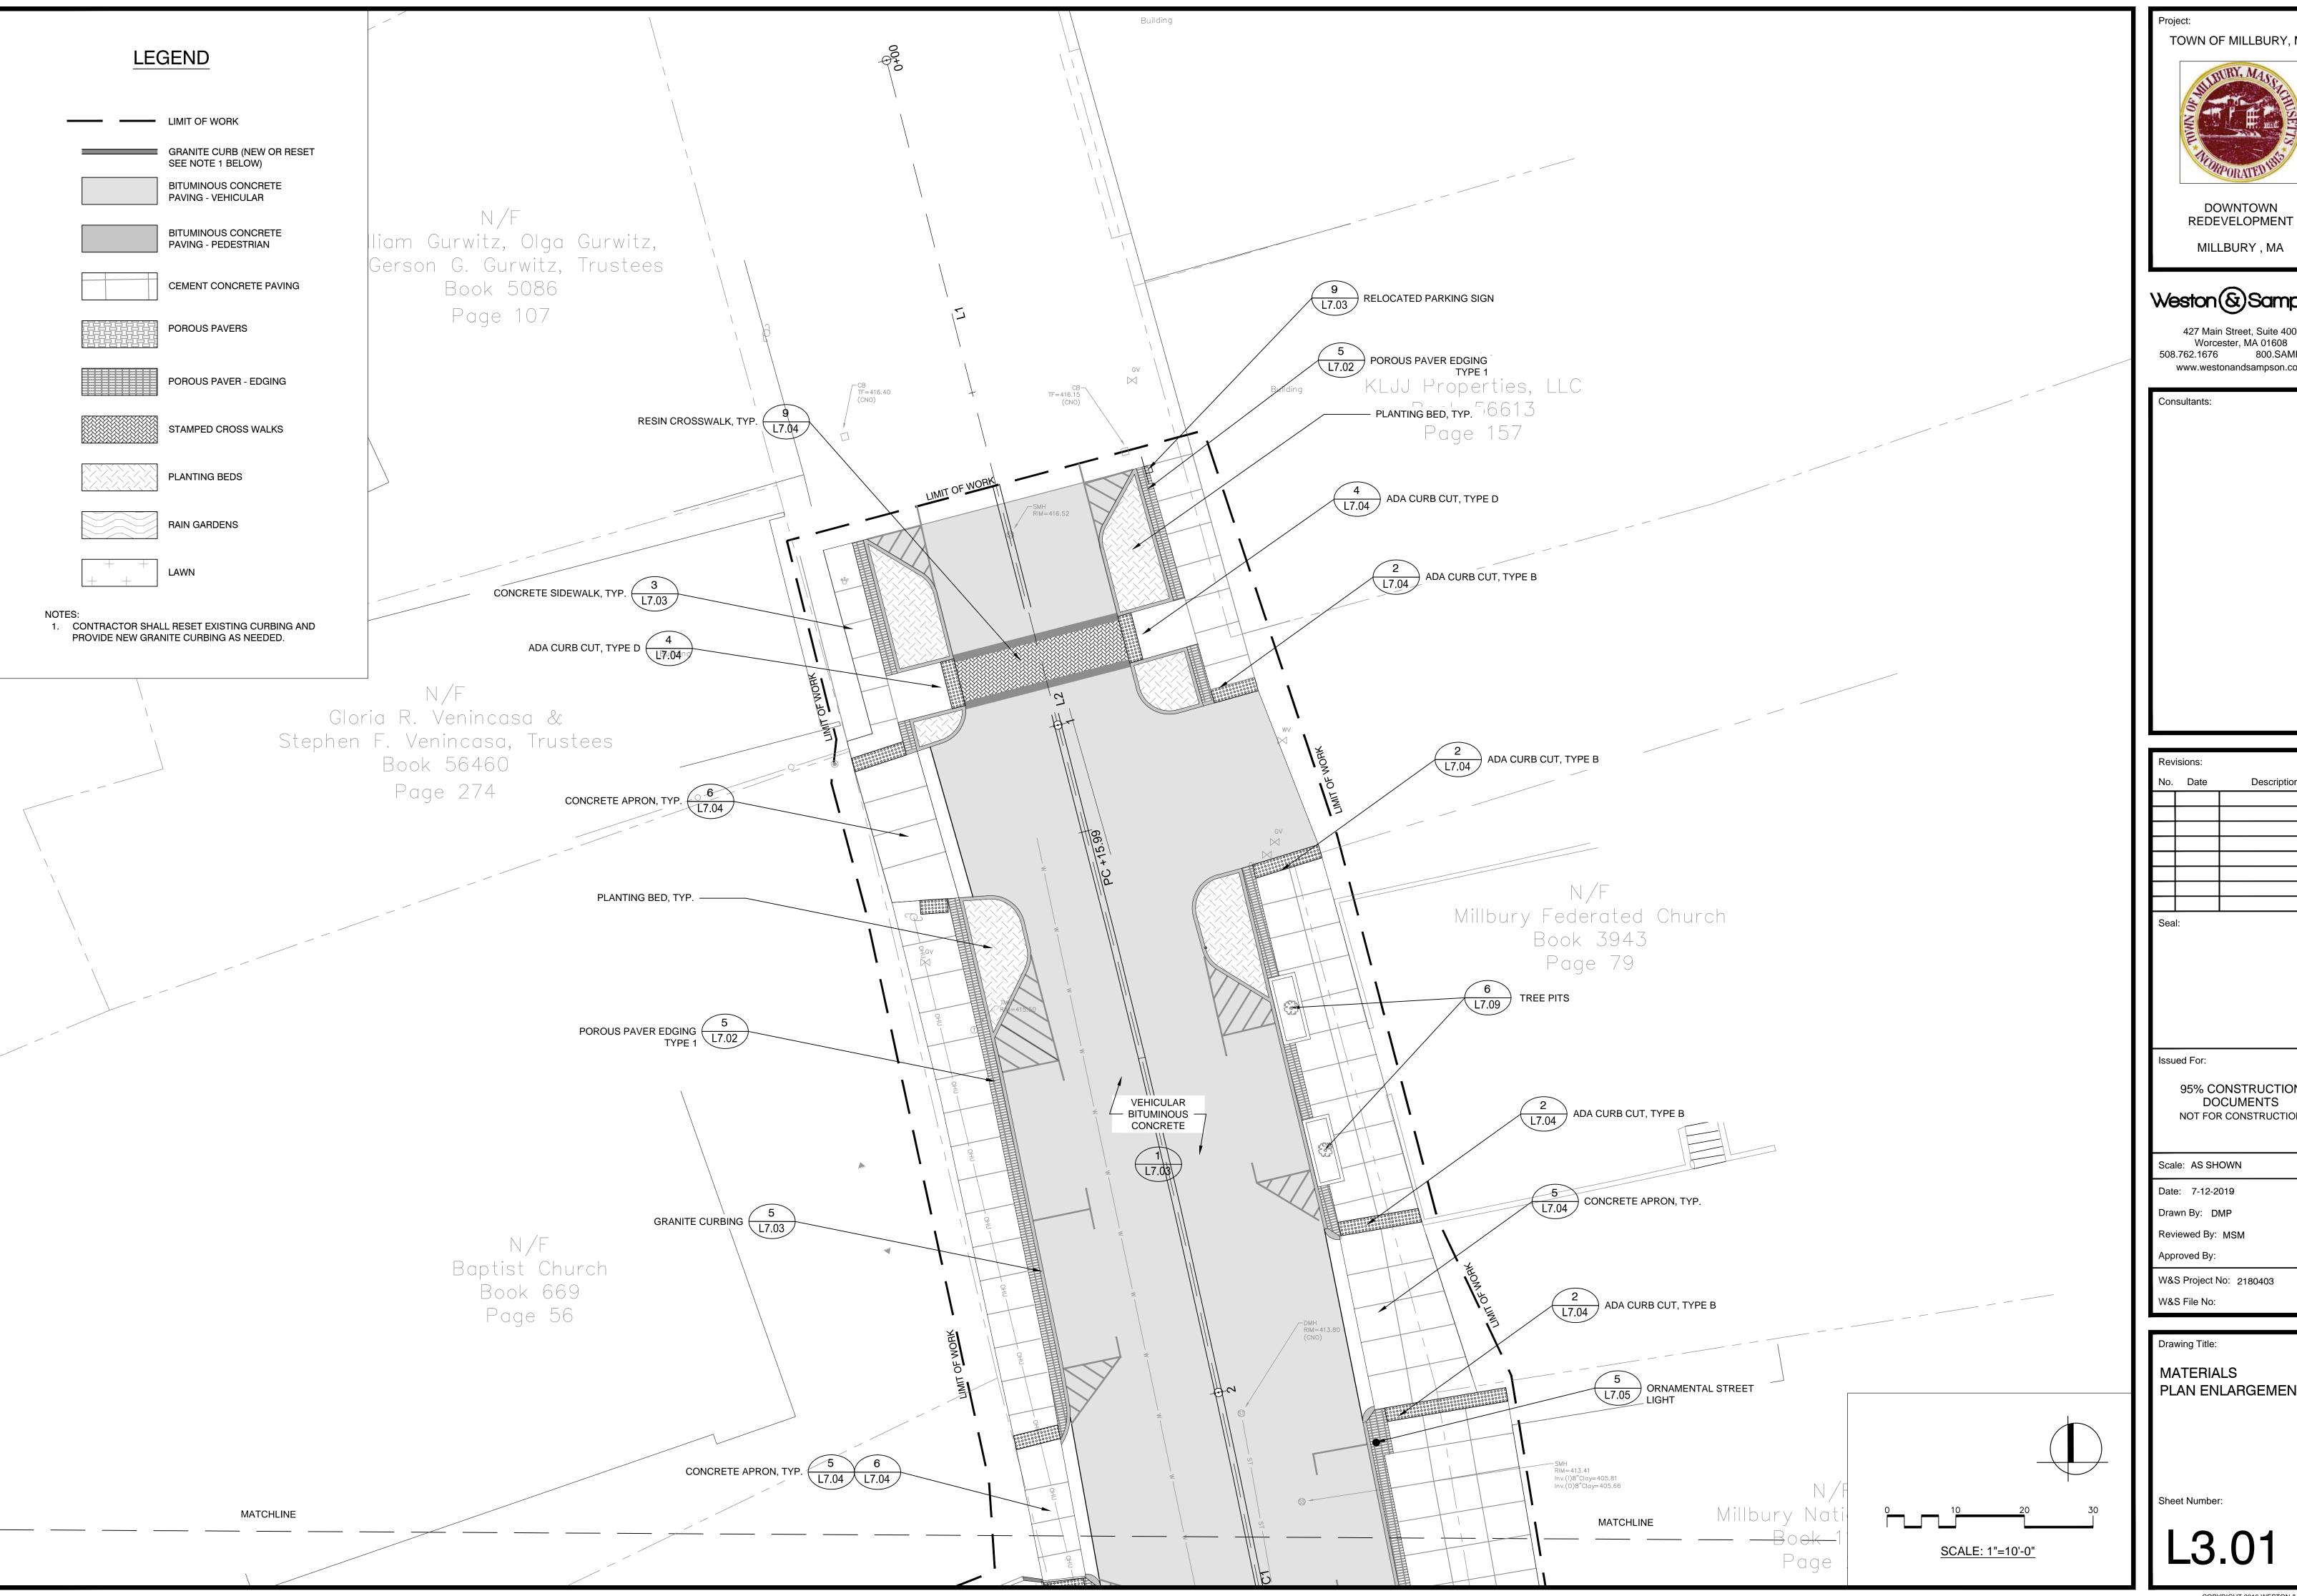
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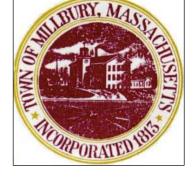
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OVERALL MATERIALS PLAN

Sheet Number:





MILLBURY, MA

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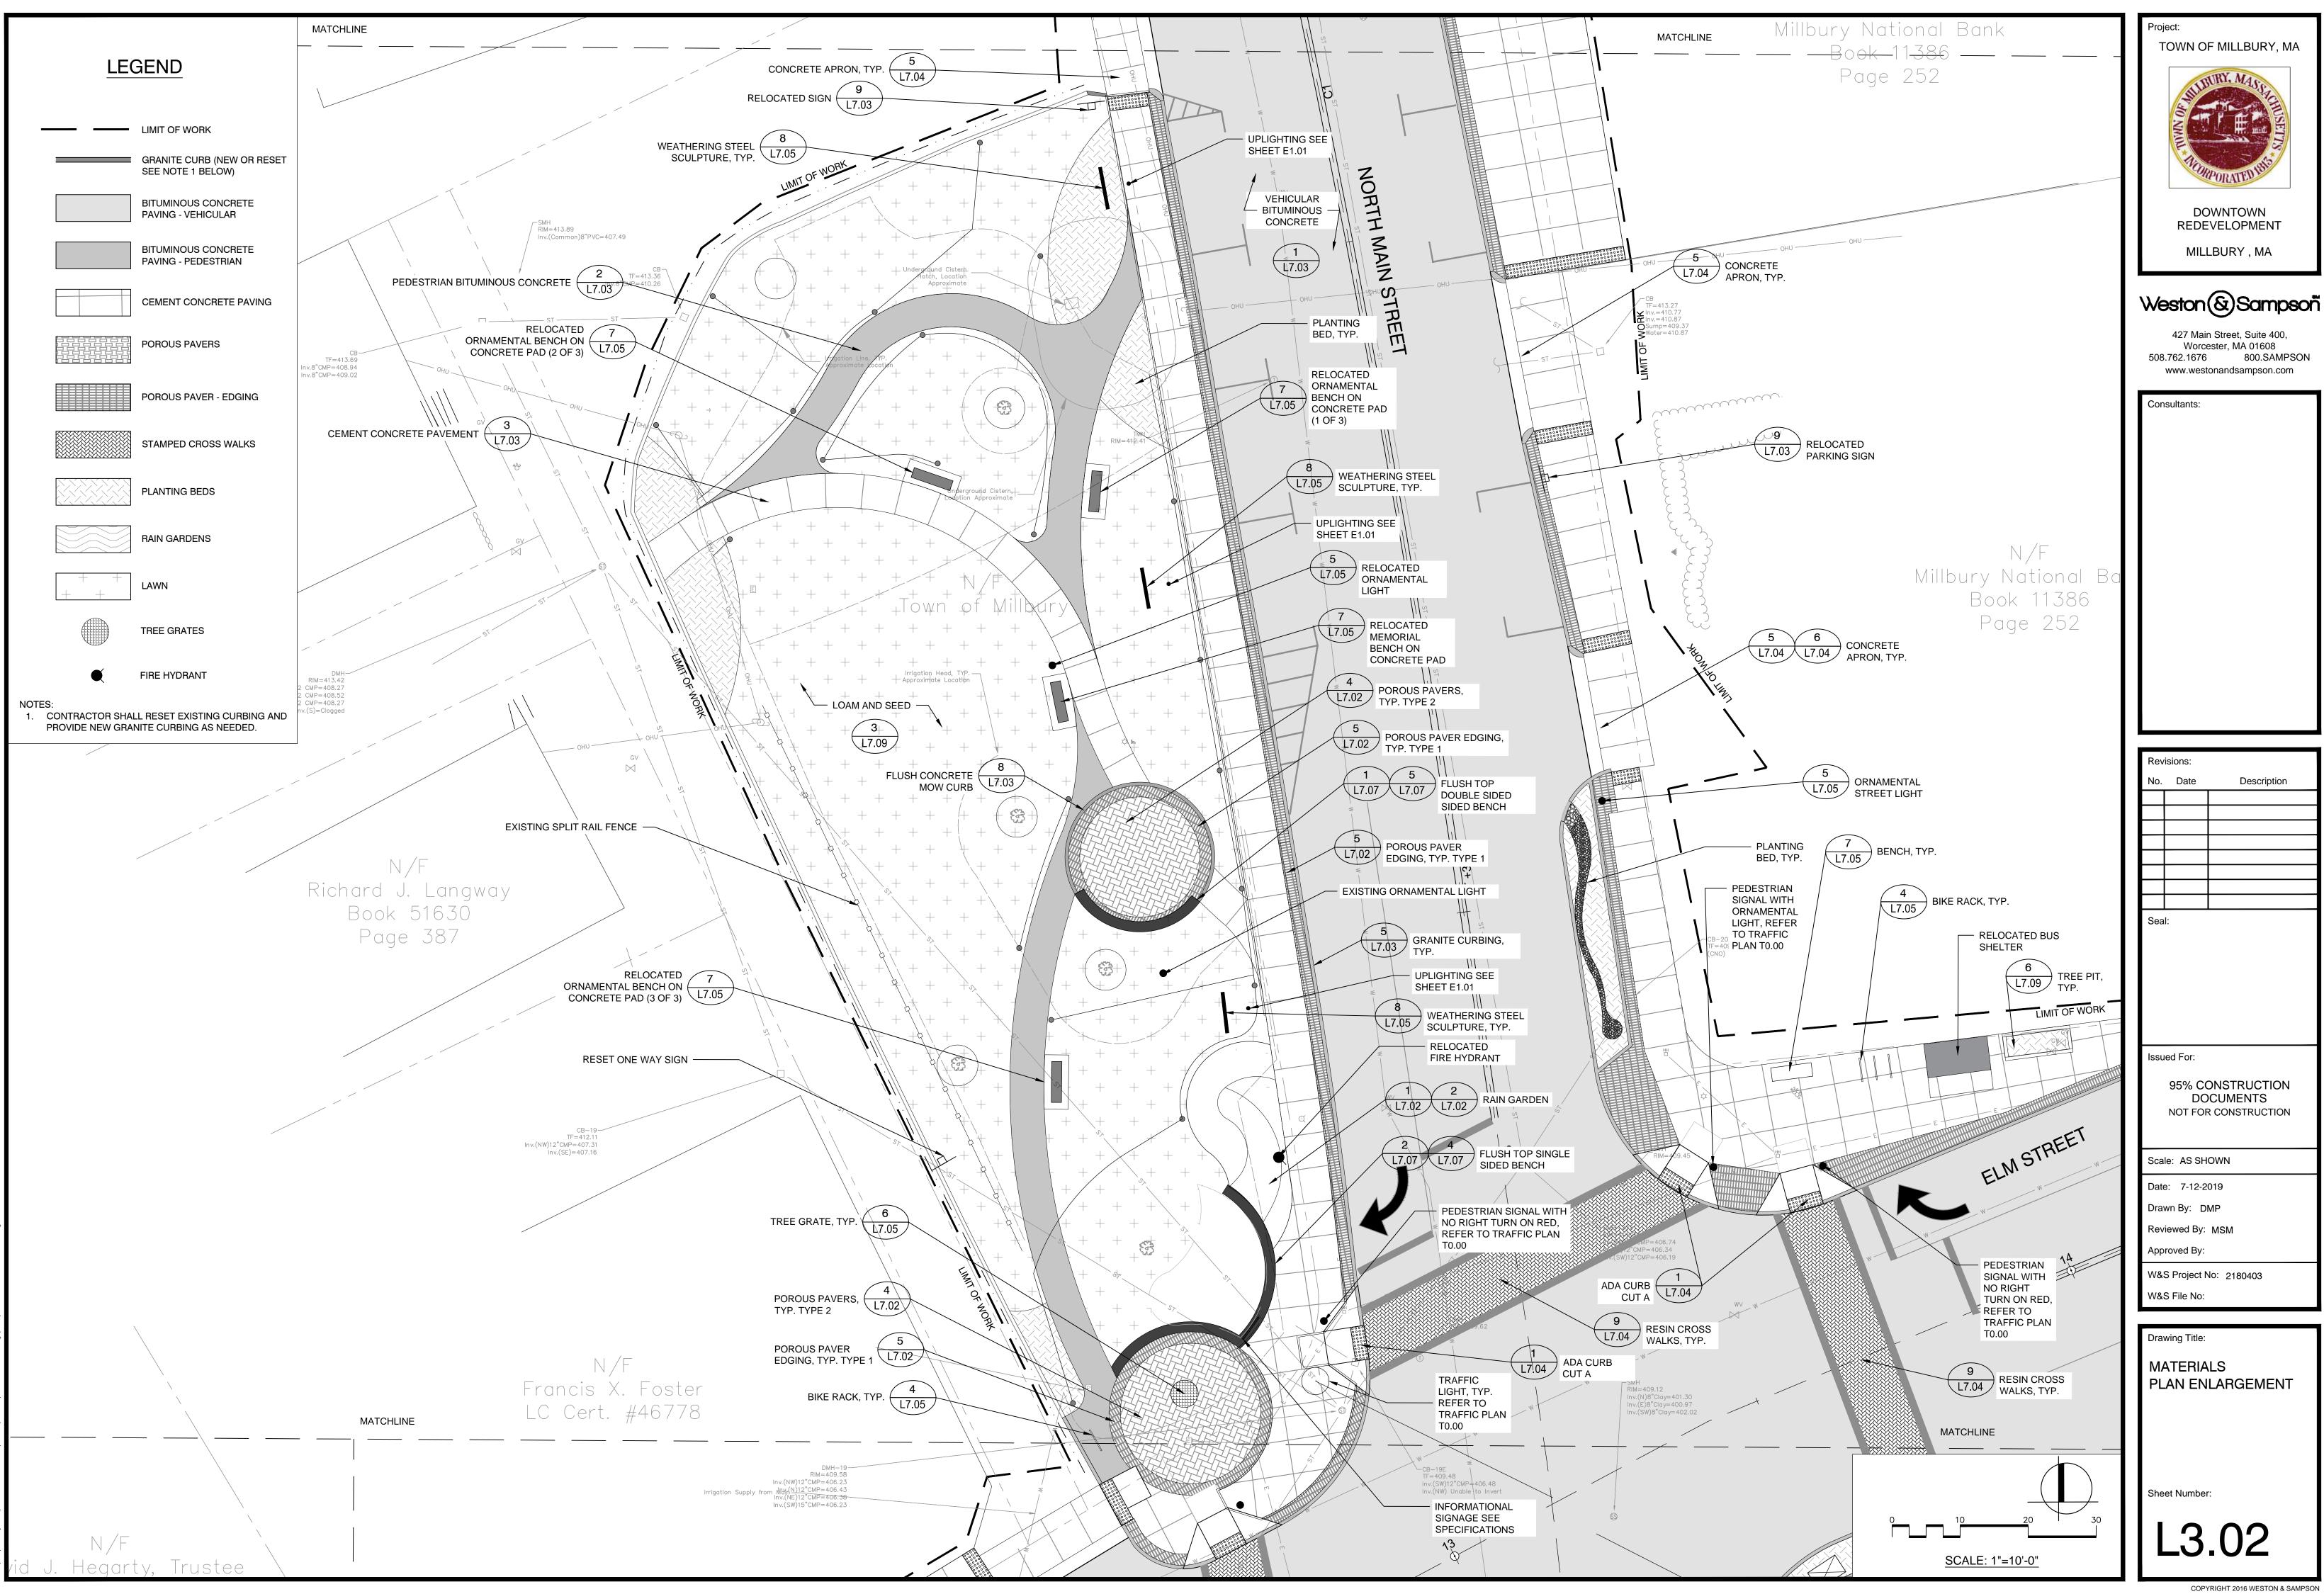
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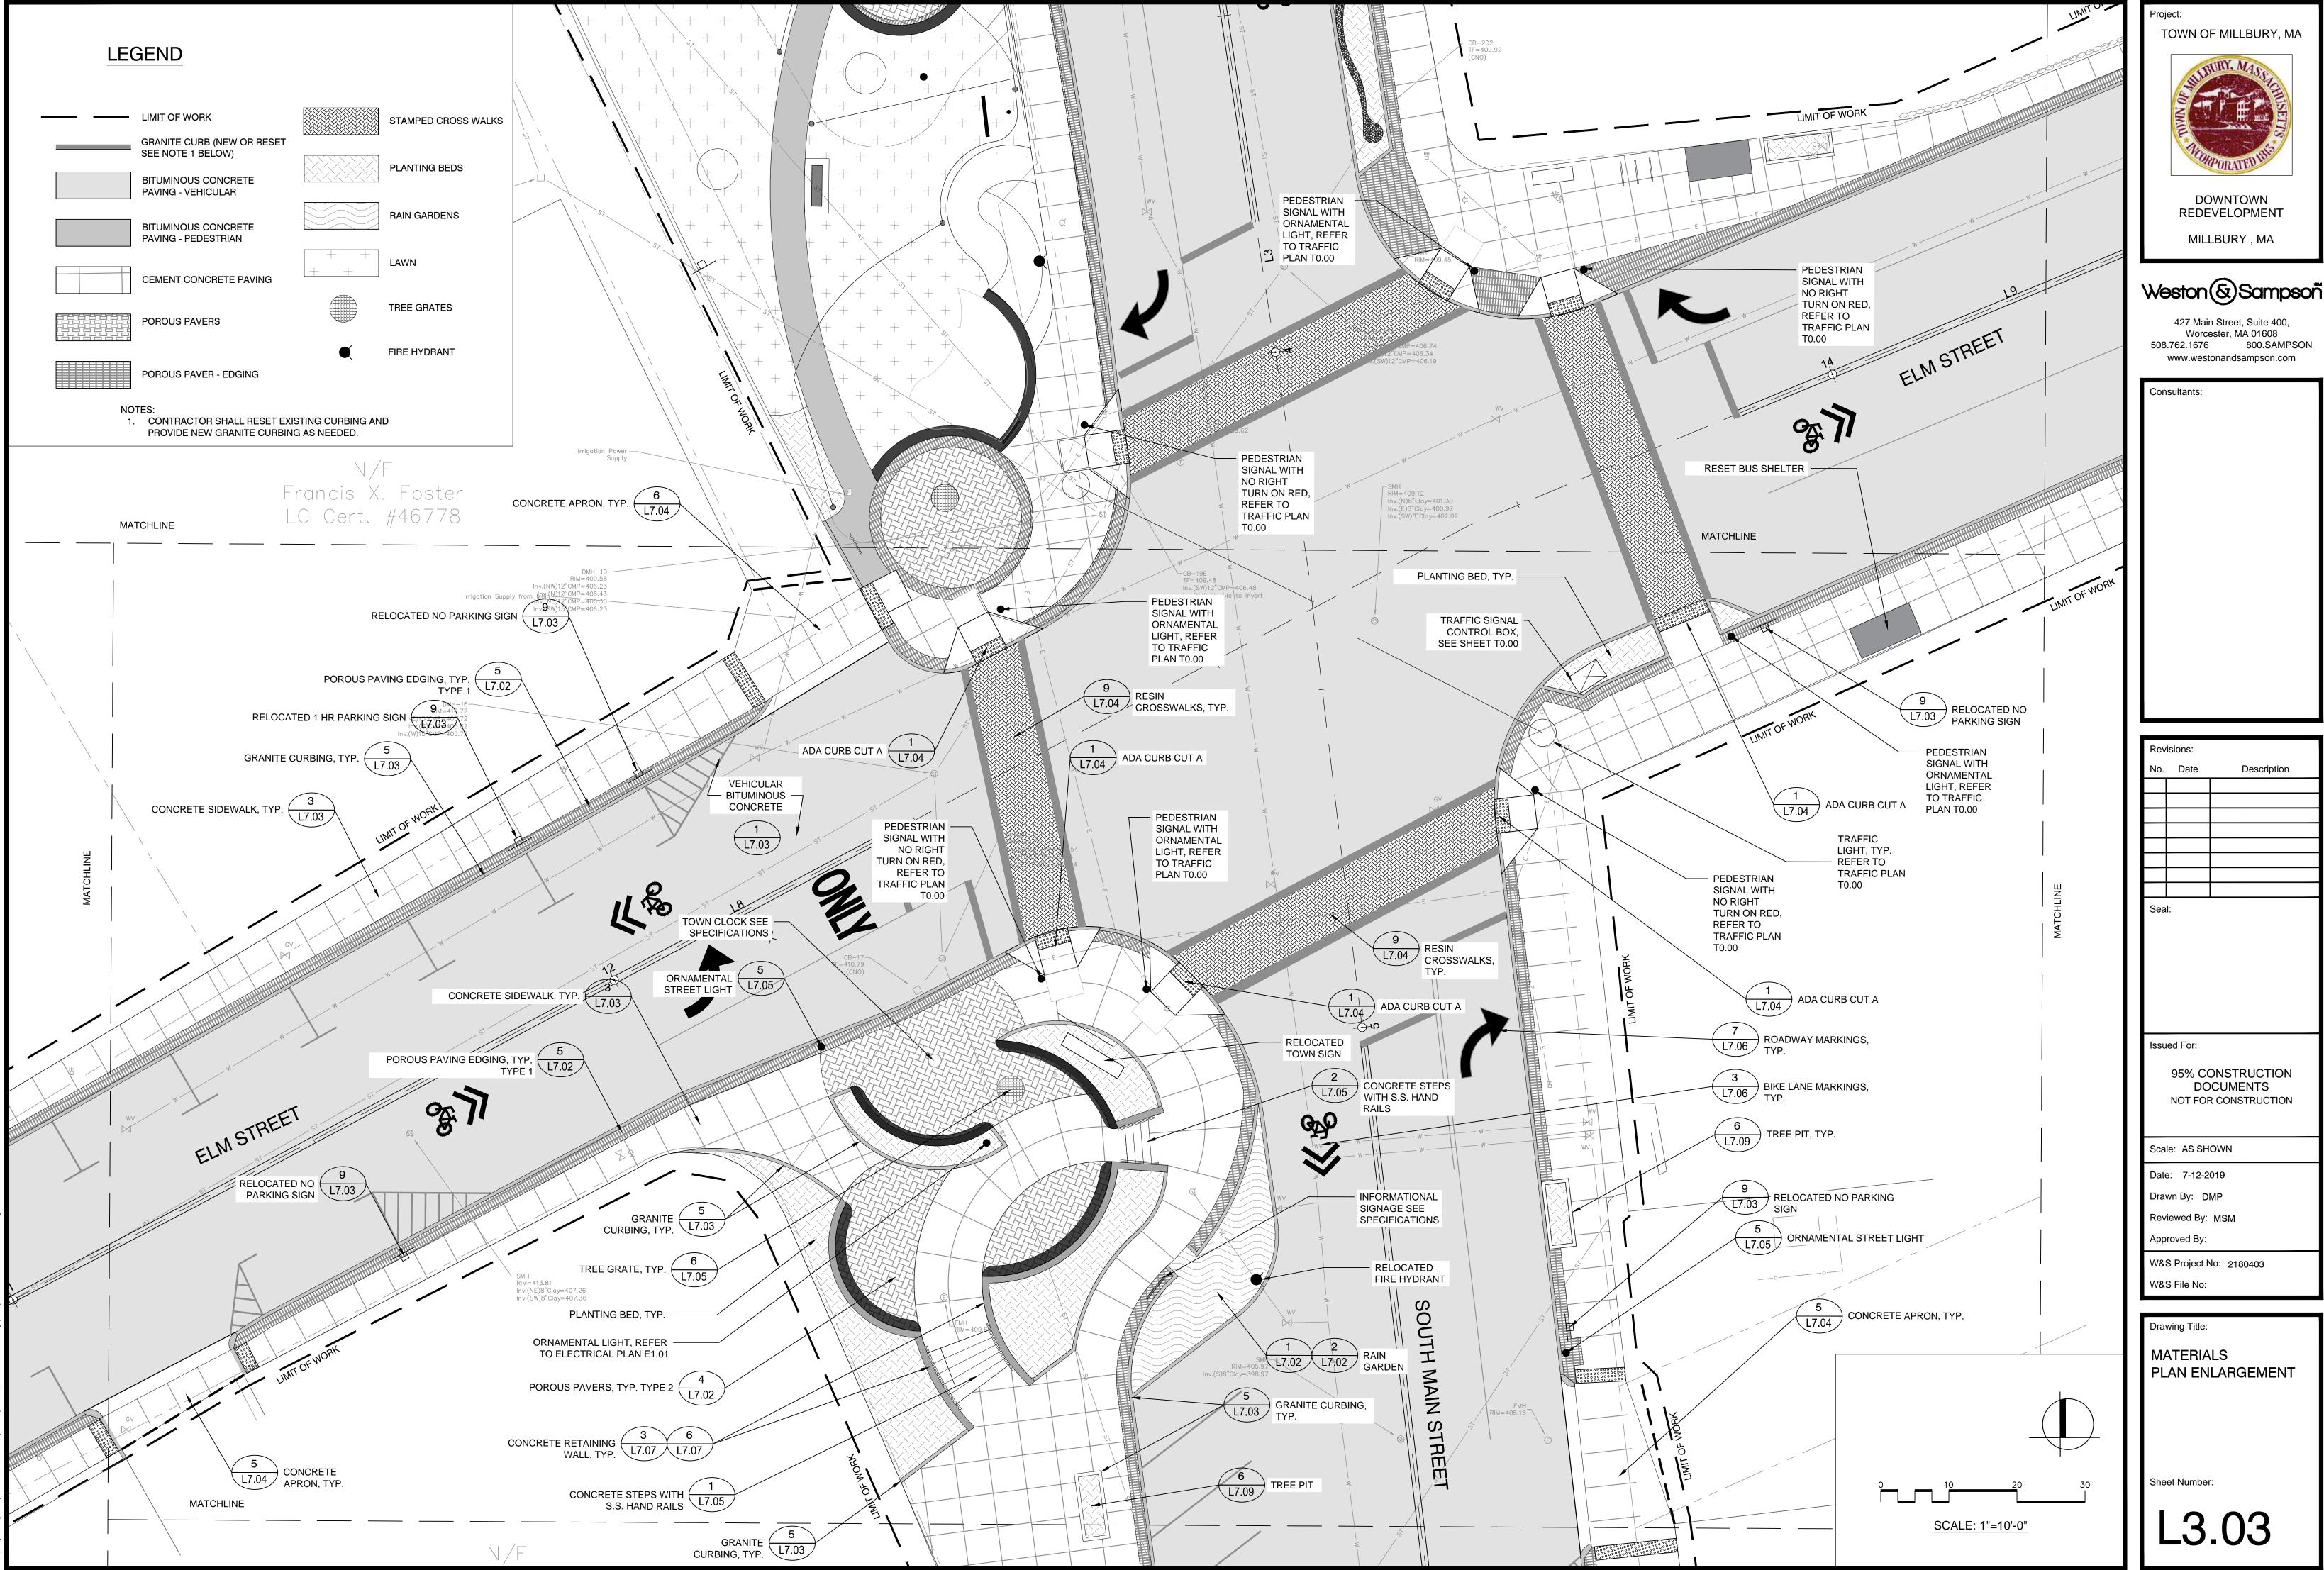
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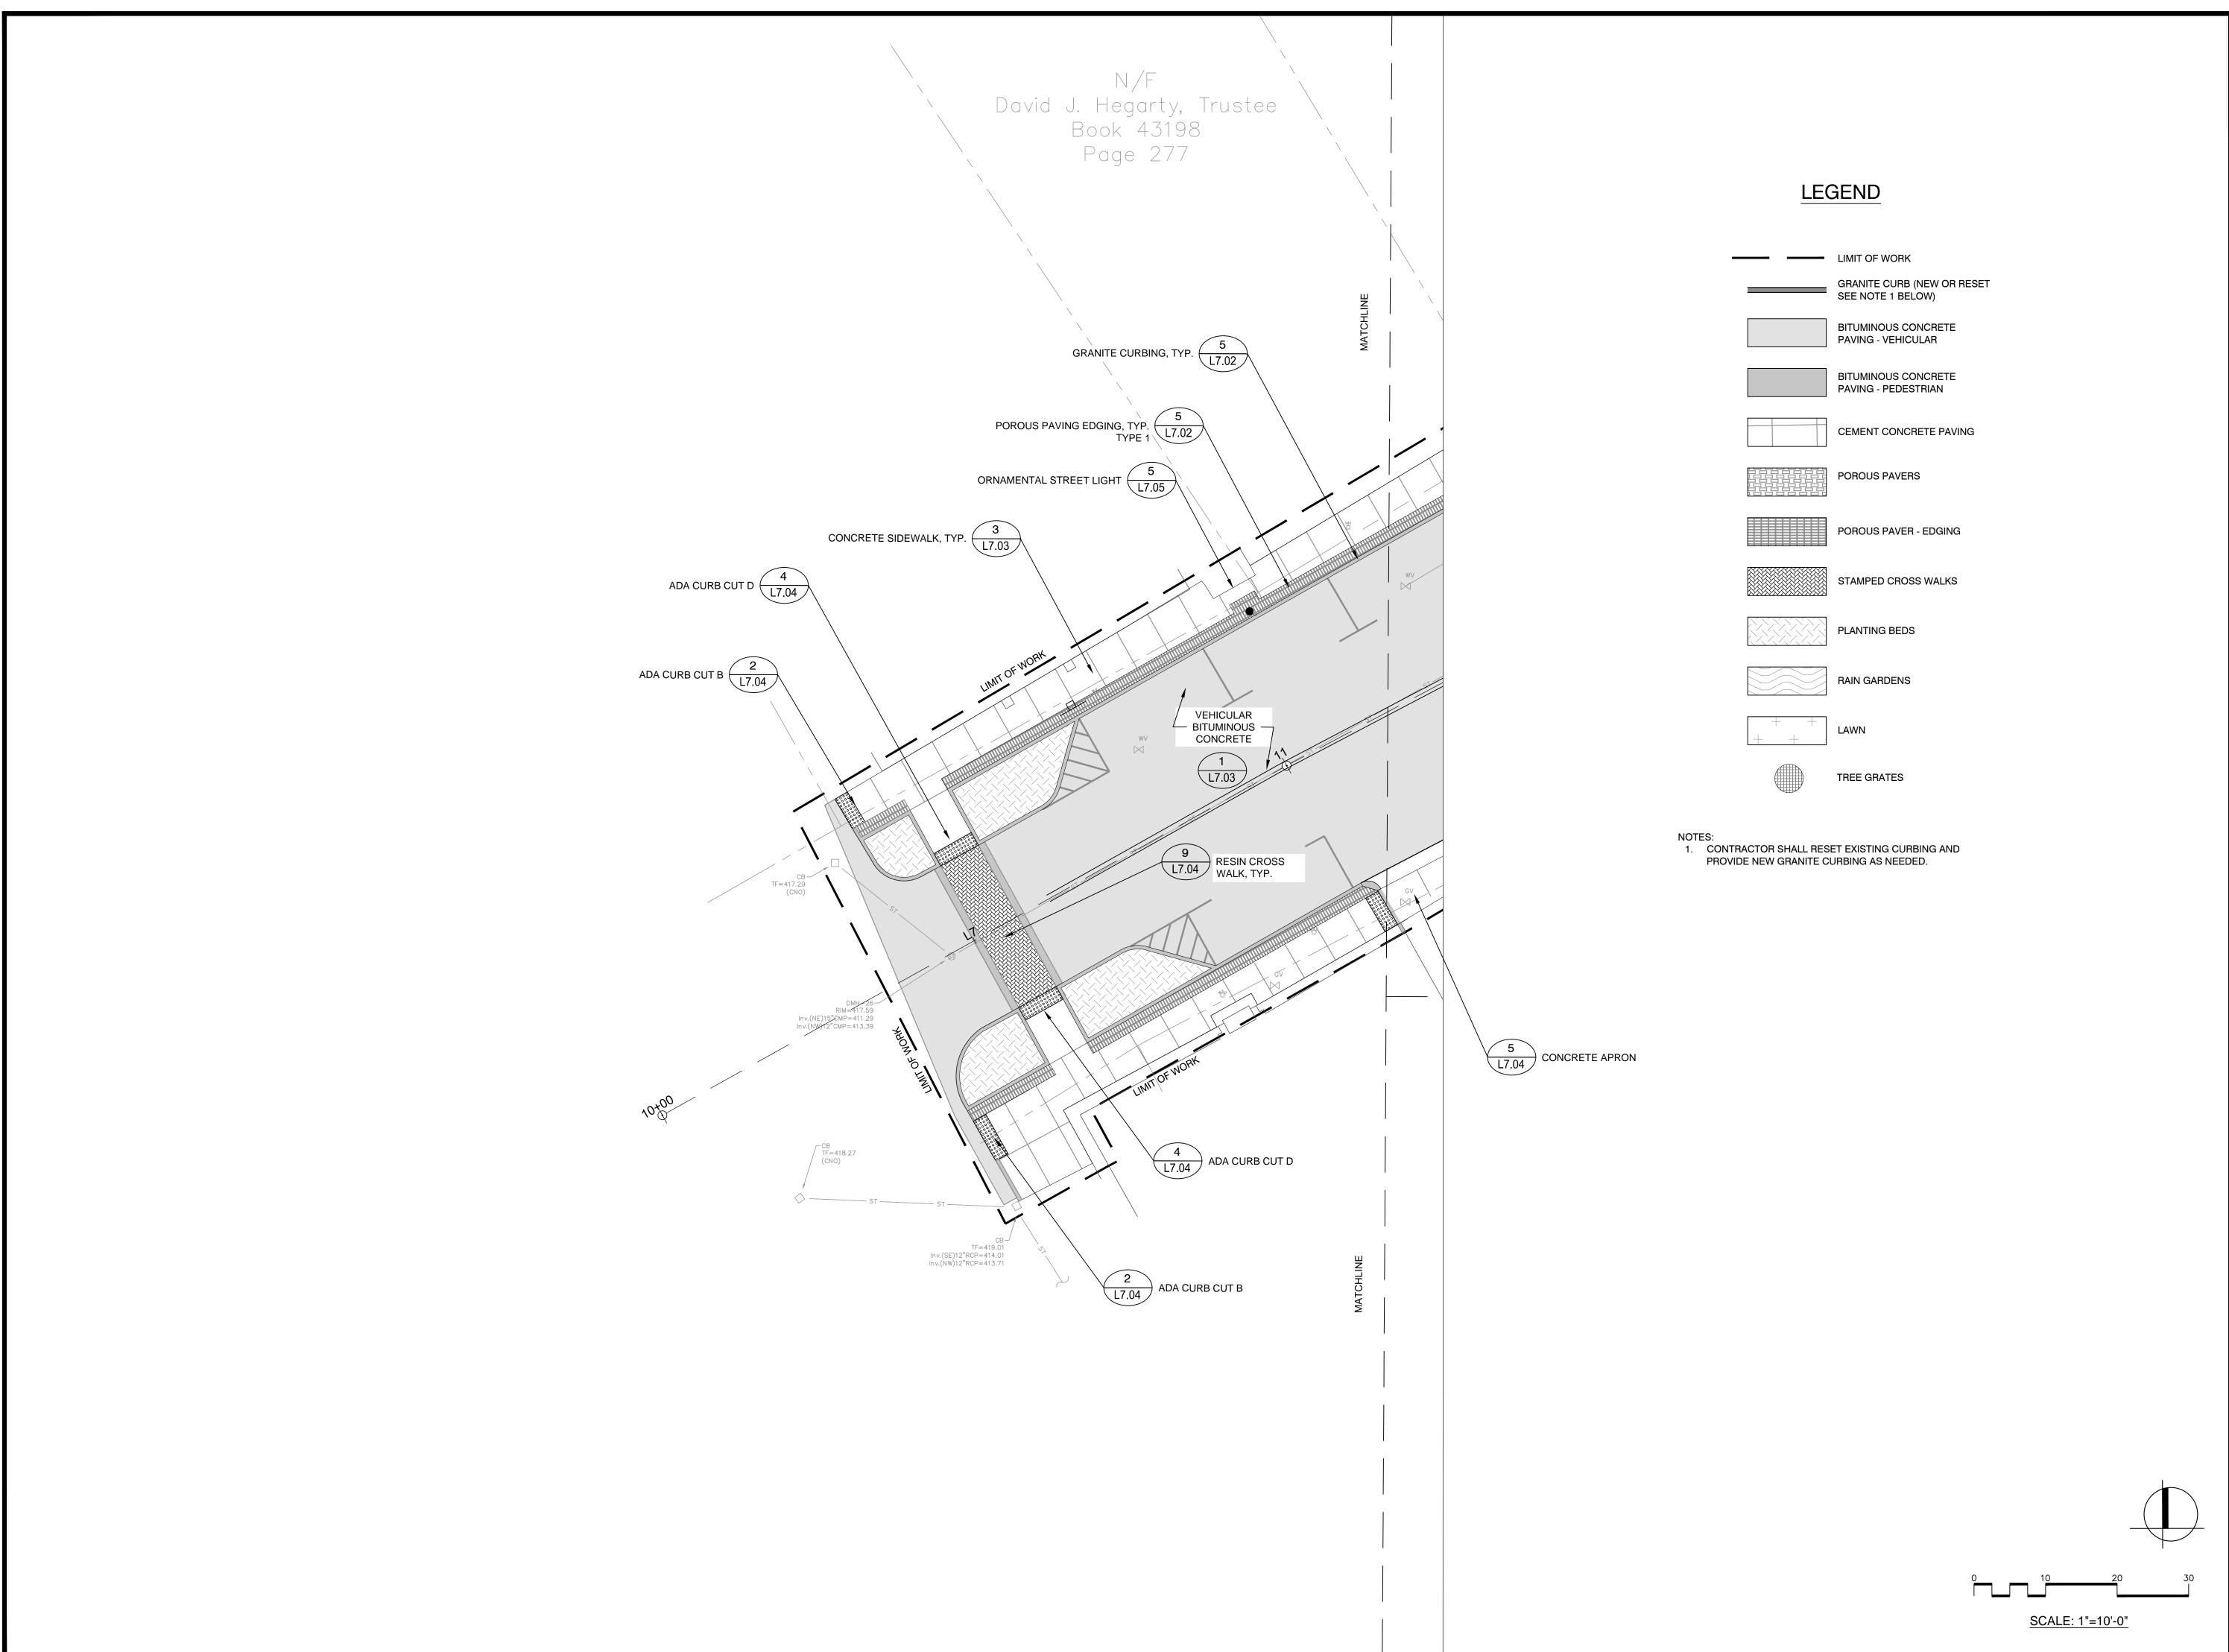
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W&S Project No: 2180403

MATERIALS PLAN ENLARGEMENT







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MILLBURY , MA

DOWNTOWN REDEVELOPMENT

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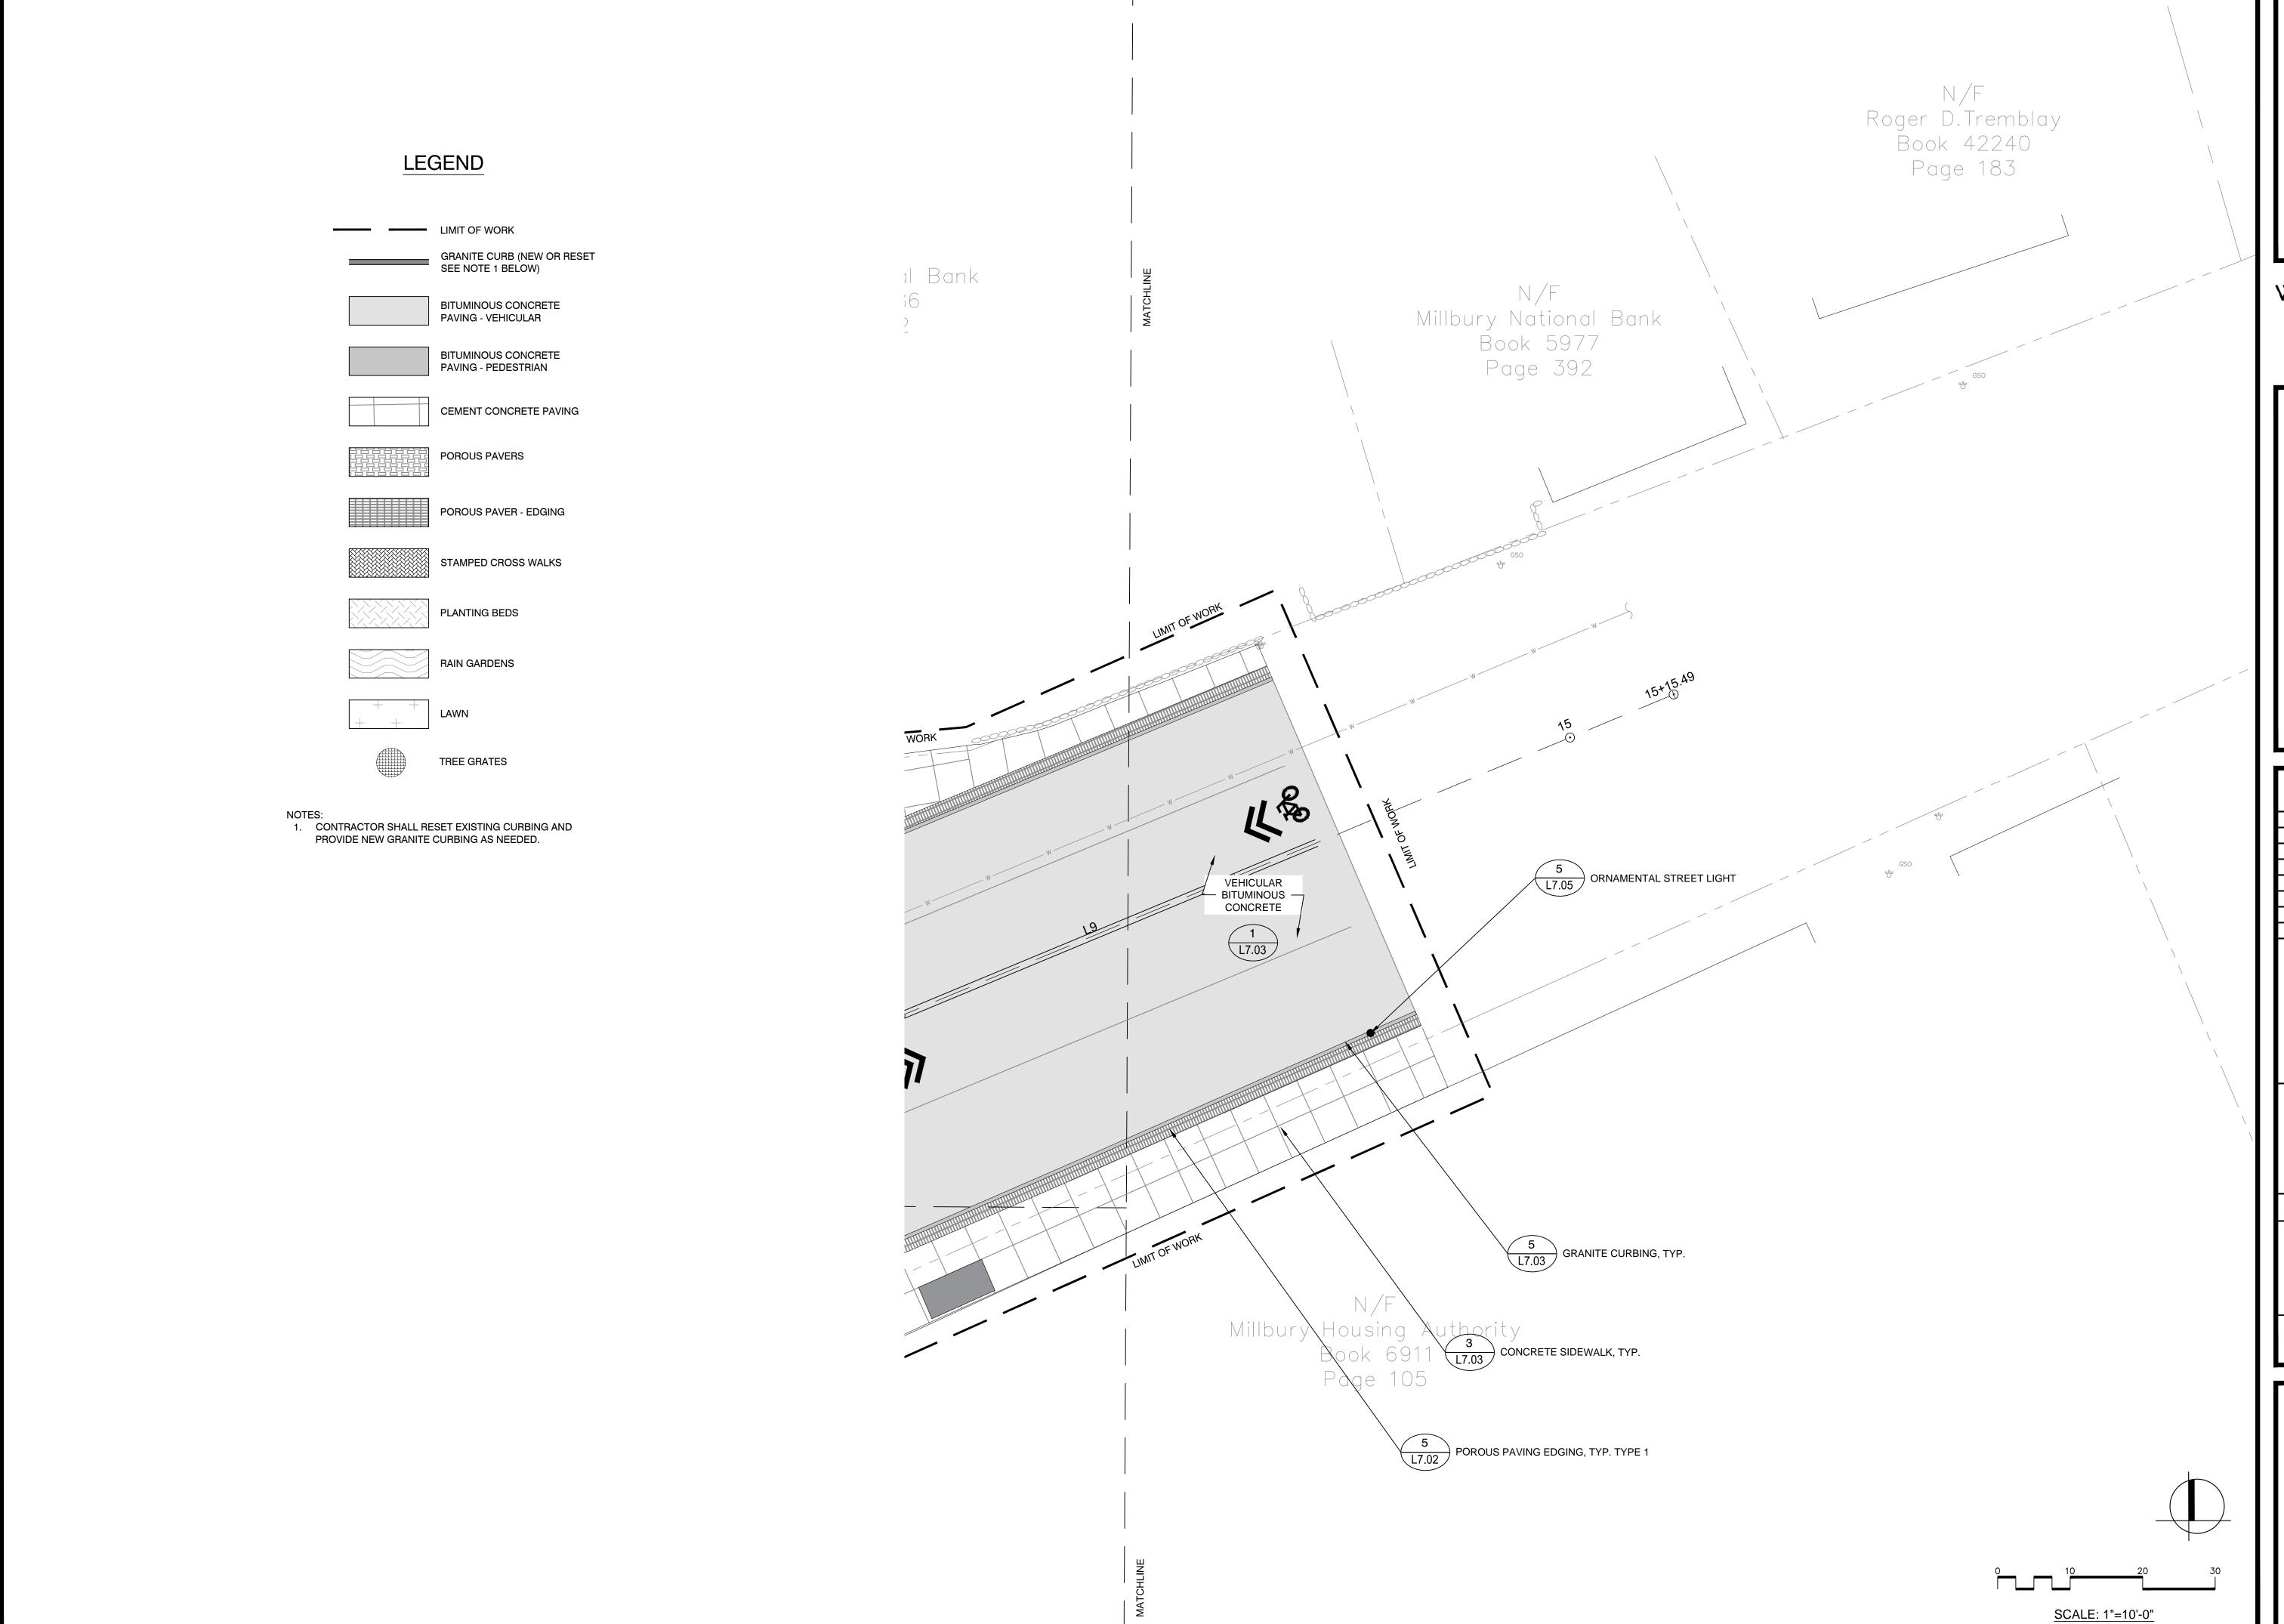
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Drawing Title:

MATERIALS PLAN ENLARGEMENT

Sheet Number:

L3.04



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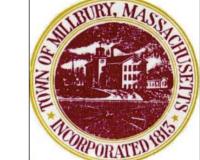
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MATERIALS PLAN ENLARGEMENT

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L3.05





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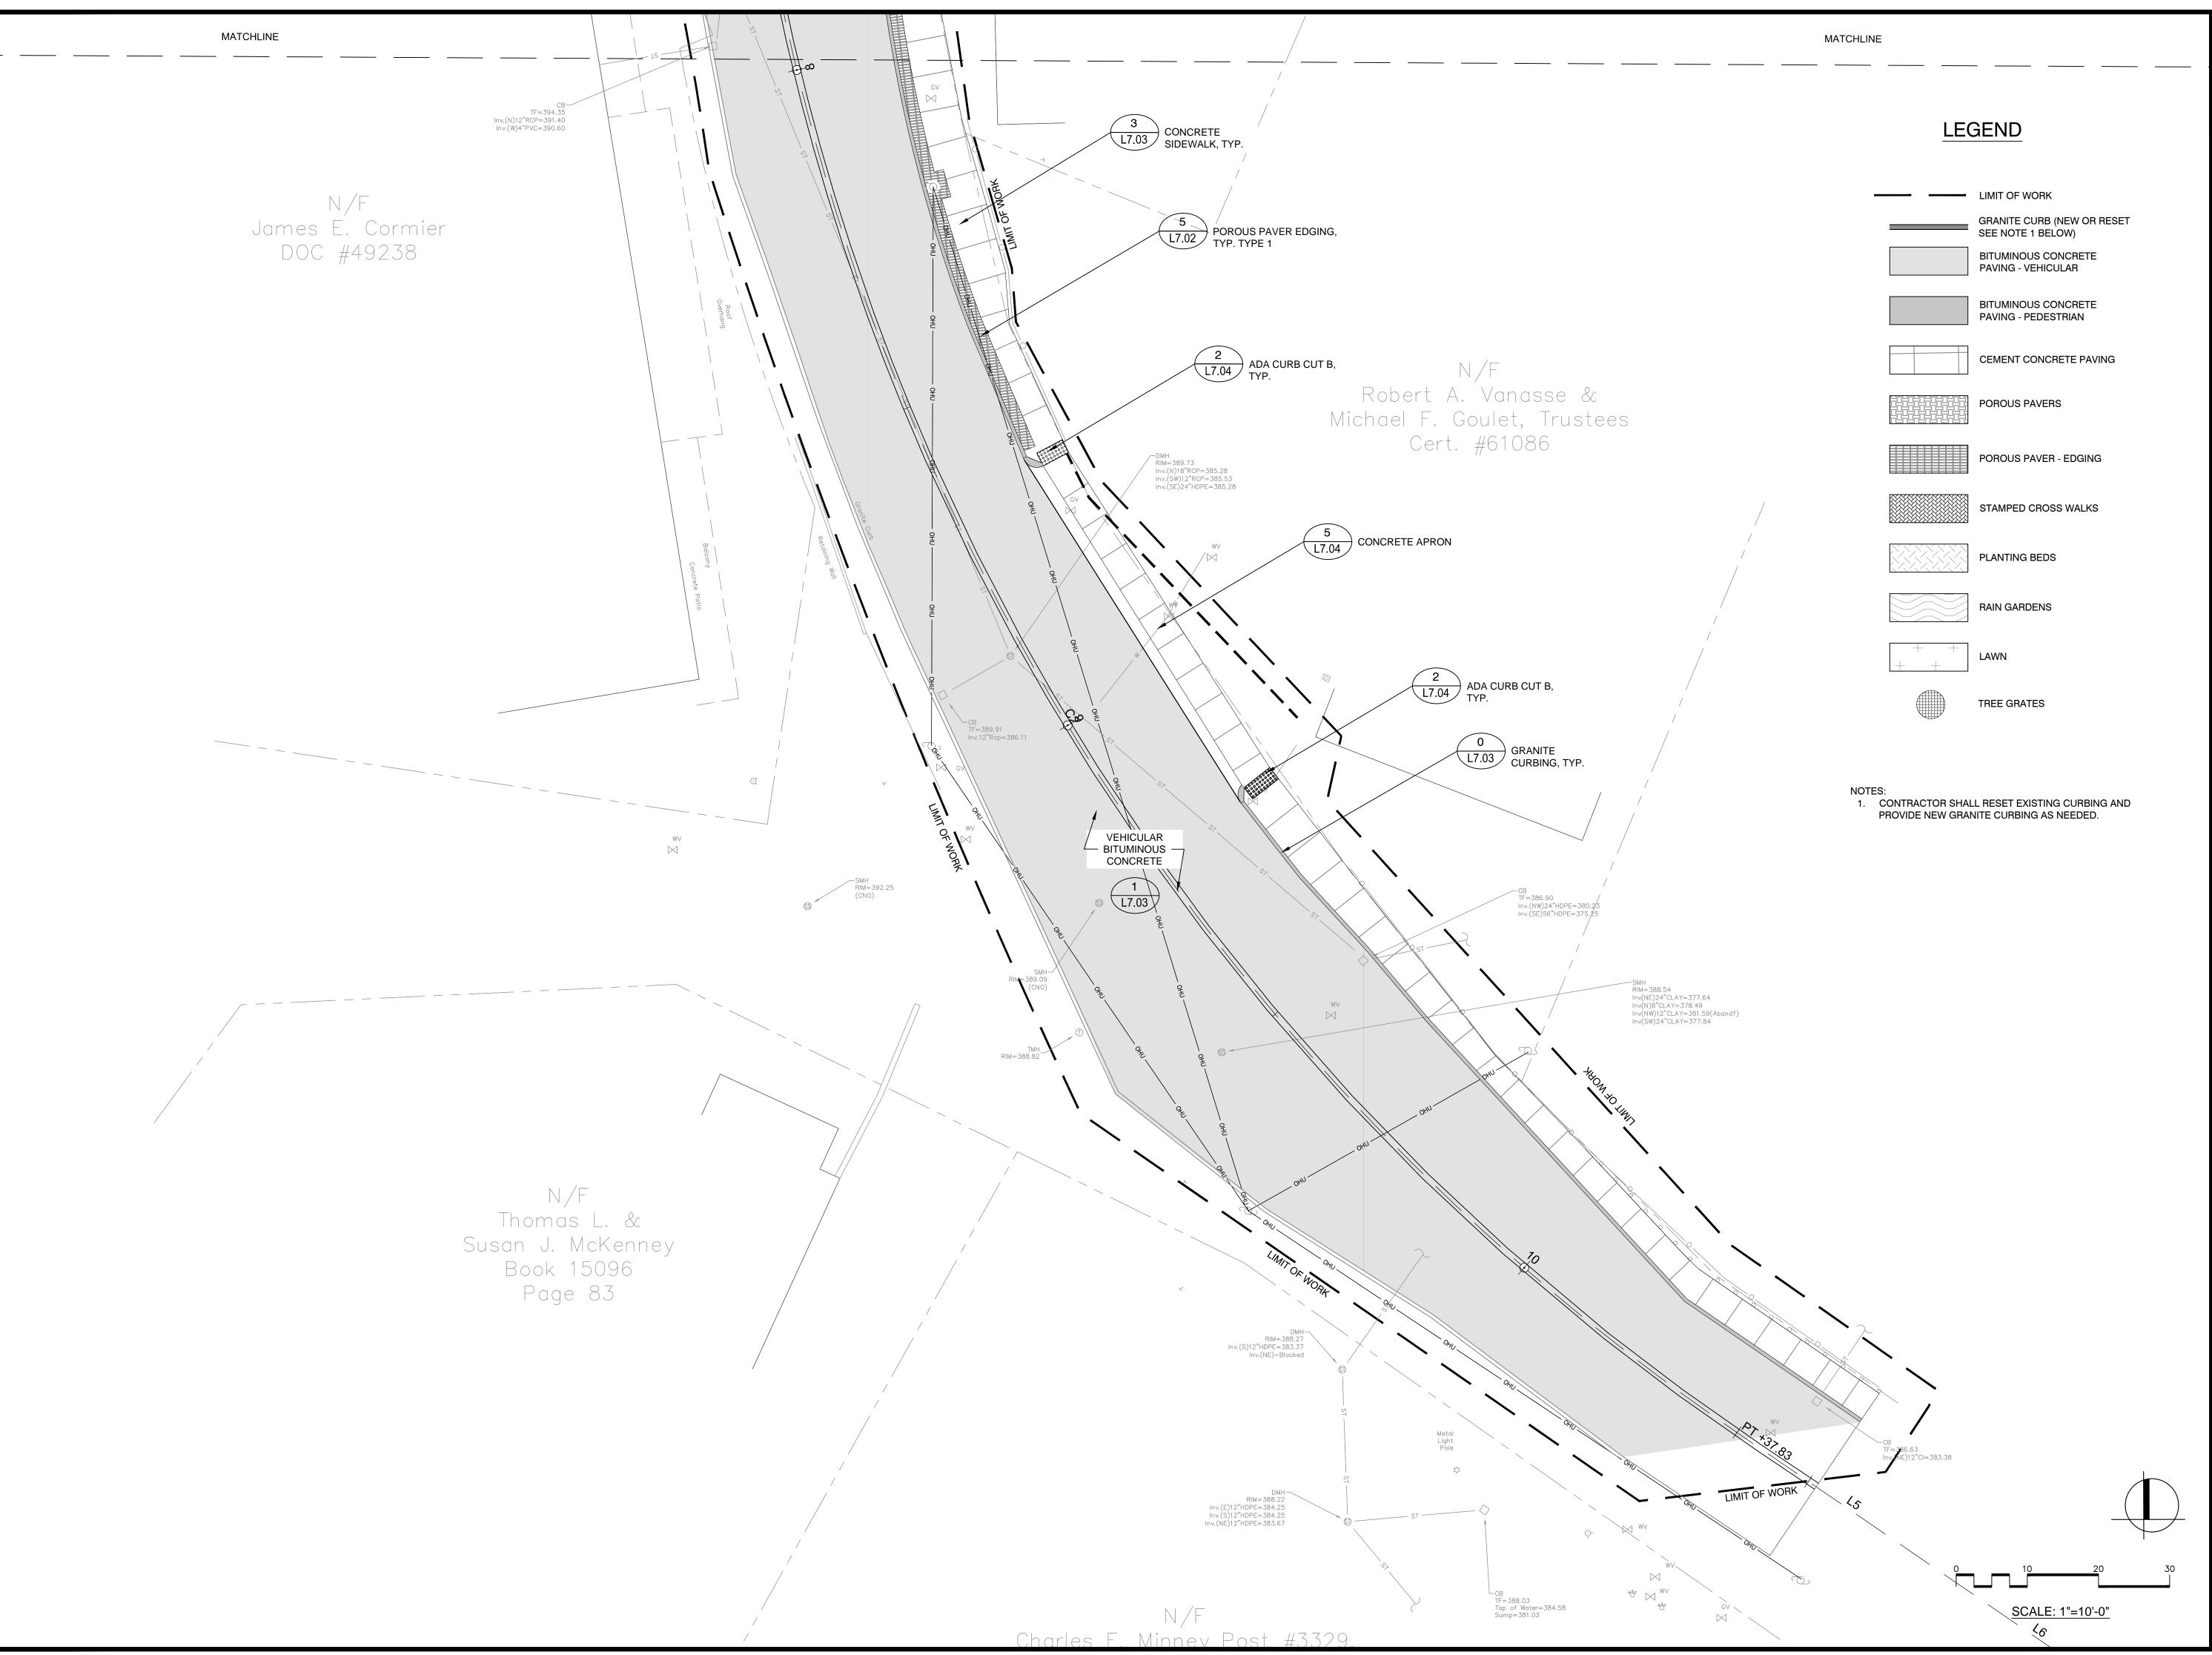
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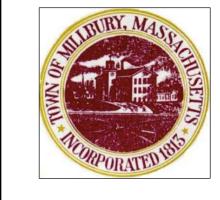
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PLAN ENLARGEMENT

L3.06



Project:
TOWN OF MILLBURY, MA



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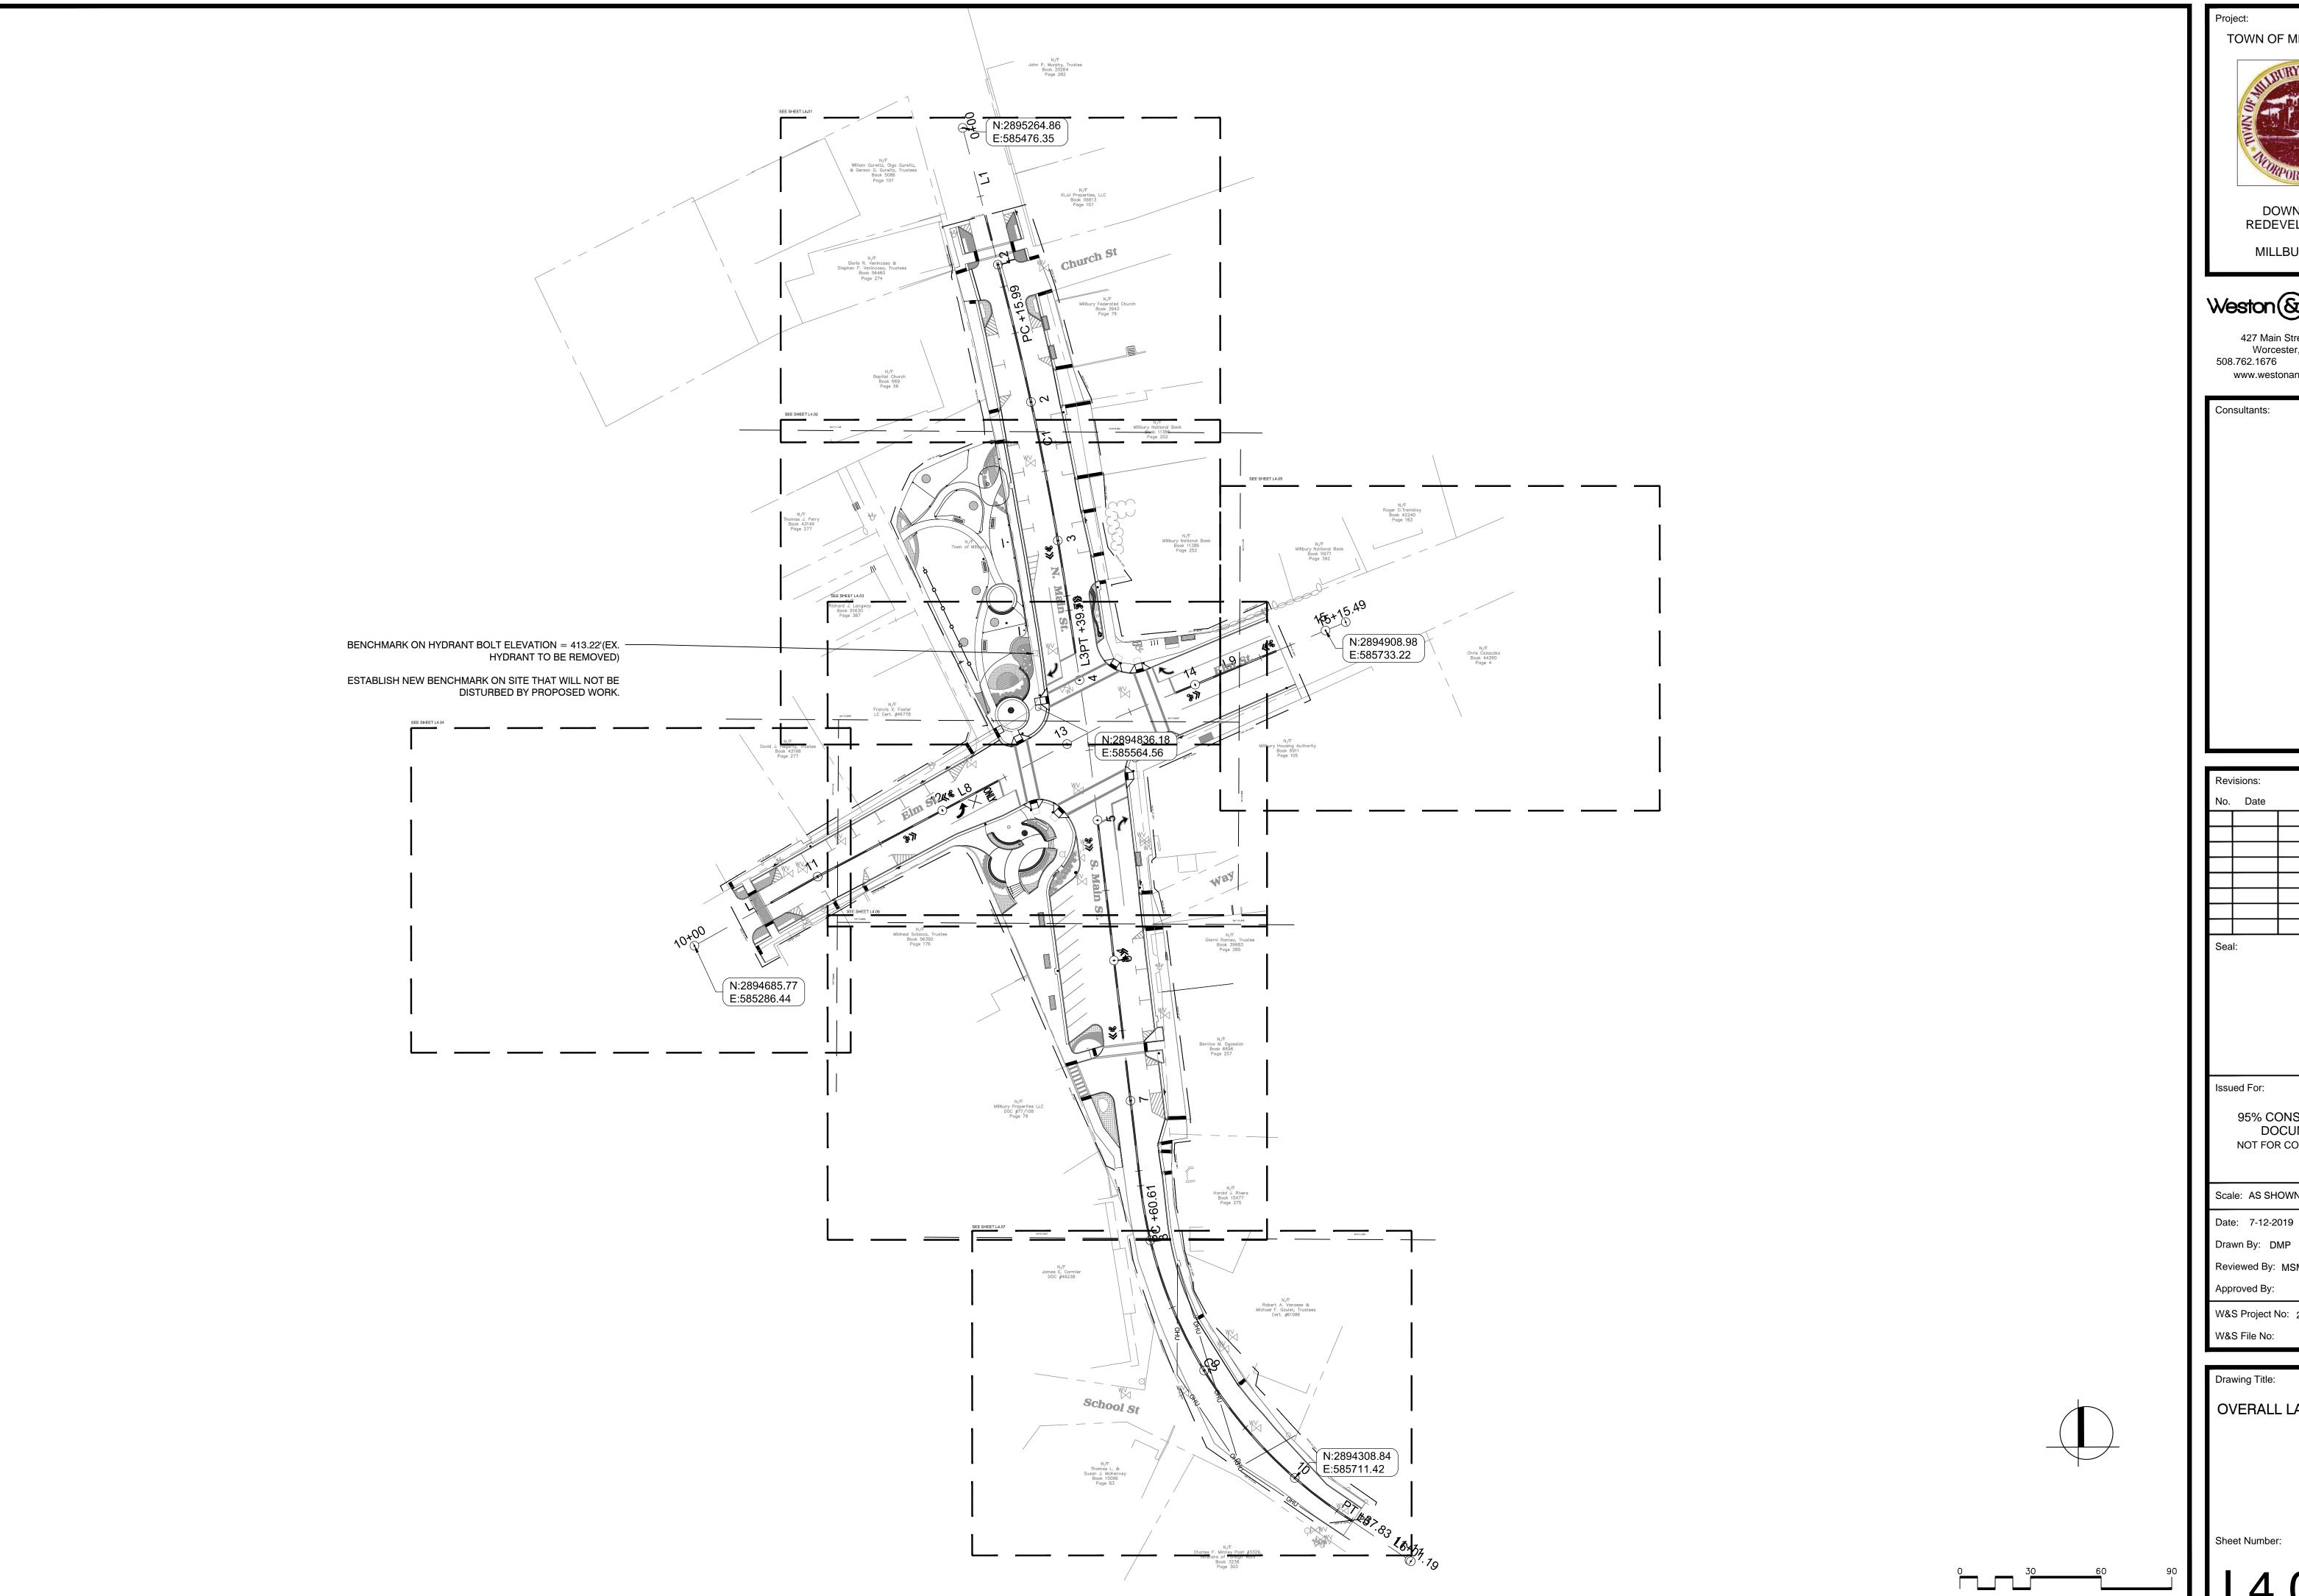
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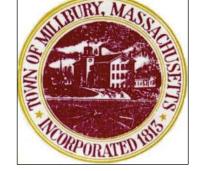
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MATERIALS PLAN ENLARGEMENT

Sheet Number:

L3.07





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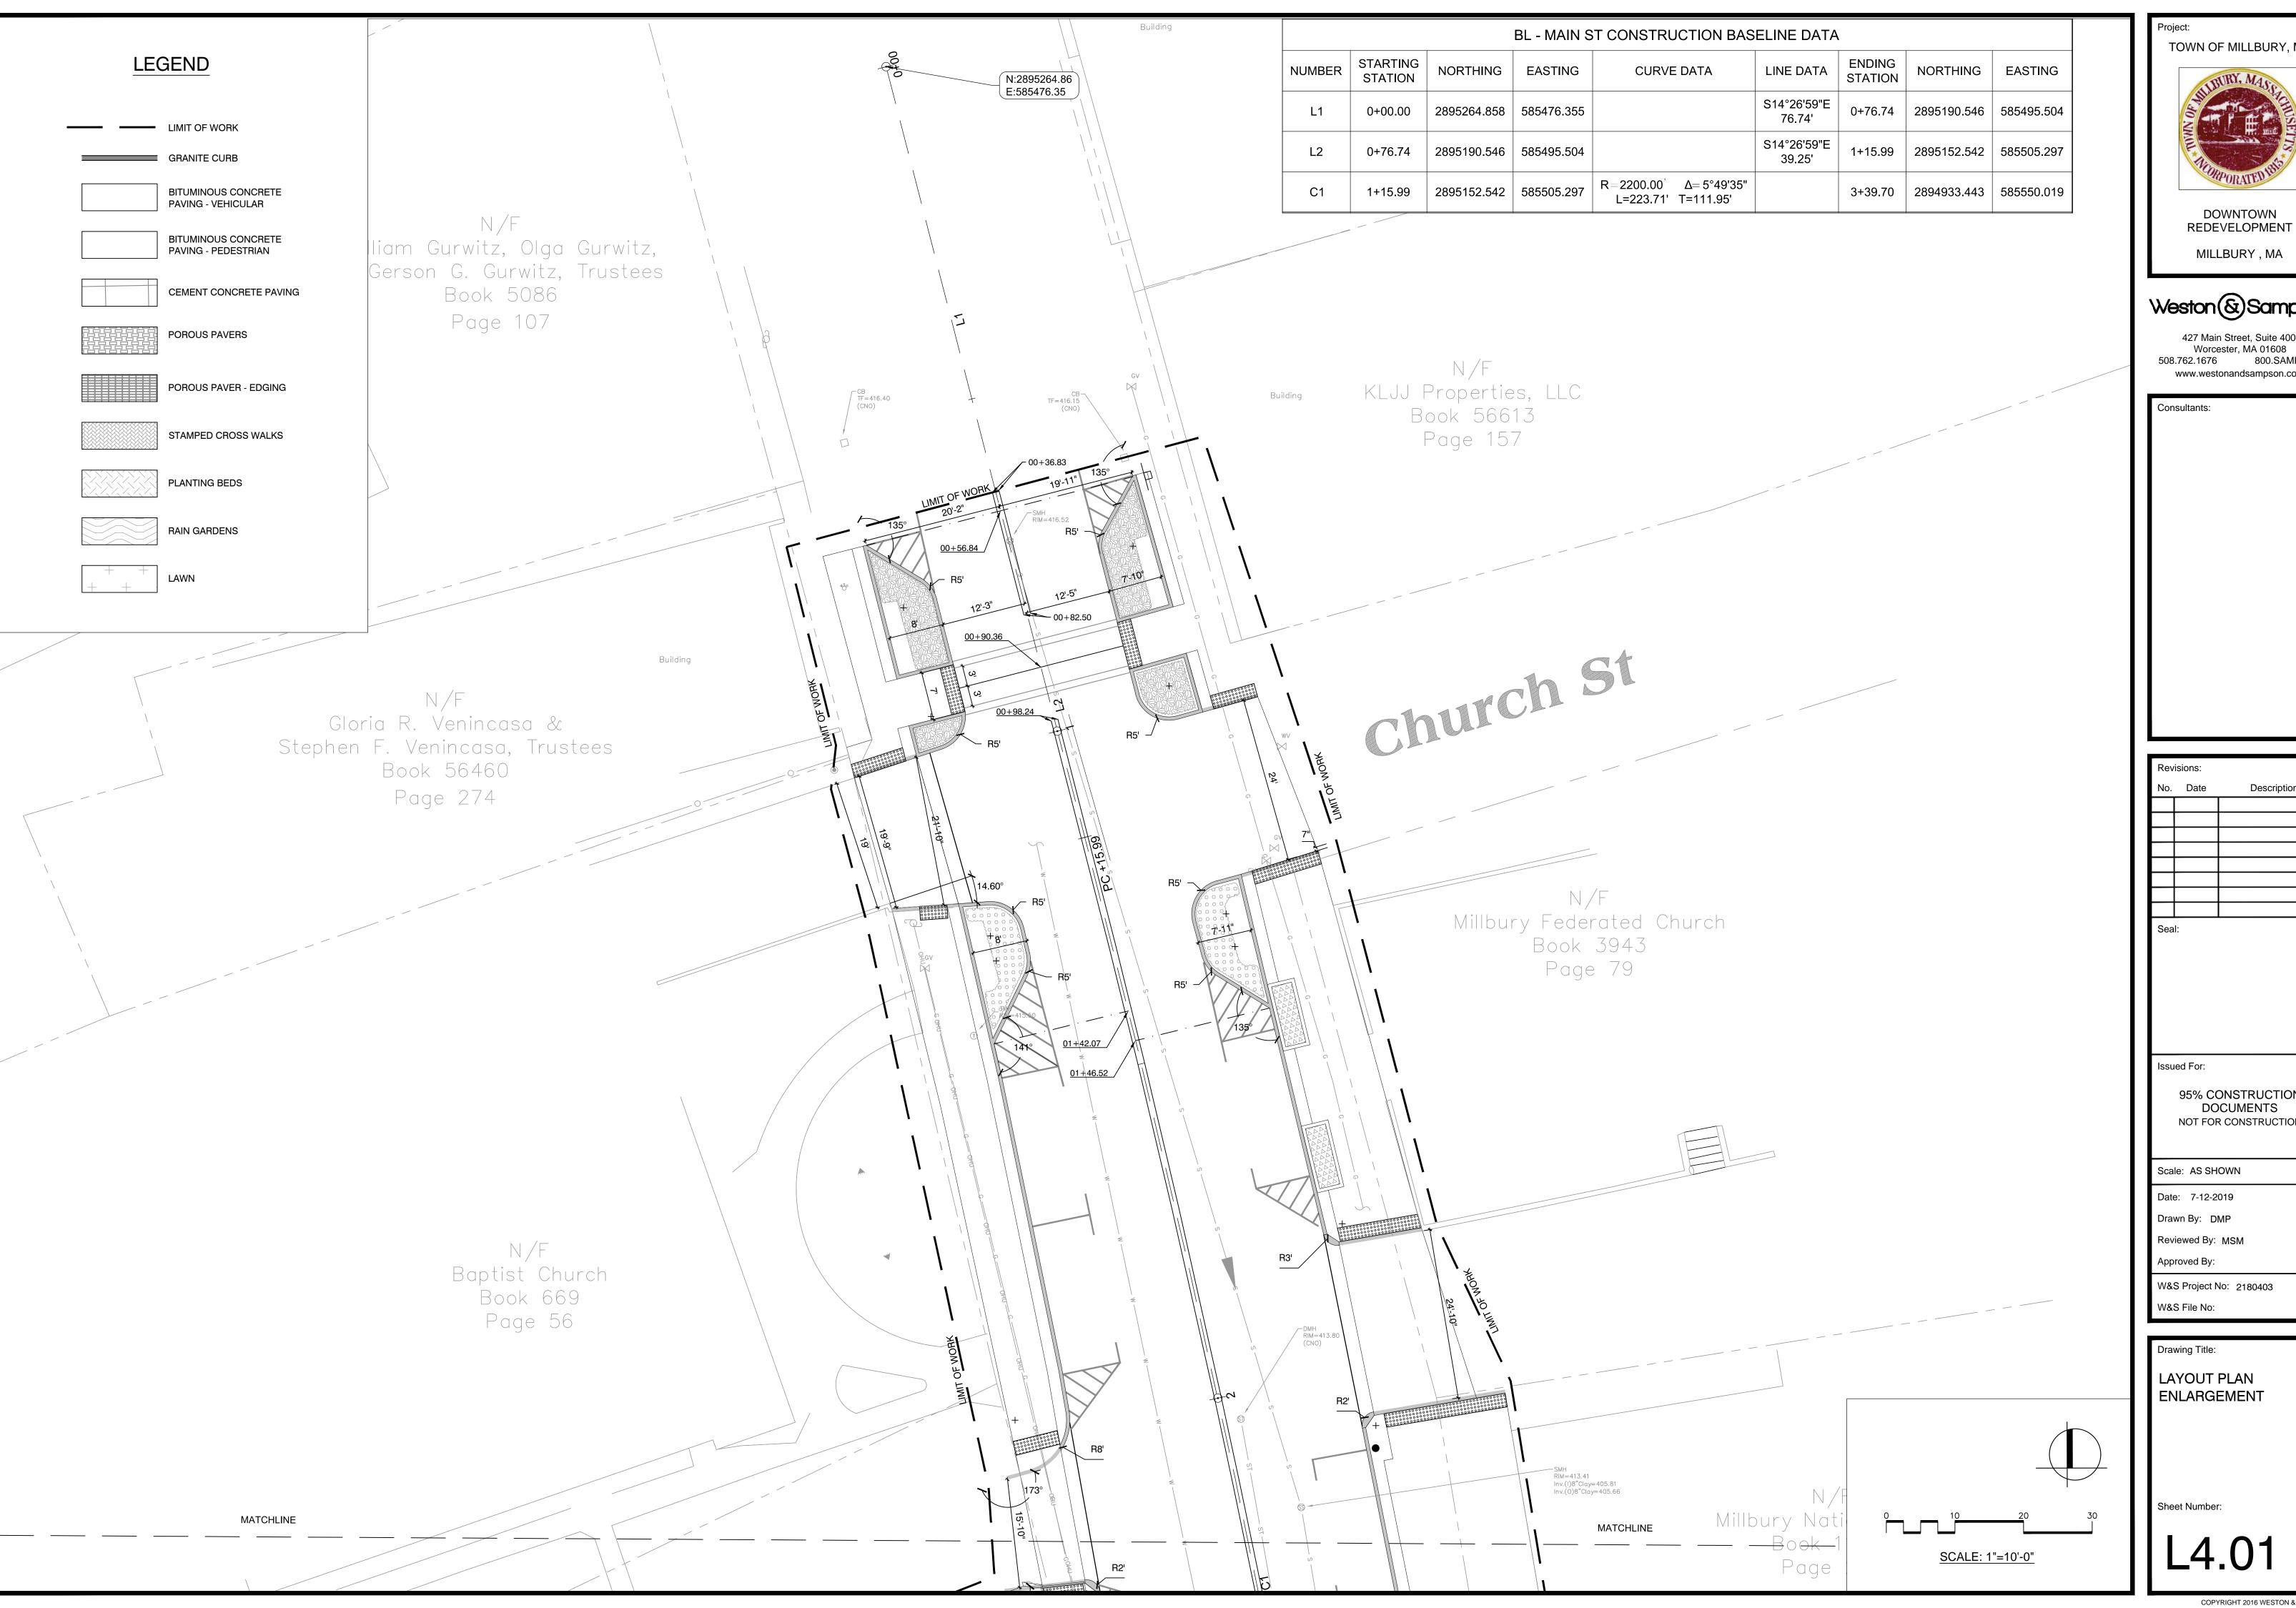
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Drawing Title:

OVERALL LAYOUT PLAN

SCALE: 1"=30'-0"





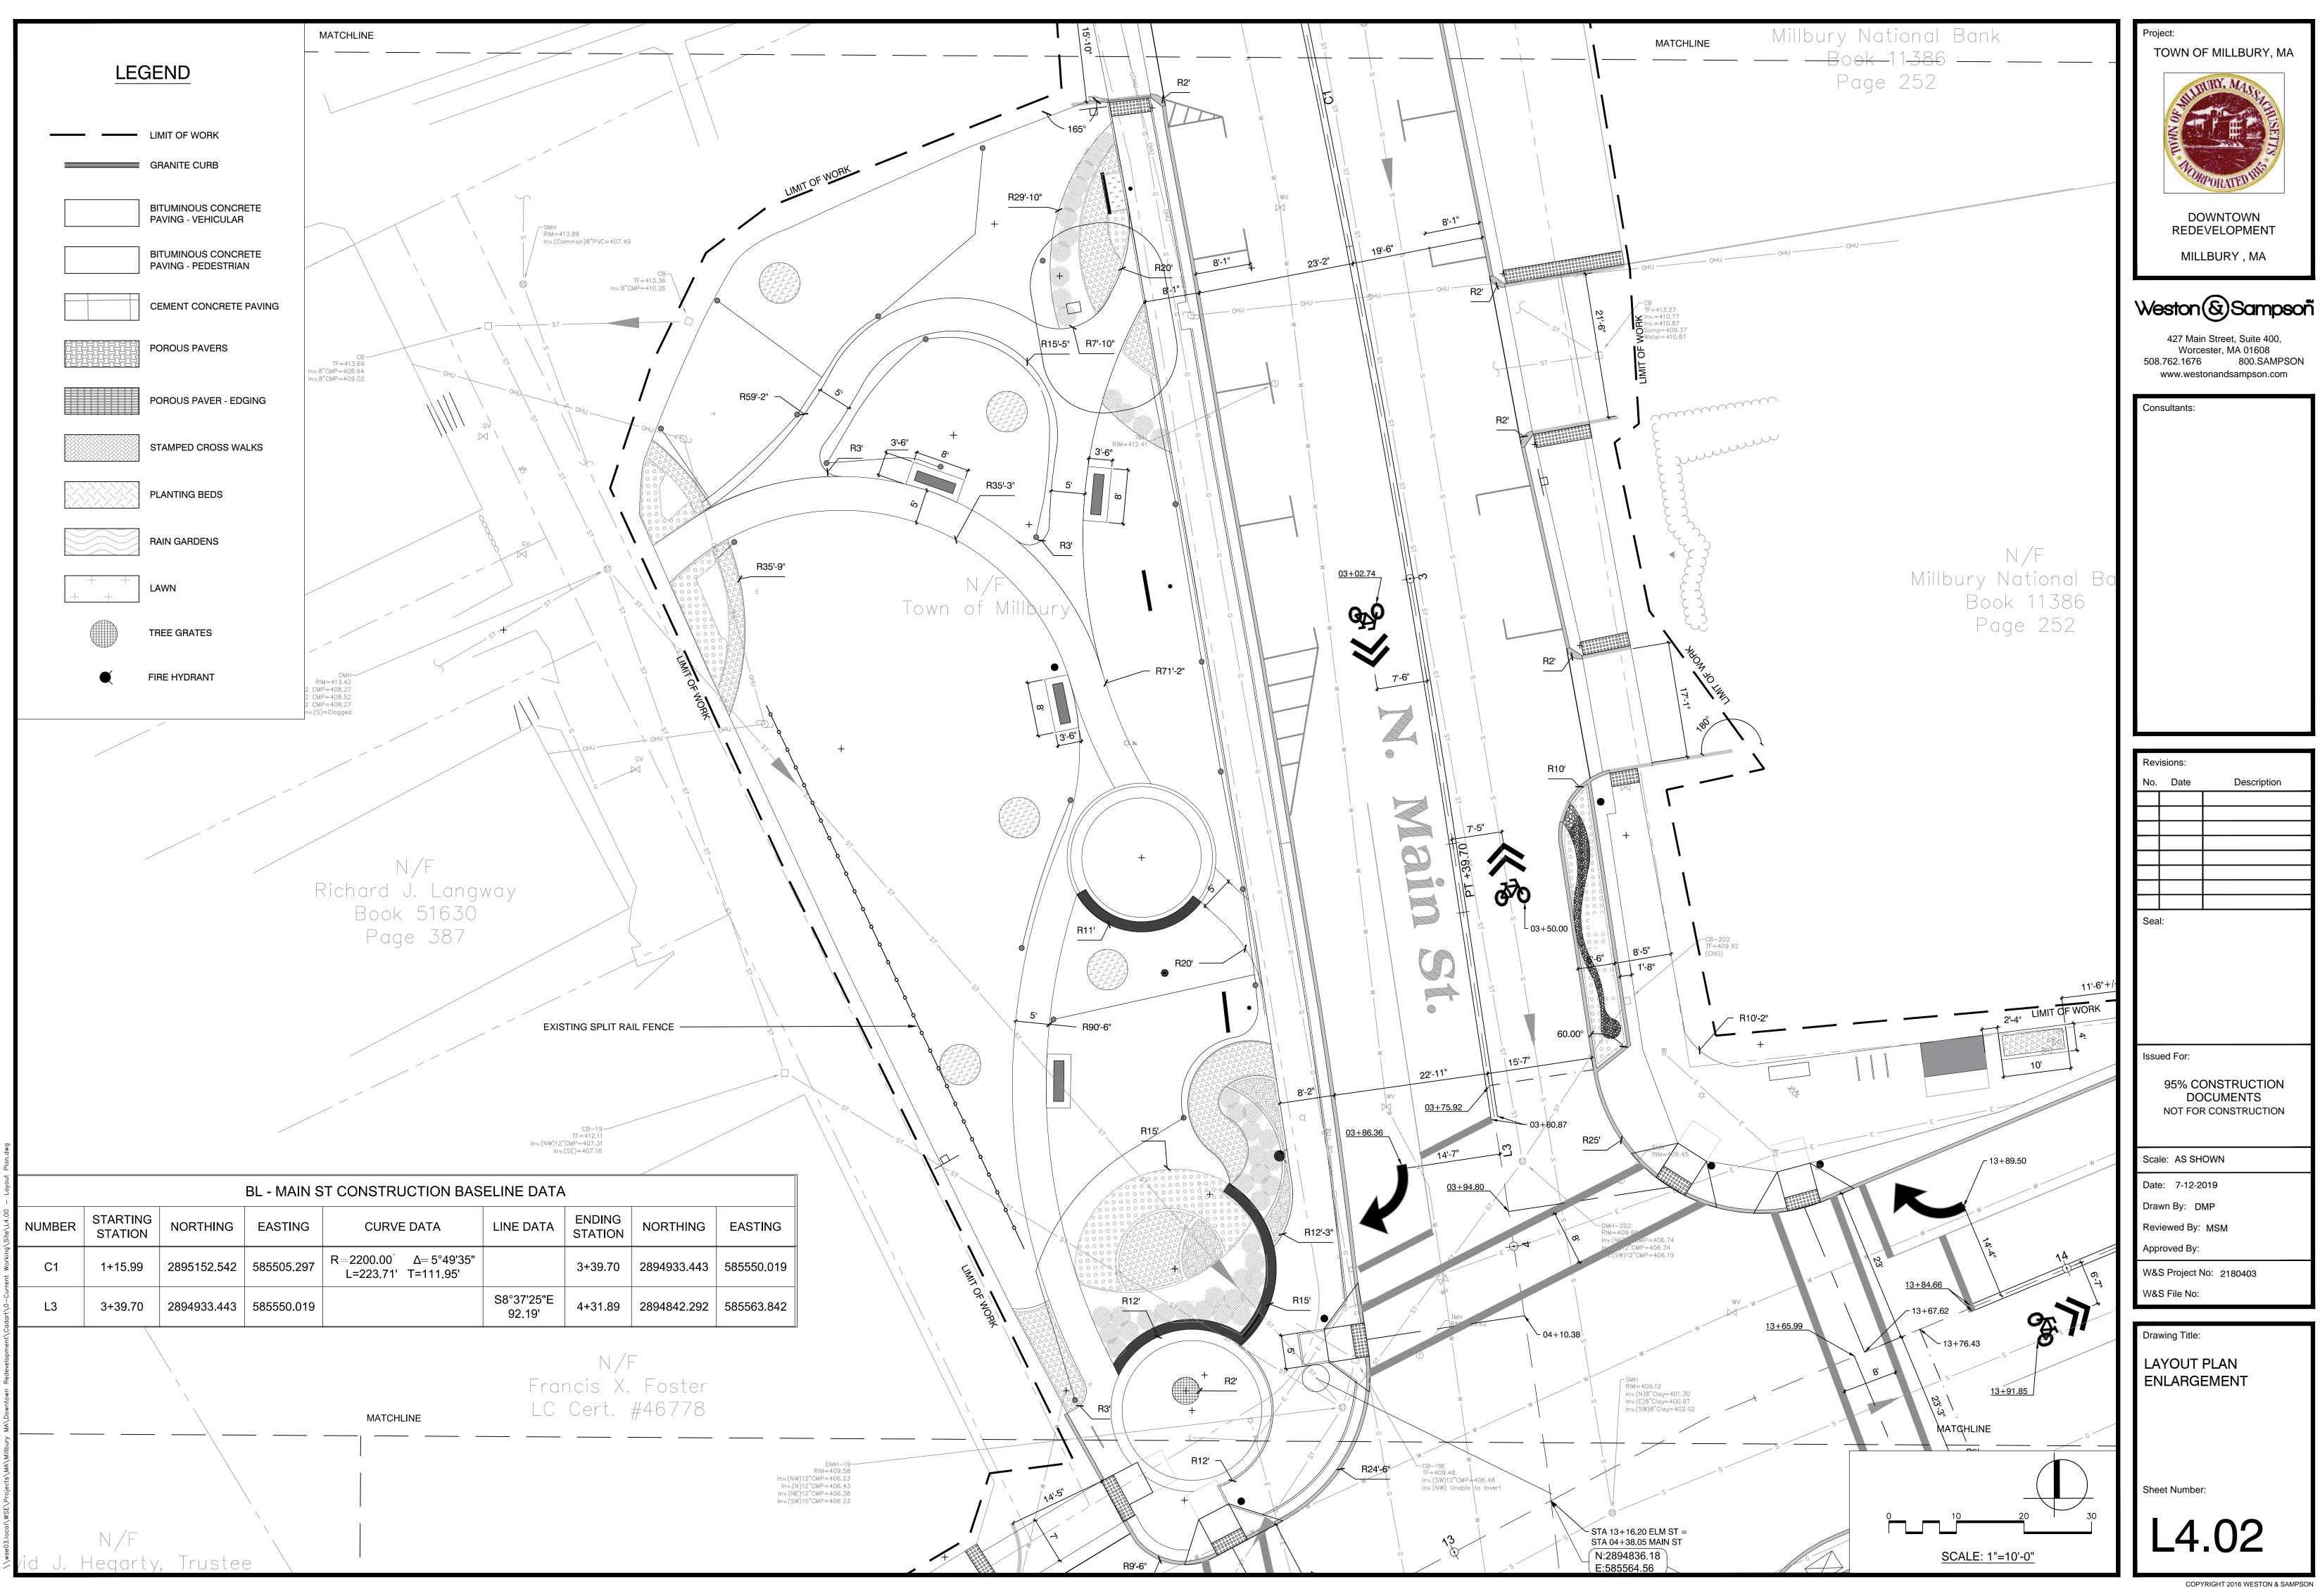
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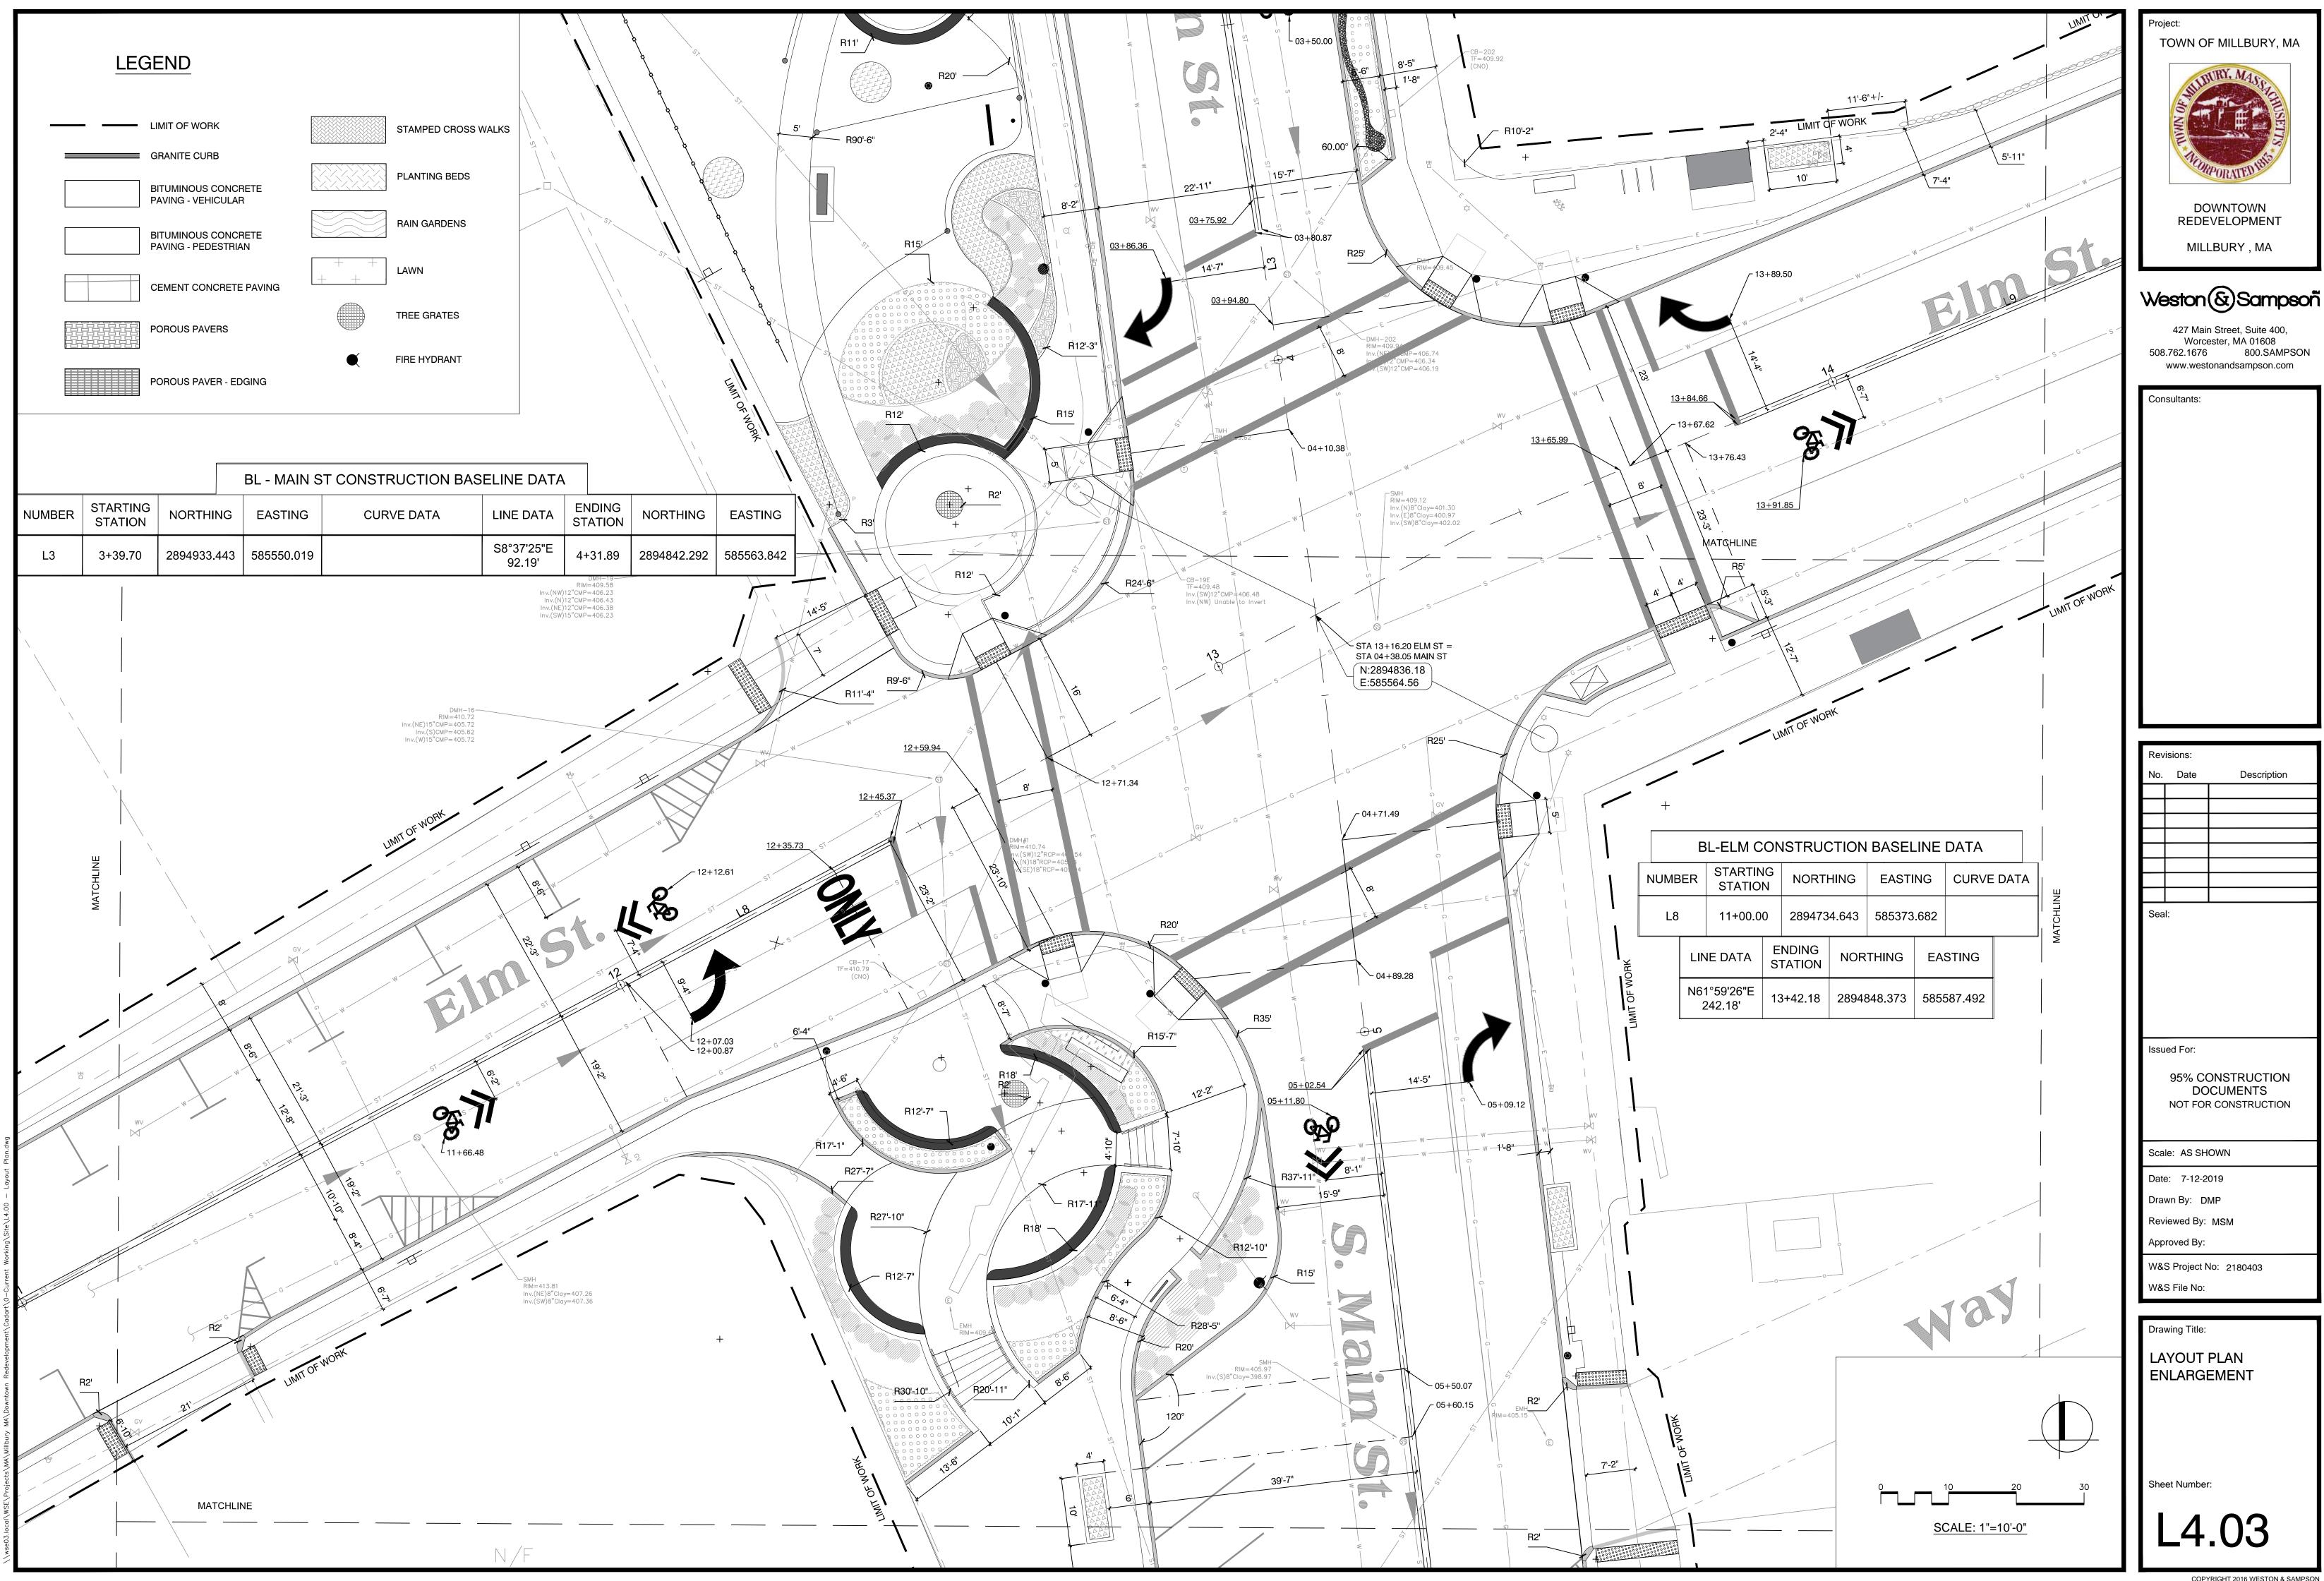
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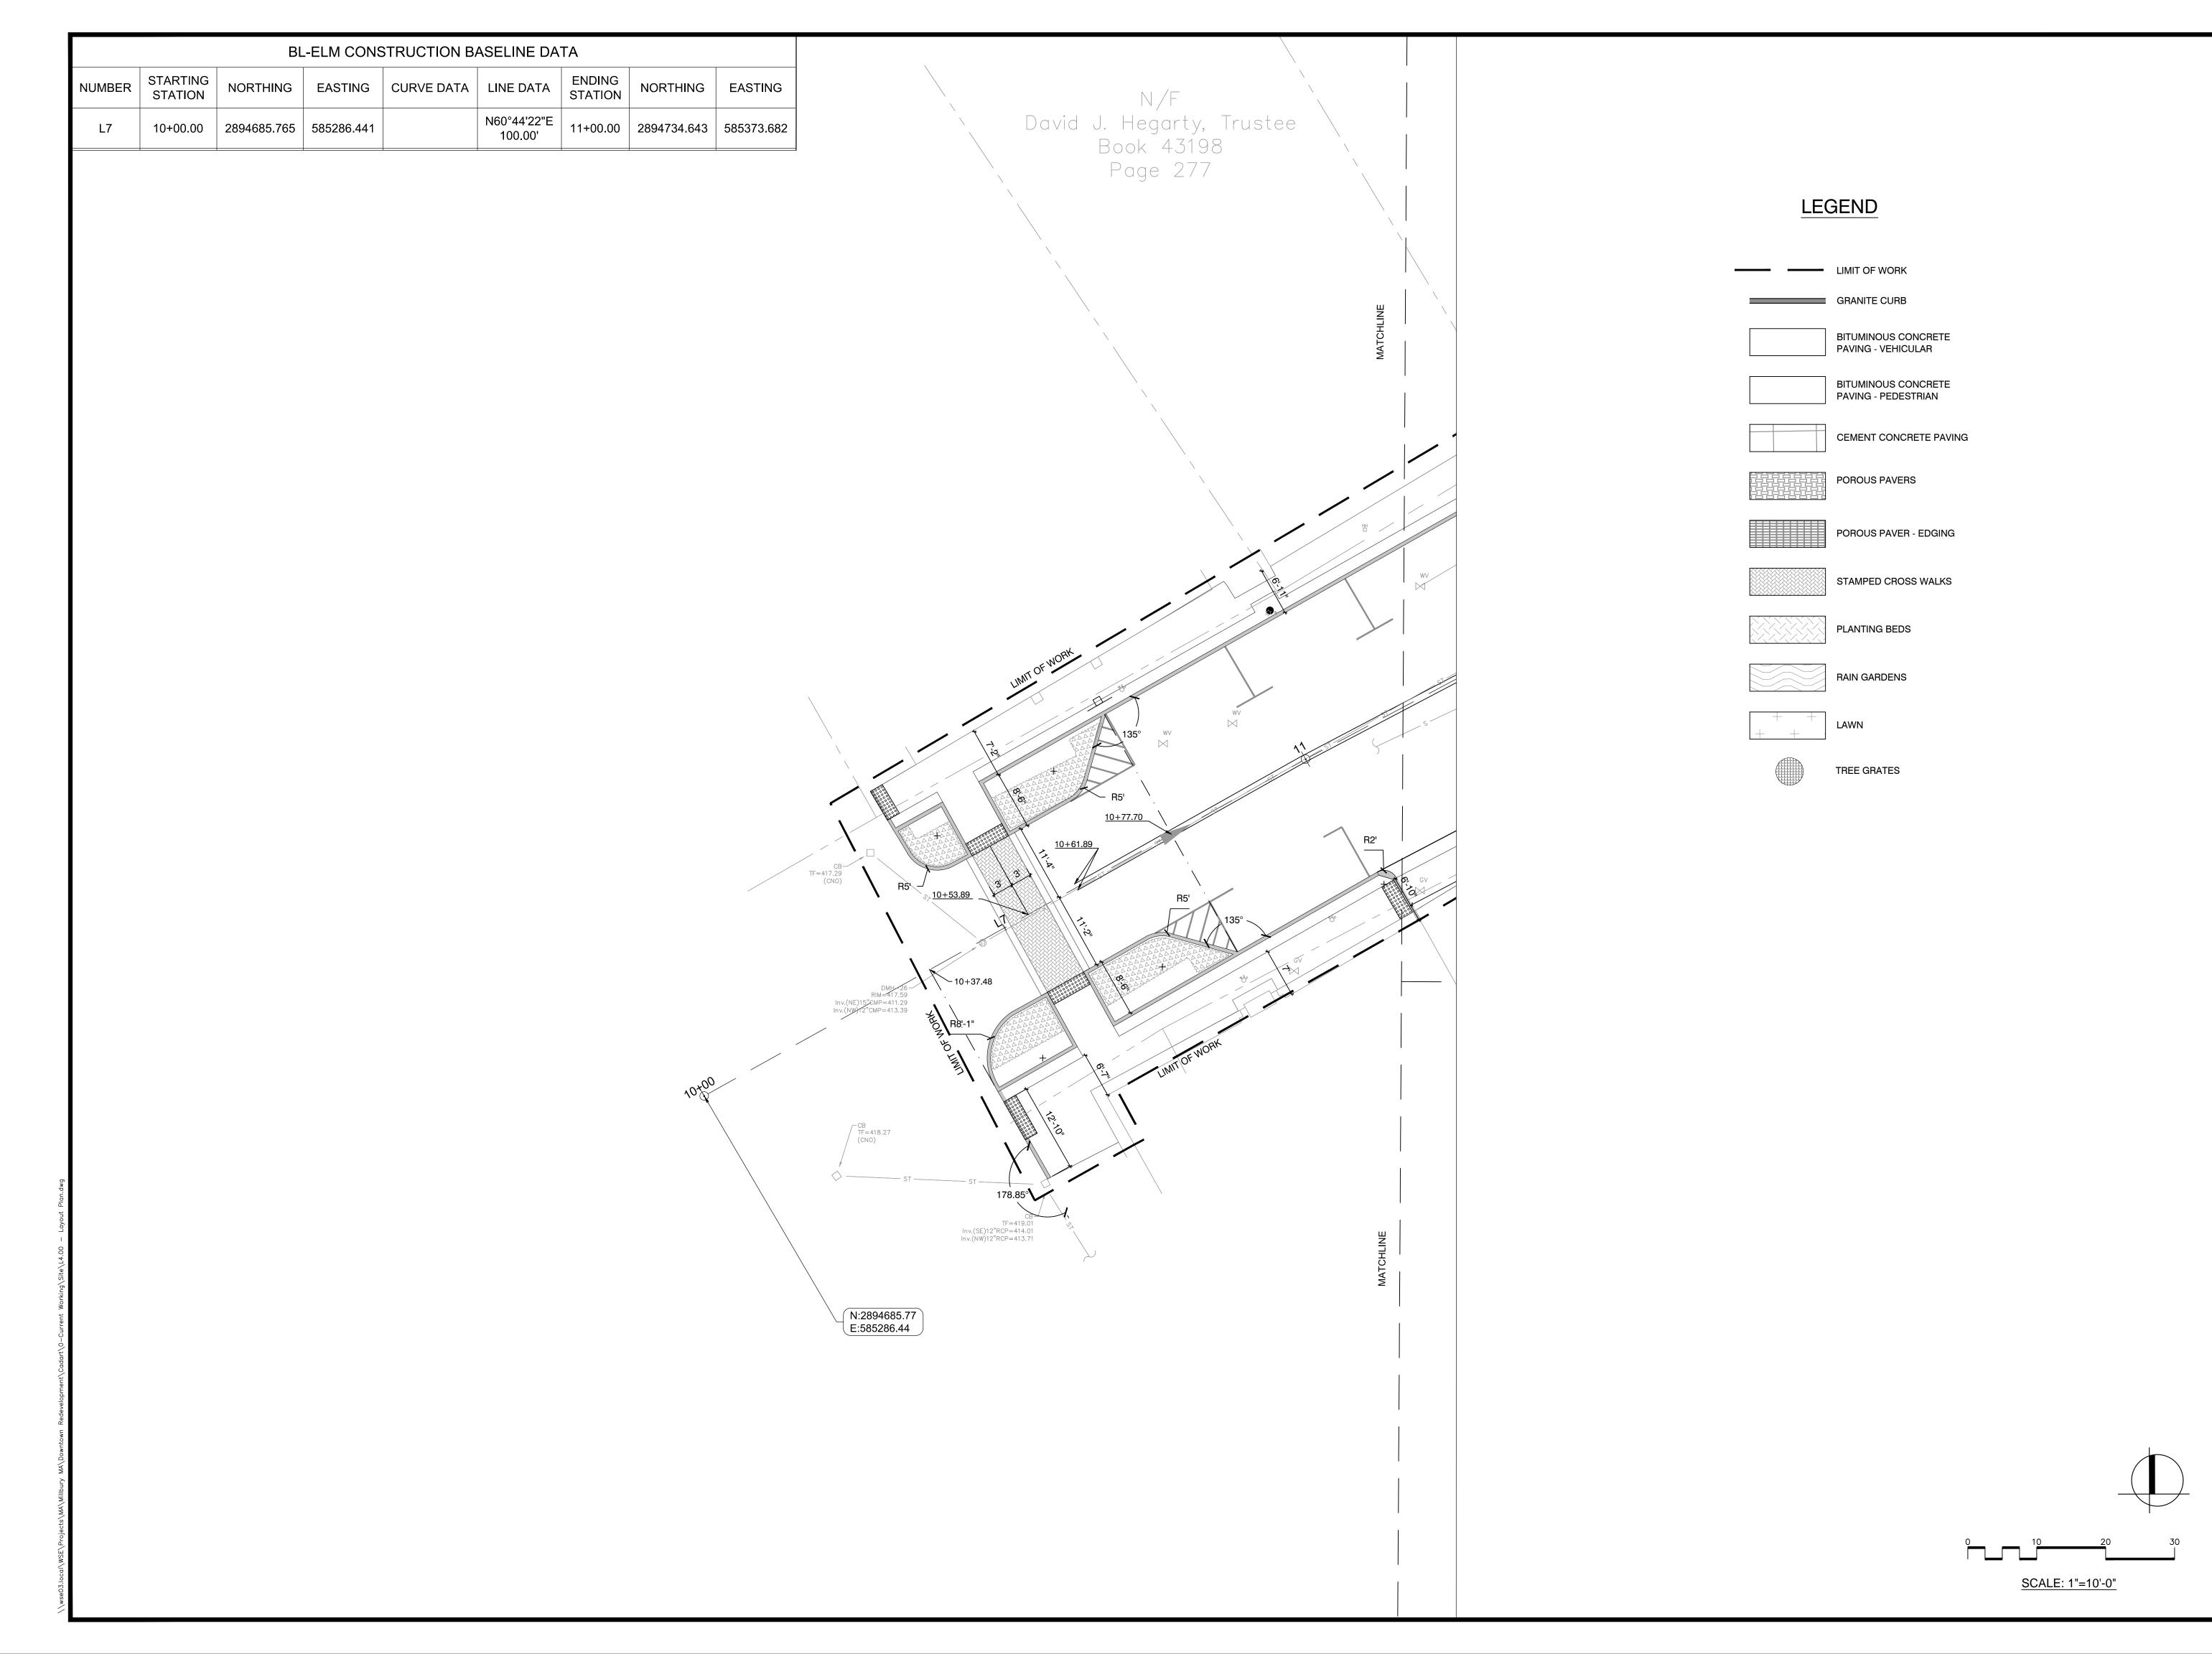
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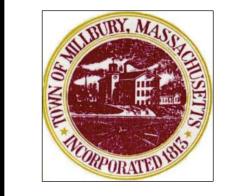
L4.01







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TOWN OF MILLBURY, MA



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Date: 7-12-2019

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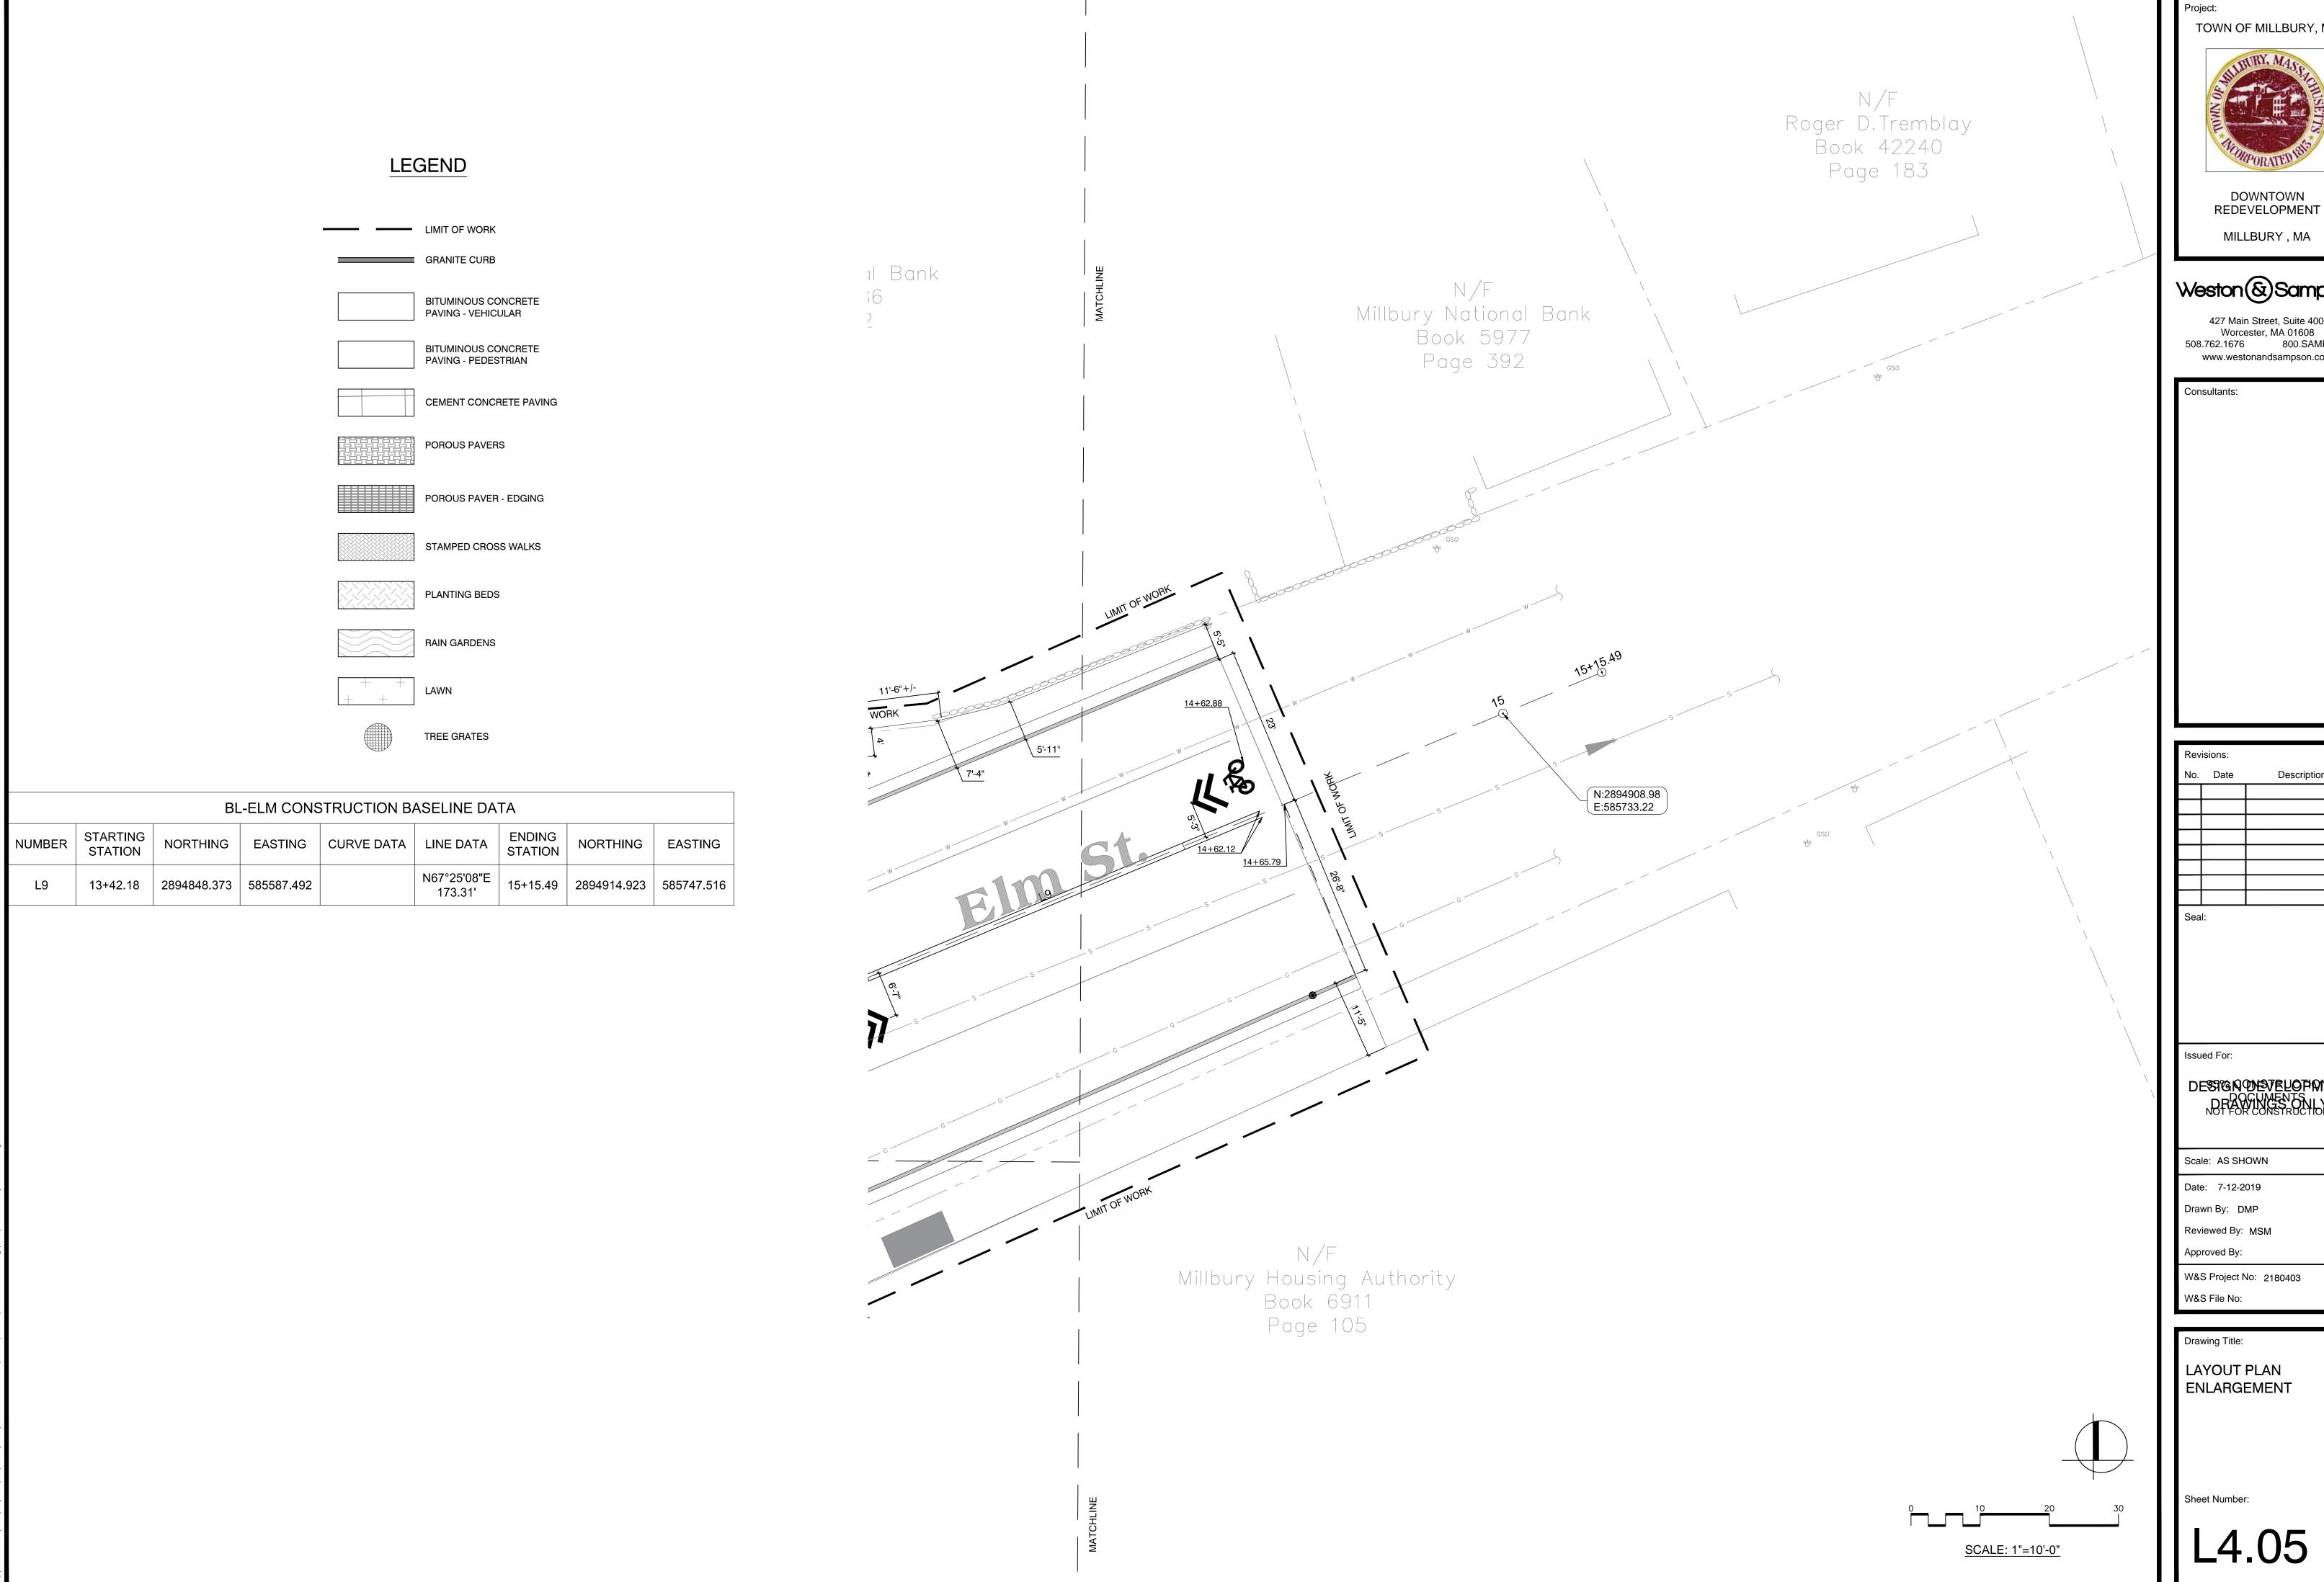
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Drawing Title:

LAYOUT PLAN ENLARGEMENT

Sheet Number:

L4.04



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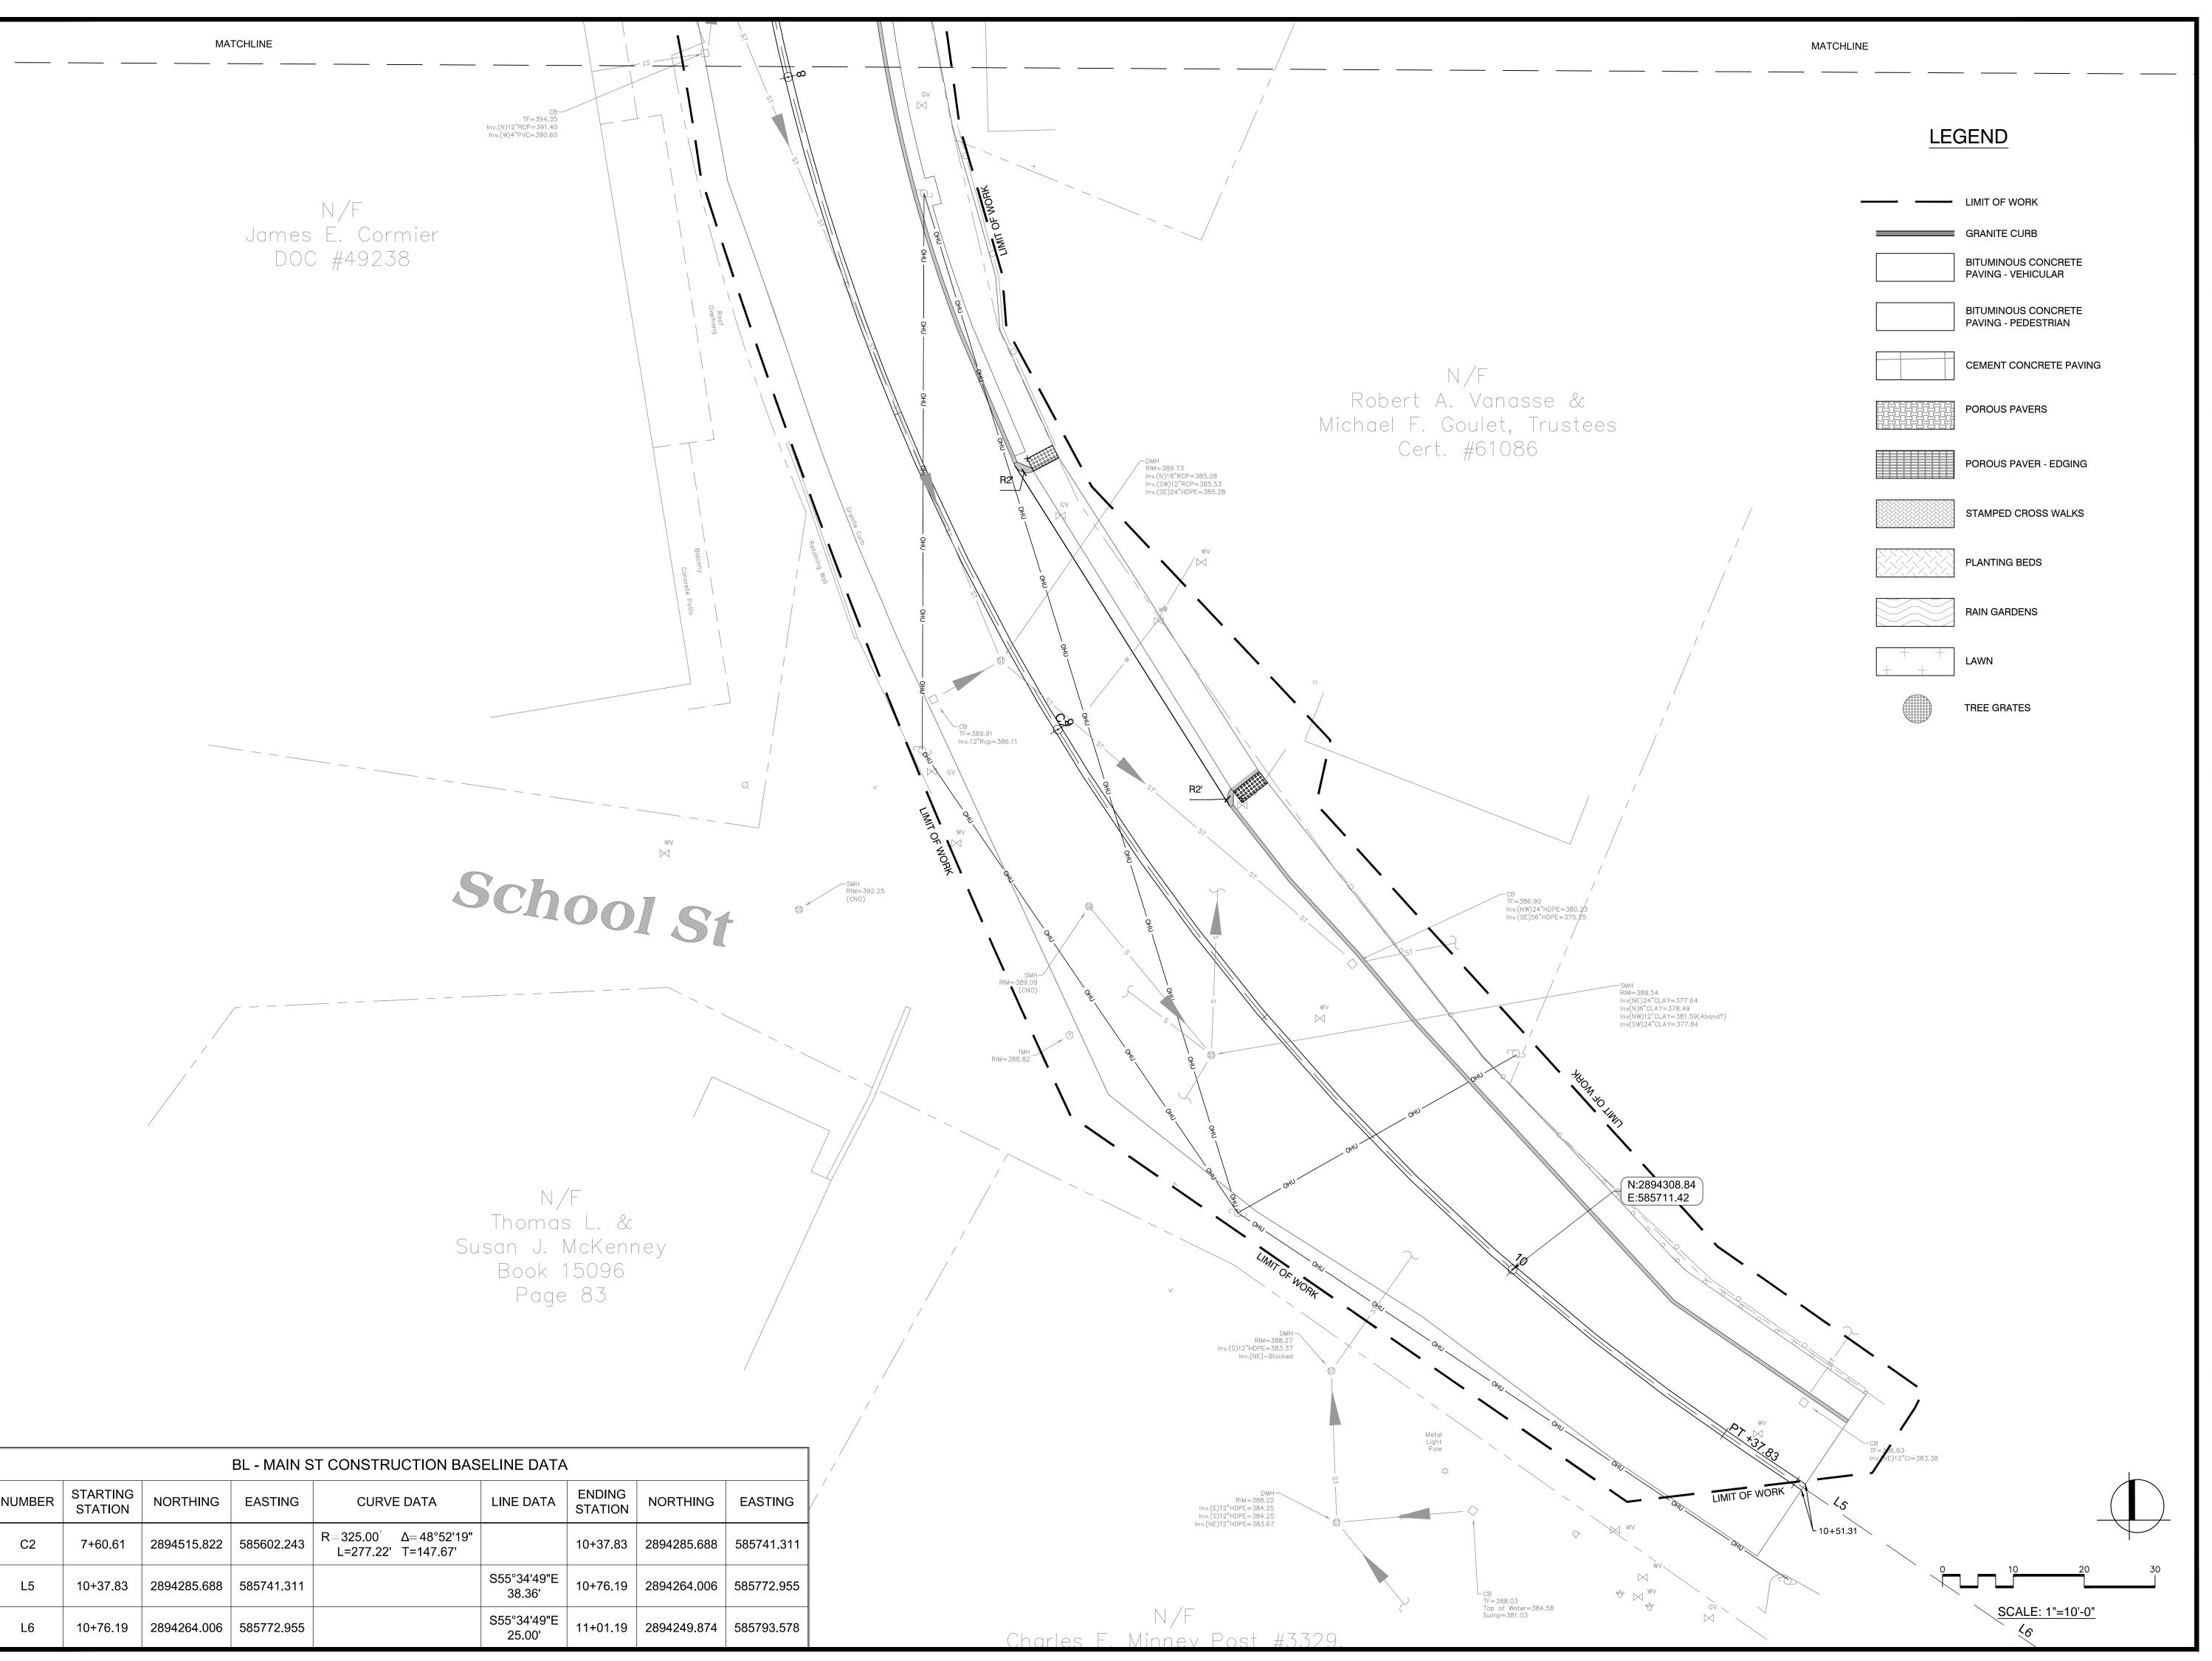
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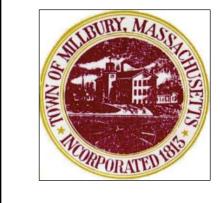


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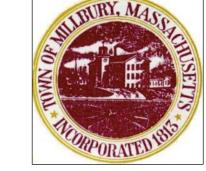
LAYOUT PLAN ENLARGEMENT

Sheet Number:

L4.07



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TOWN OF MILLBURY, MA



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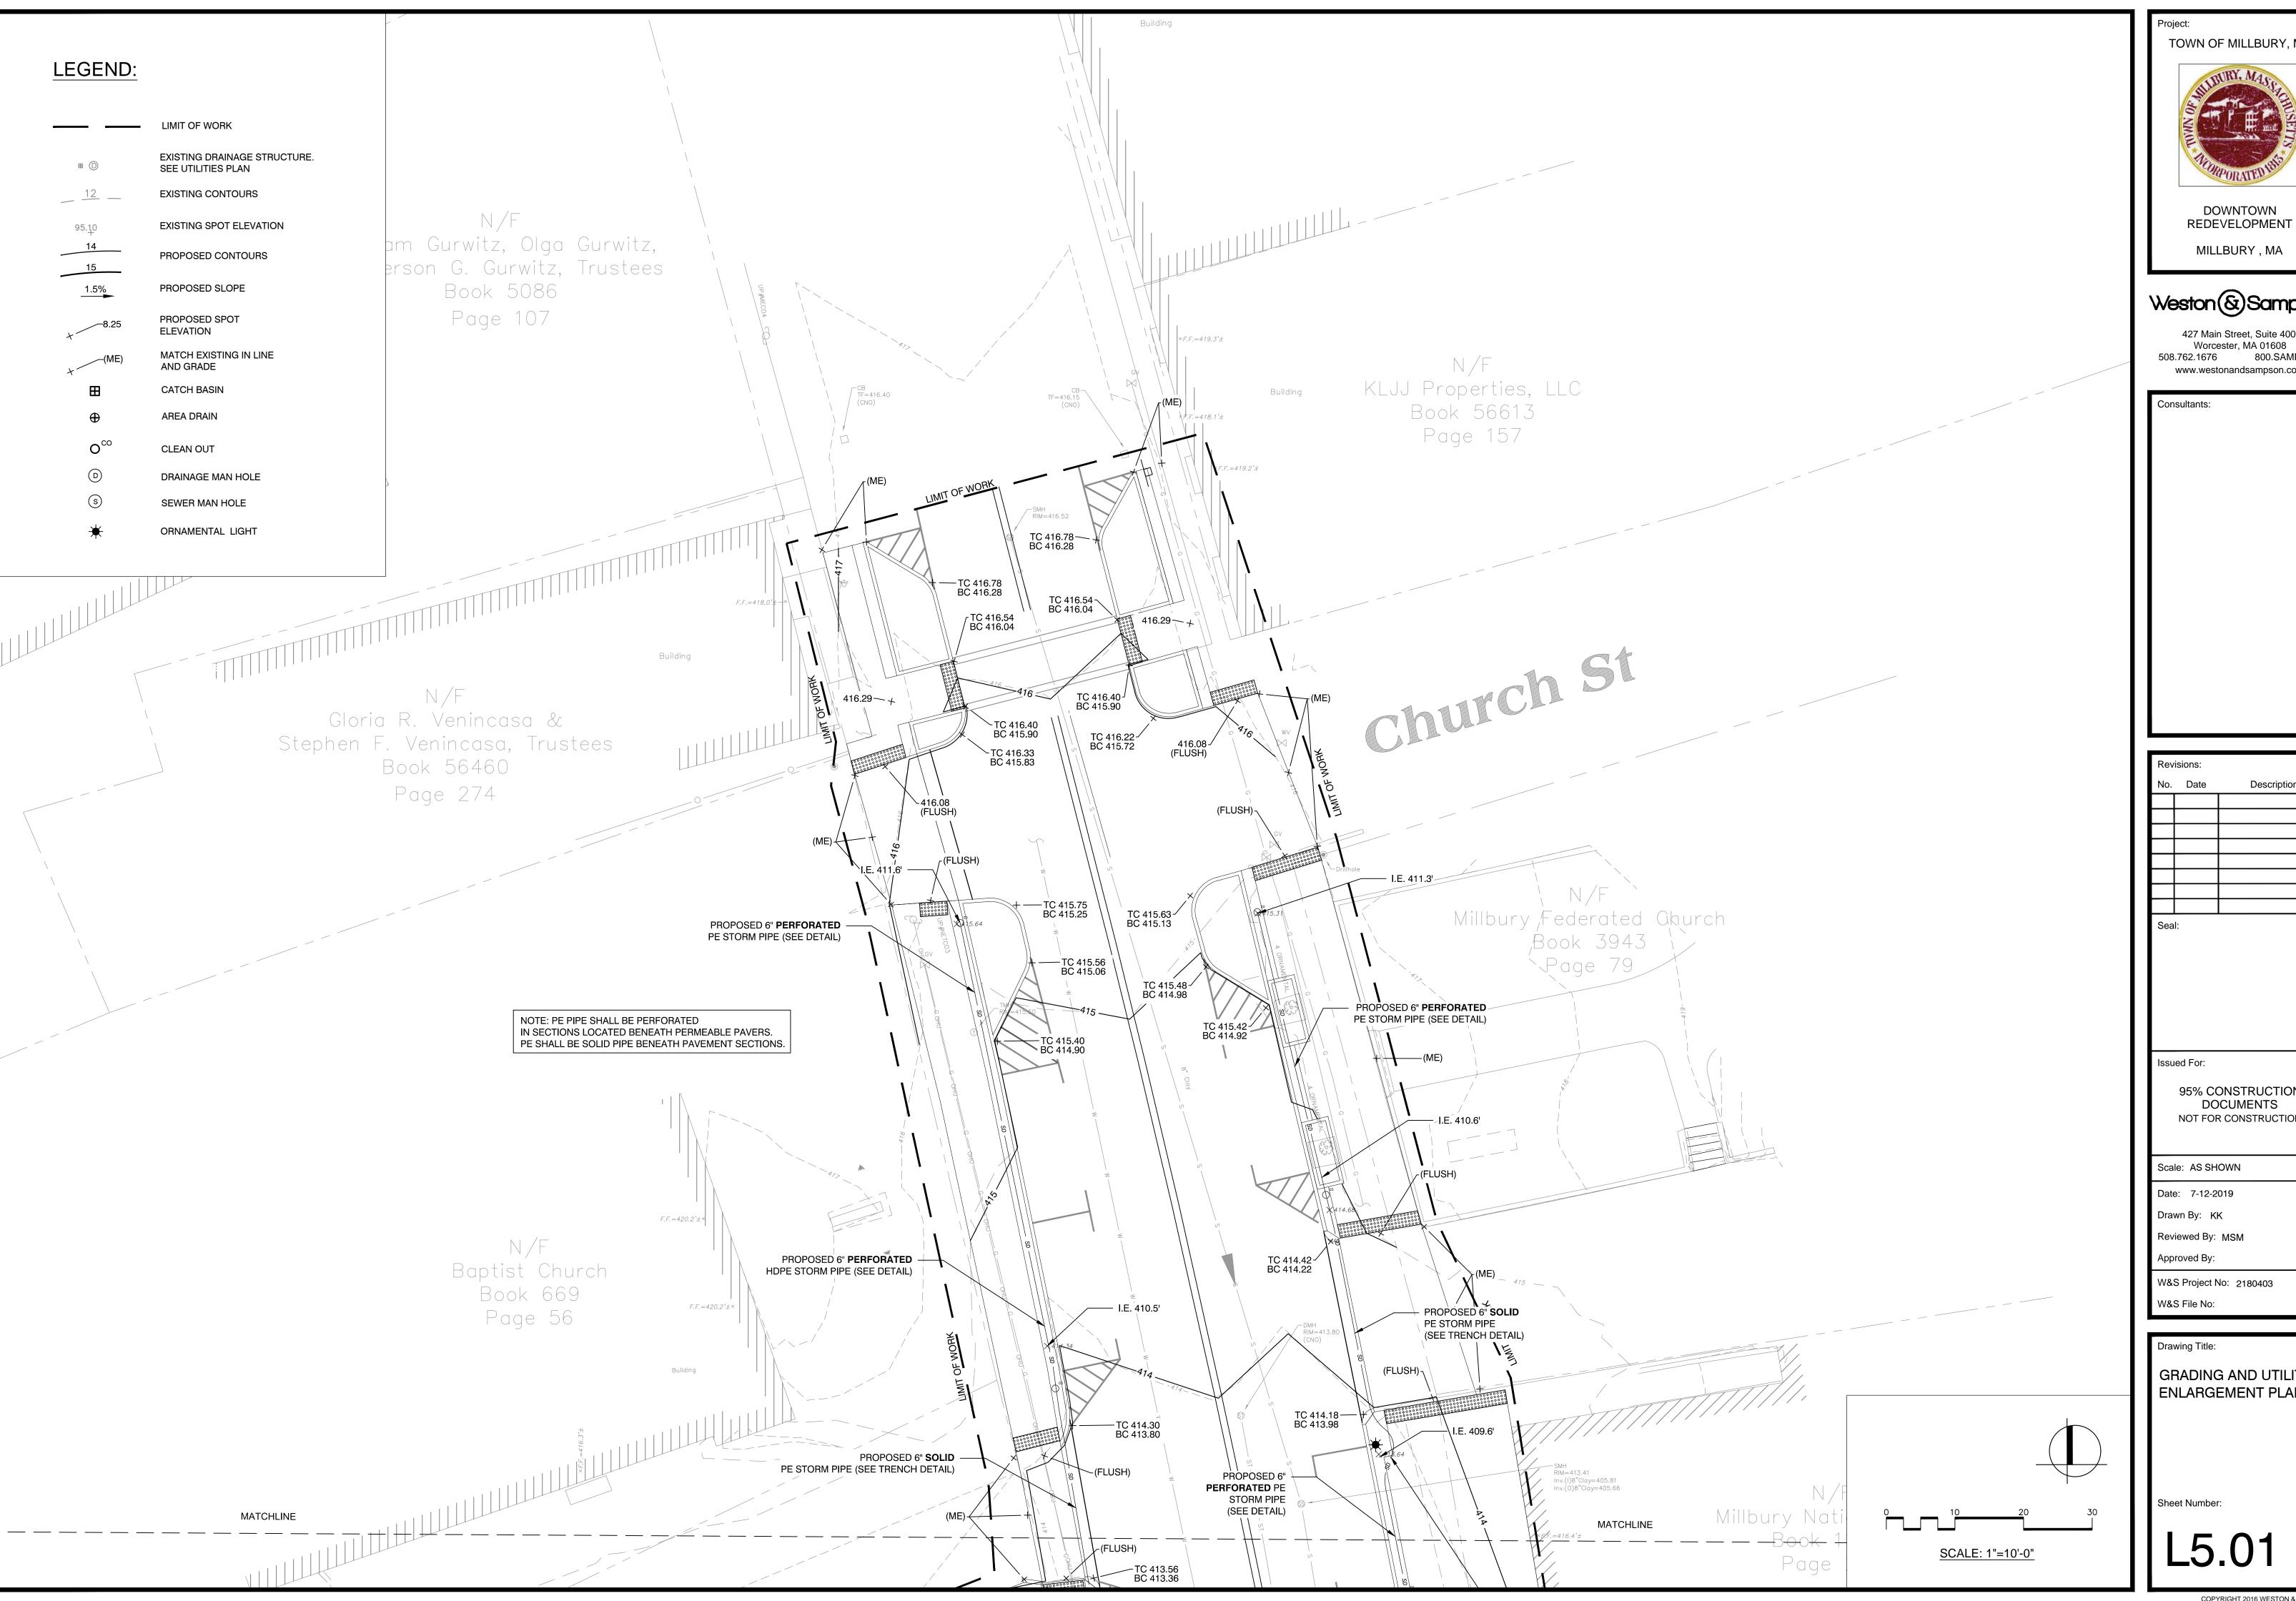
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Drawing Title:

OVERALL GRADING AND UTILITIES PLAN

Sheet Number:

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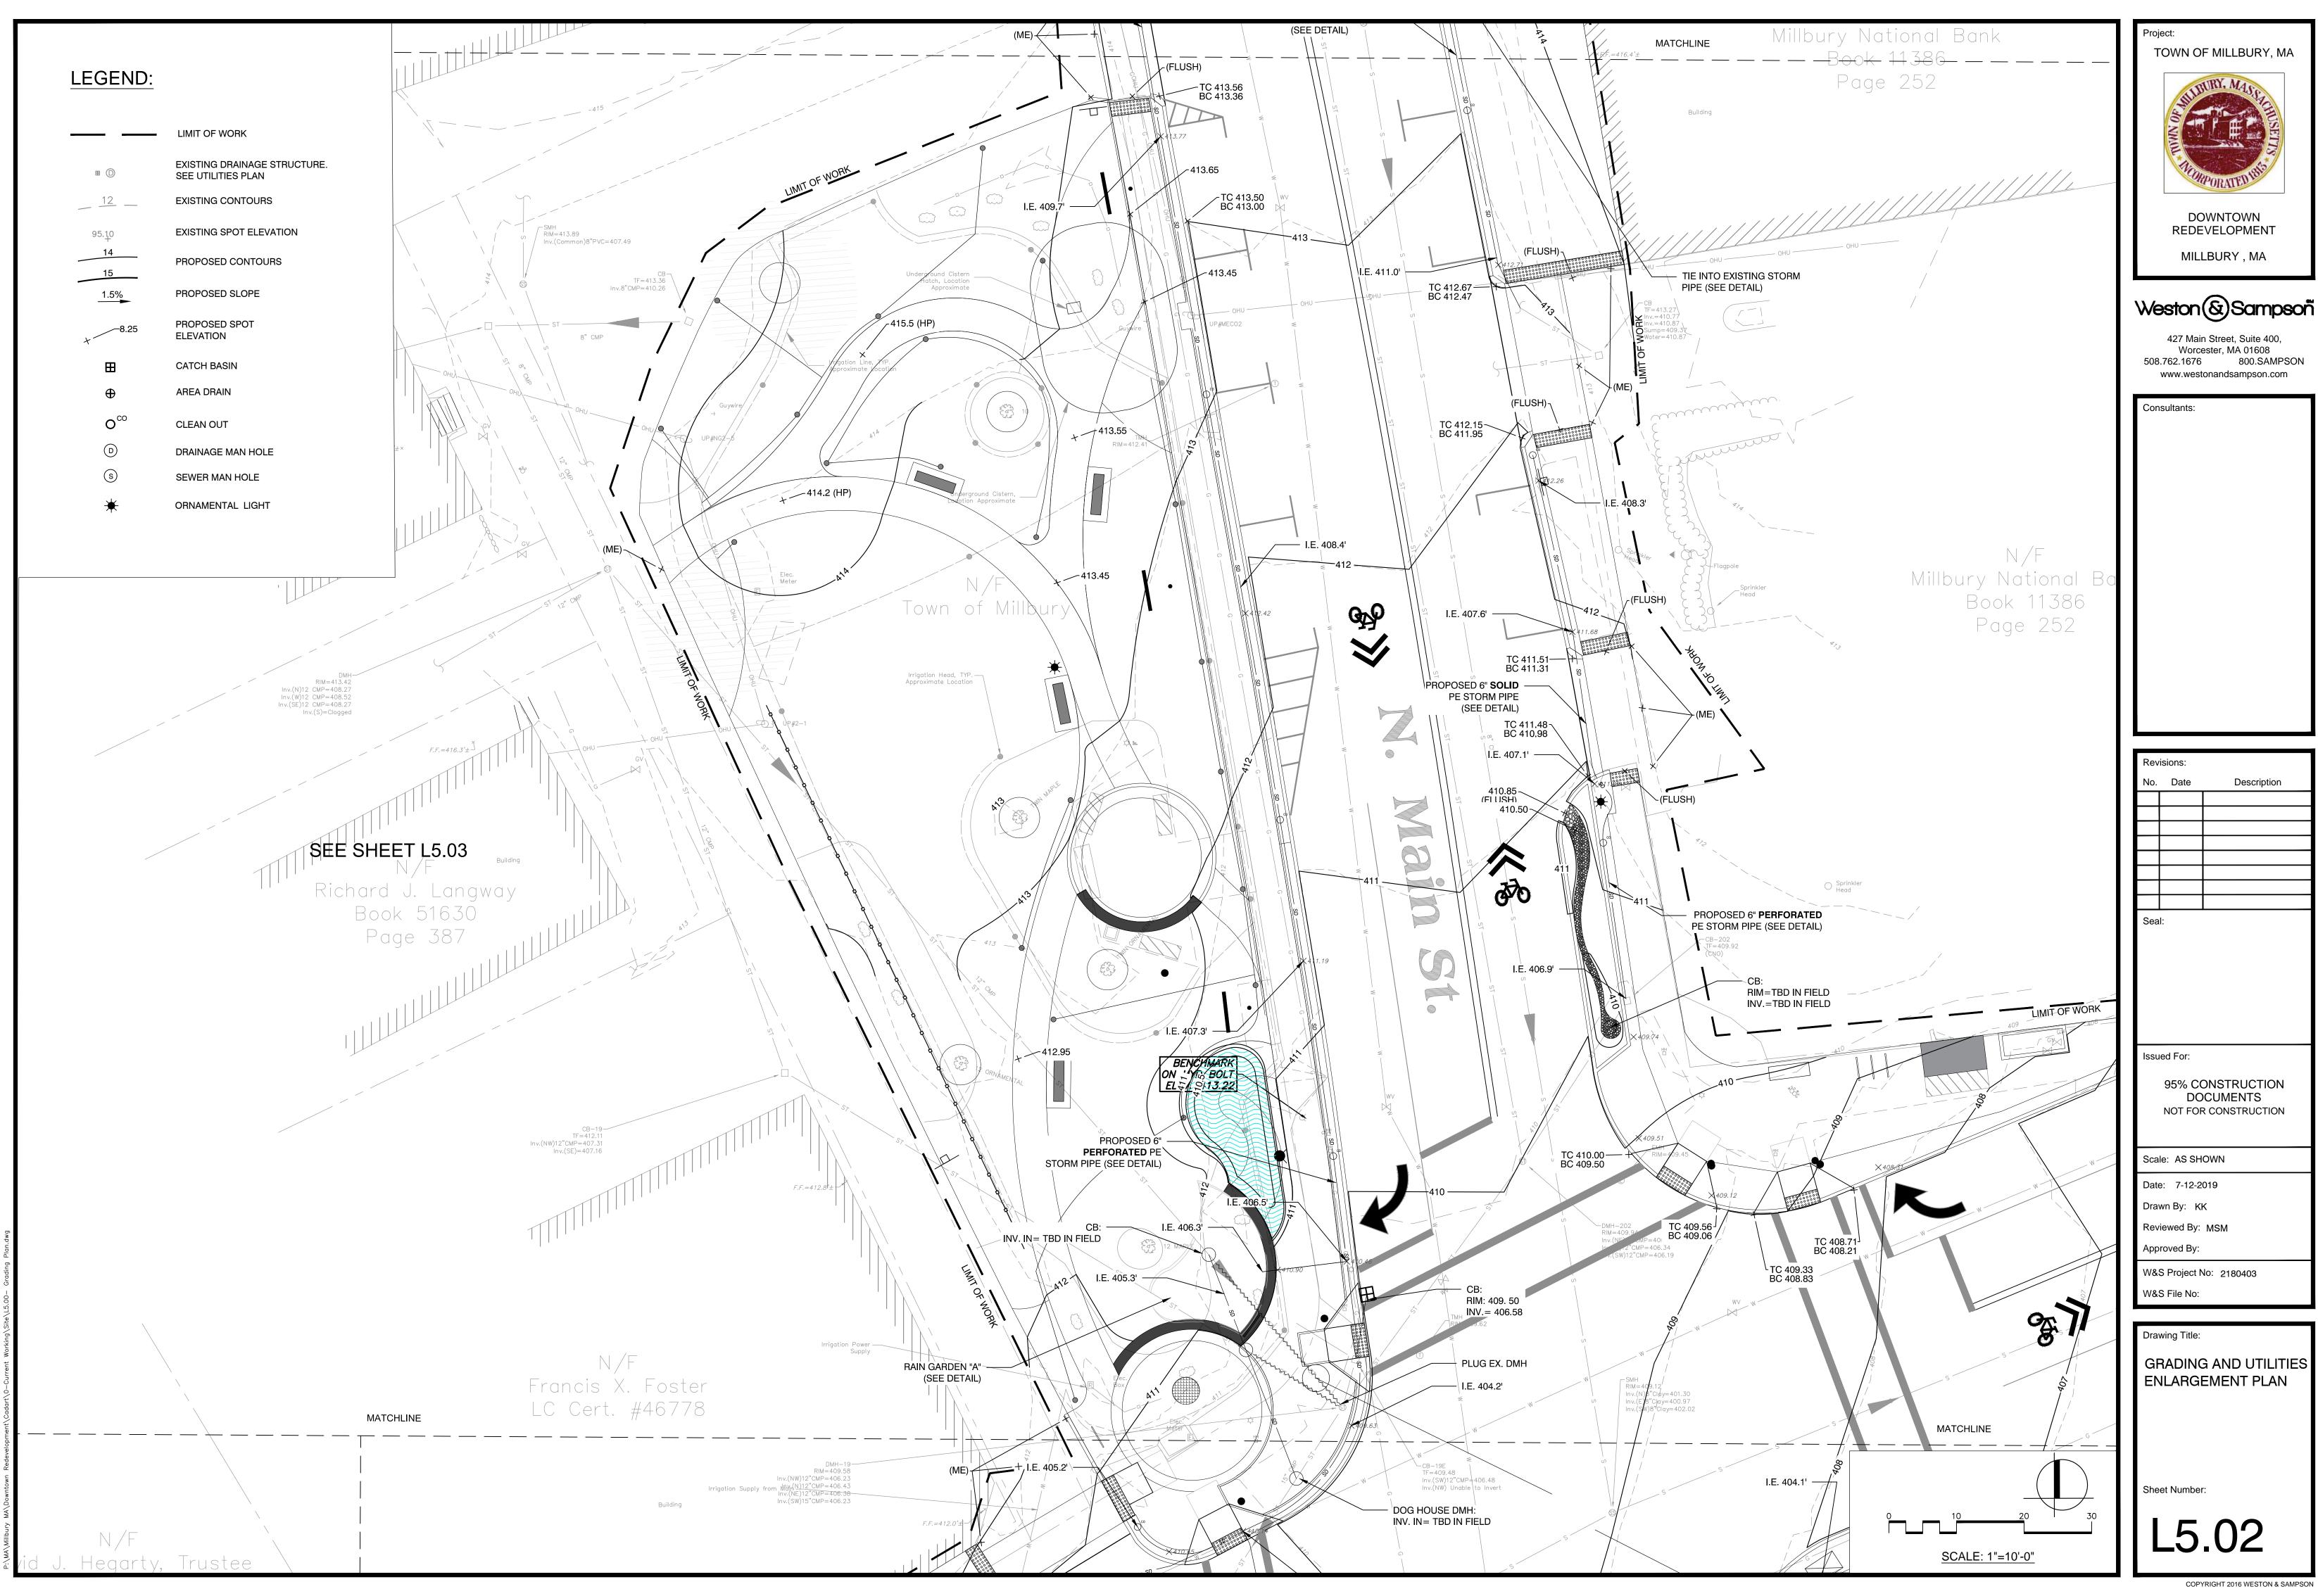
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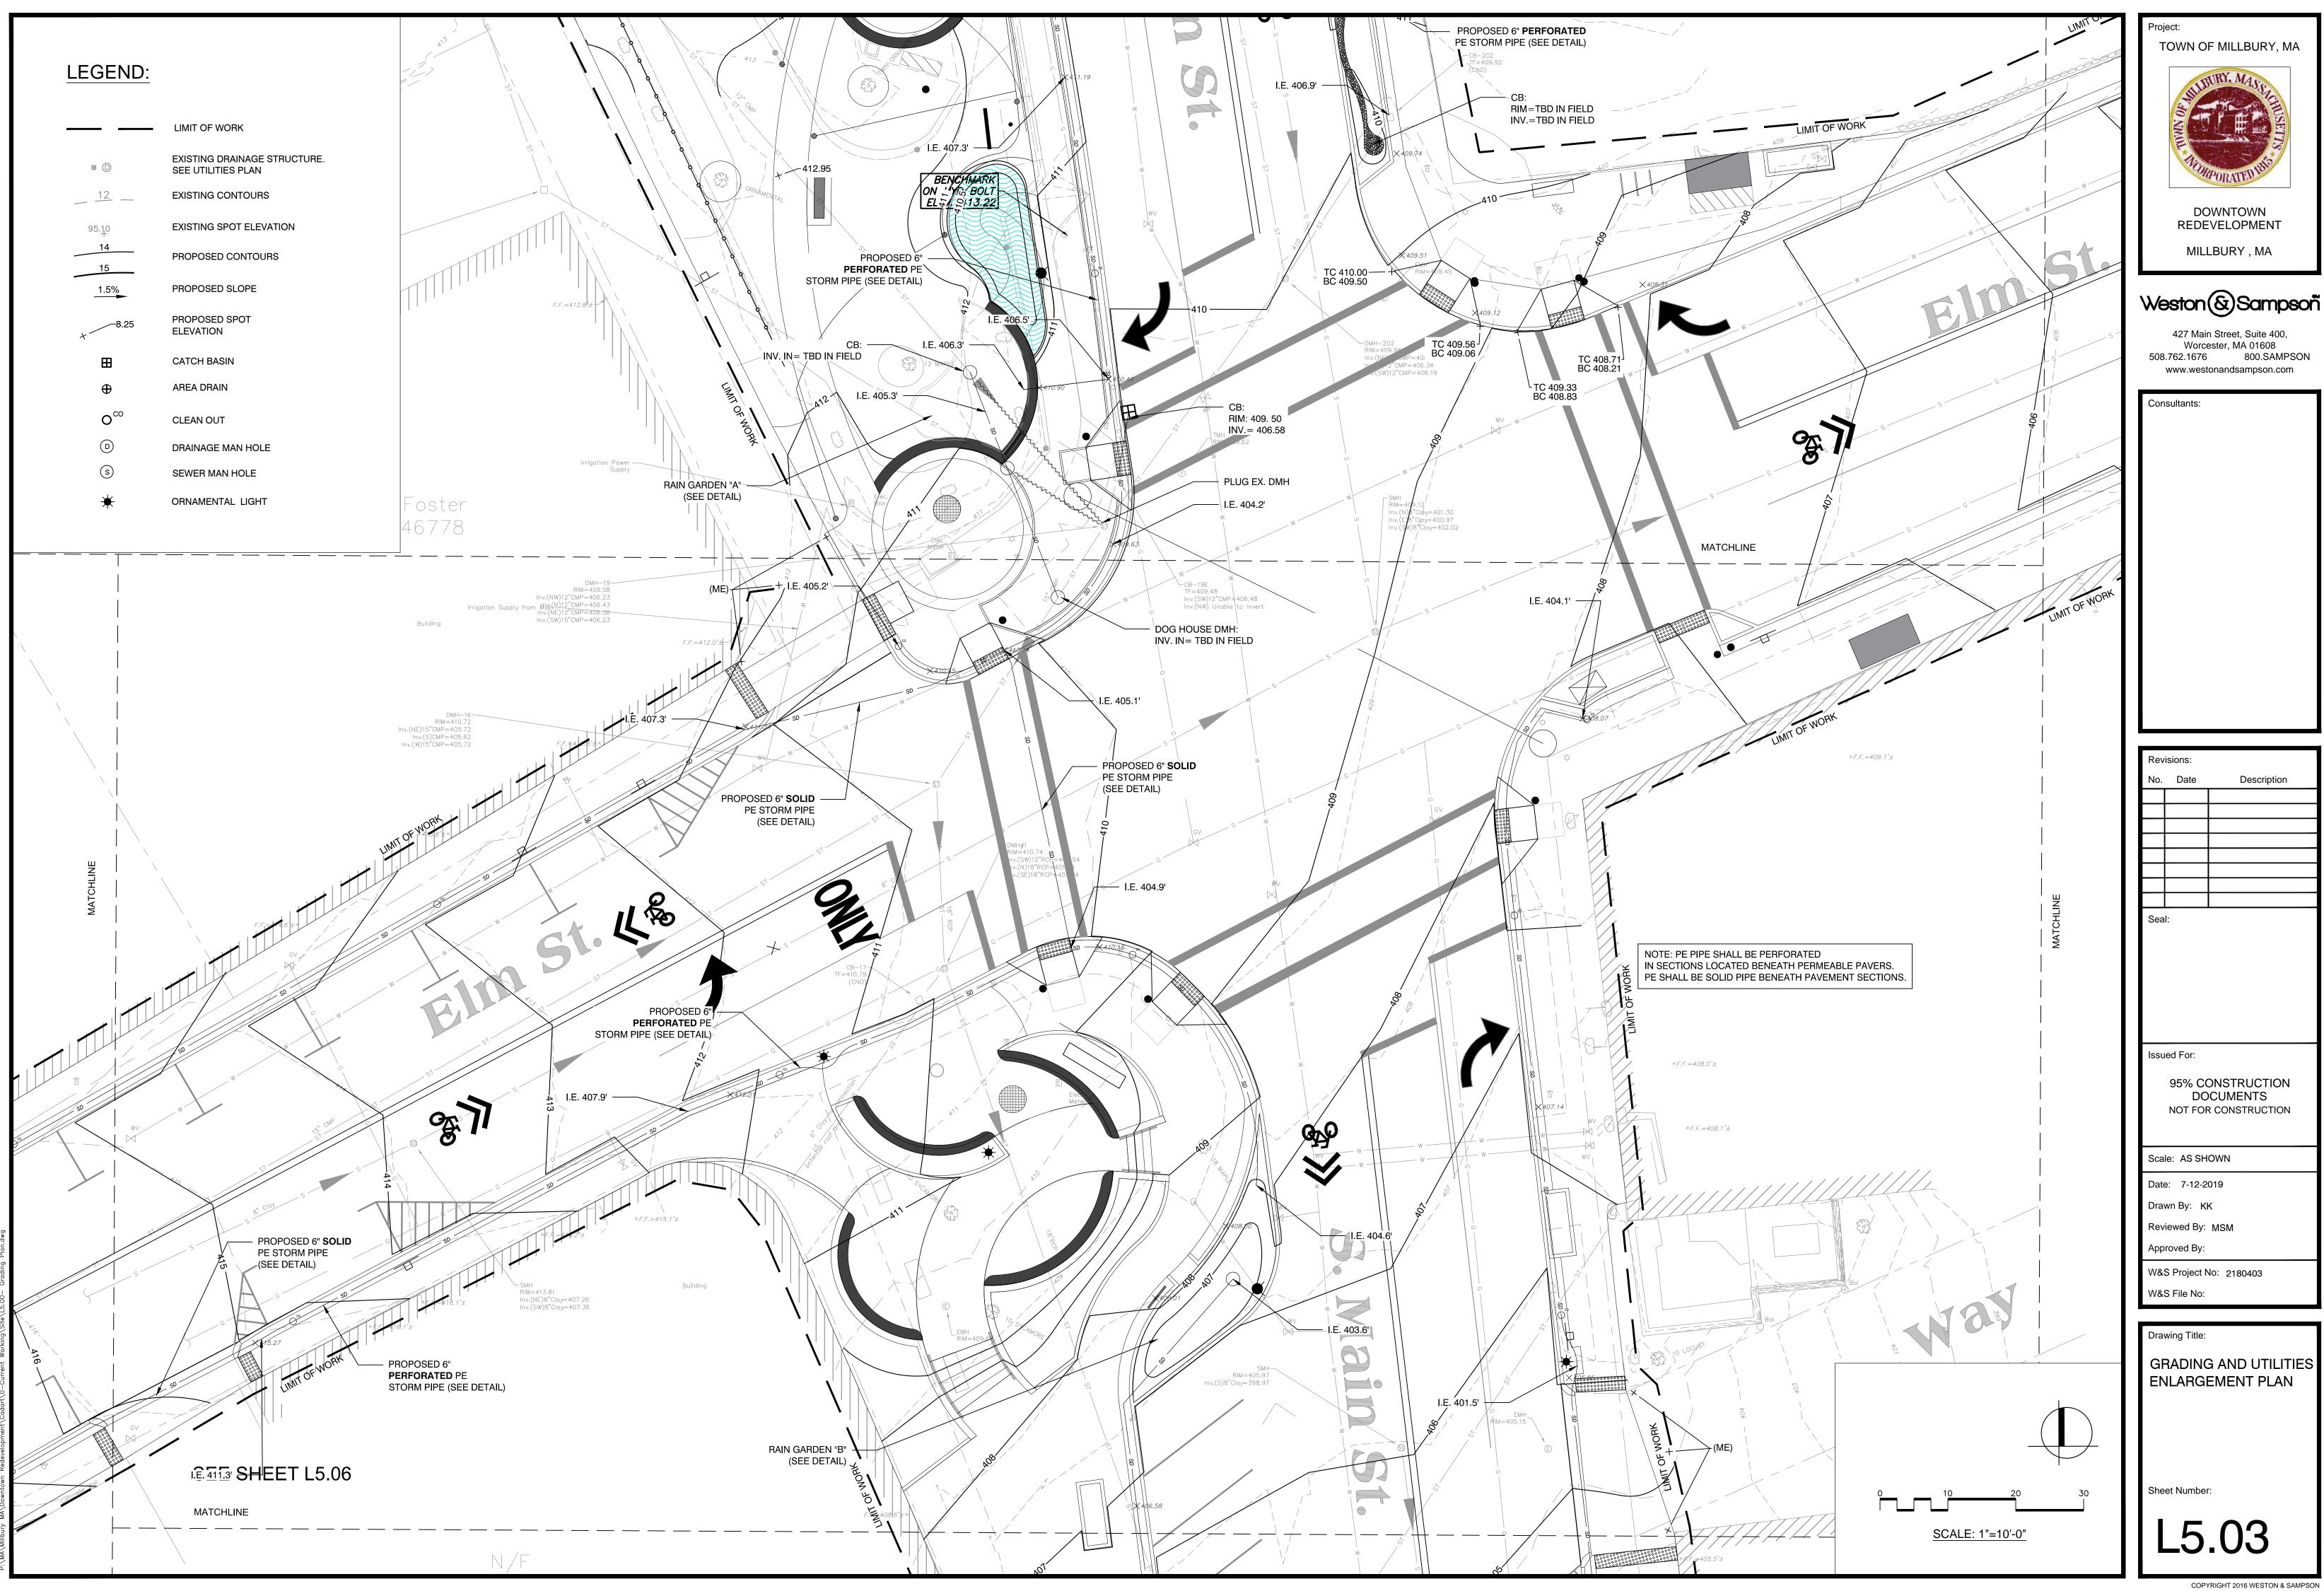
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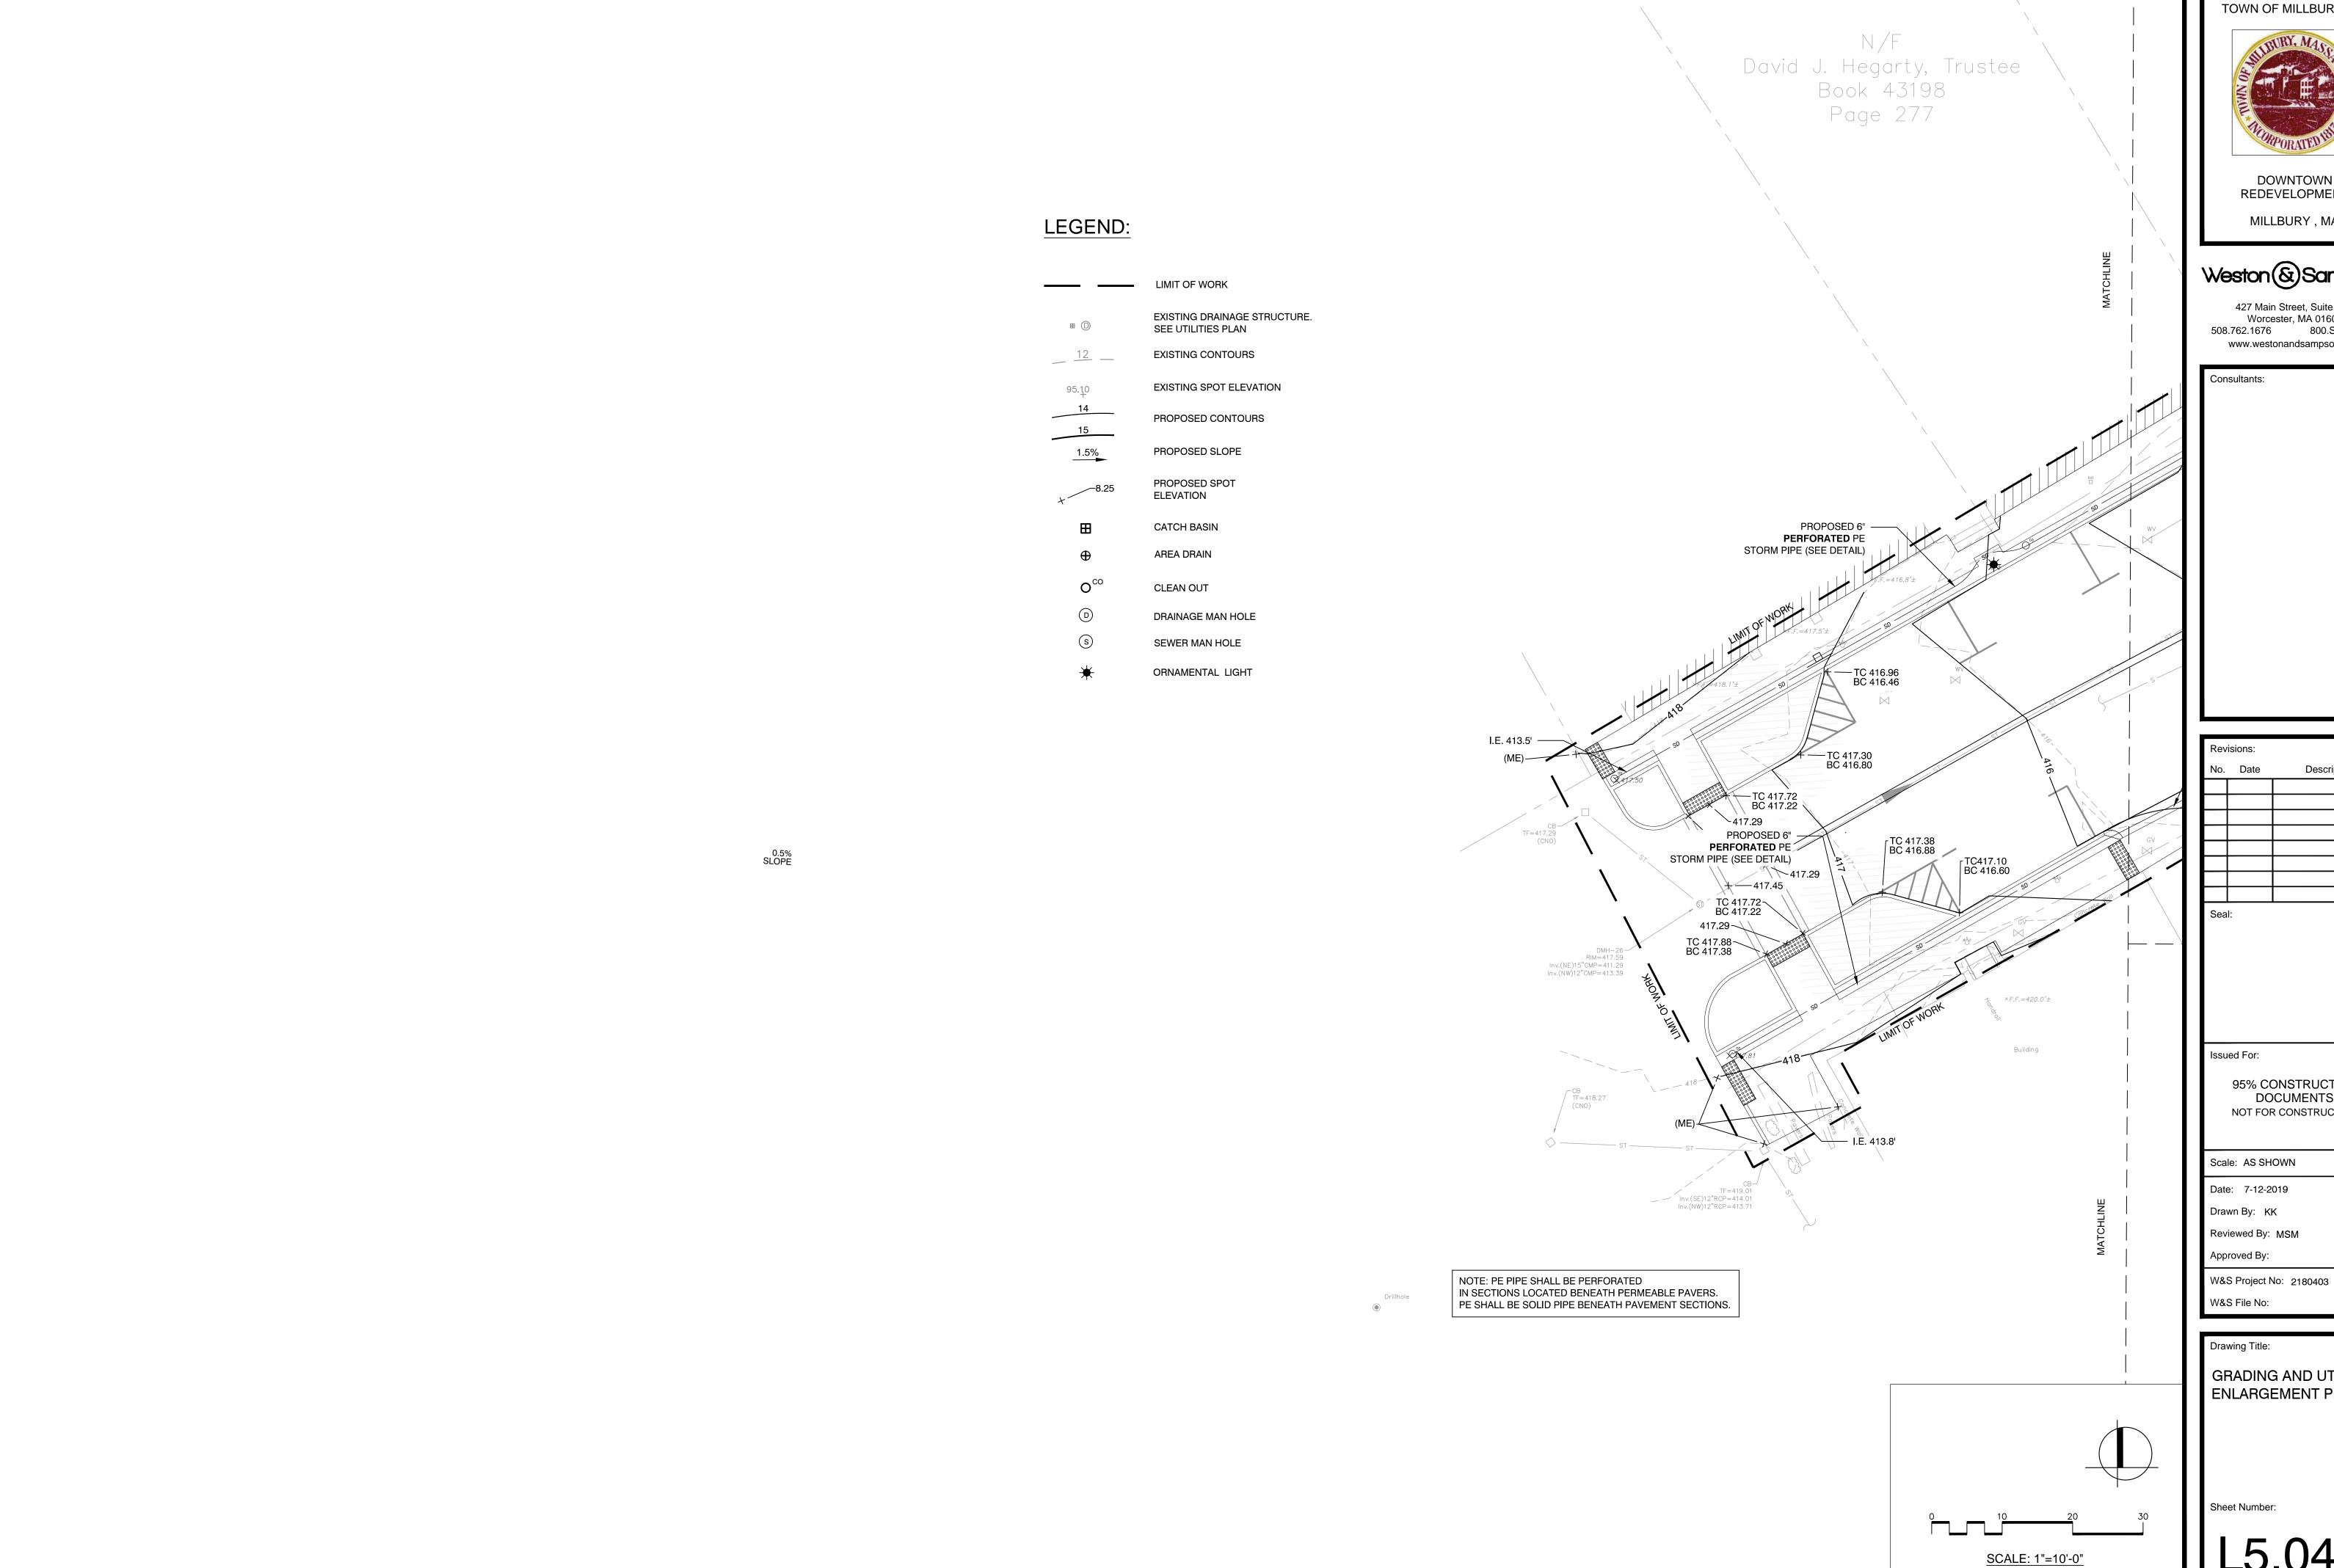
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GRADING AND UTILITIES ENLARGEMENT PLAN

L5.01







TOWN OF MILLBURY, MA DOWNTOWN REDEVELOPMENT MILLBURY, MA

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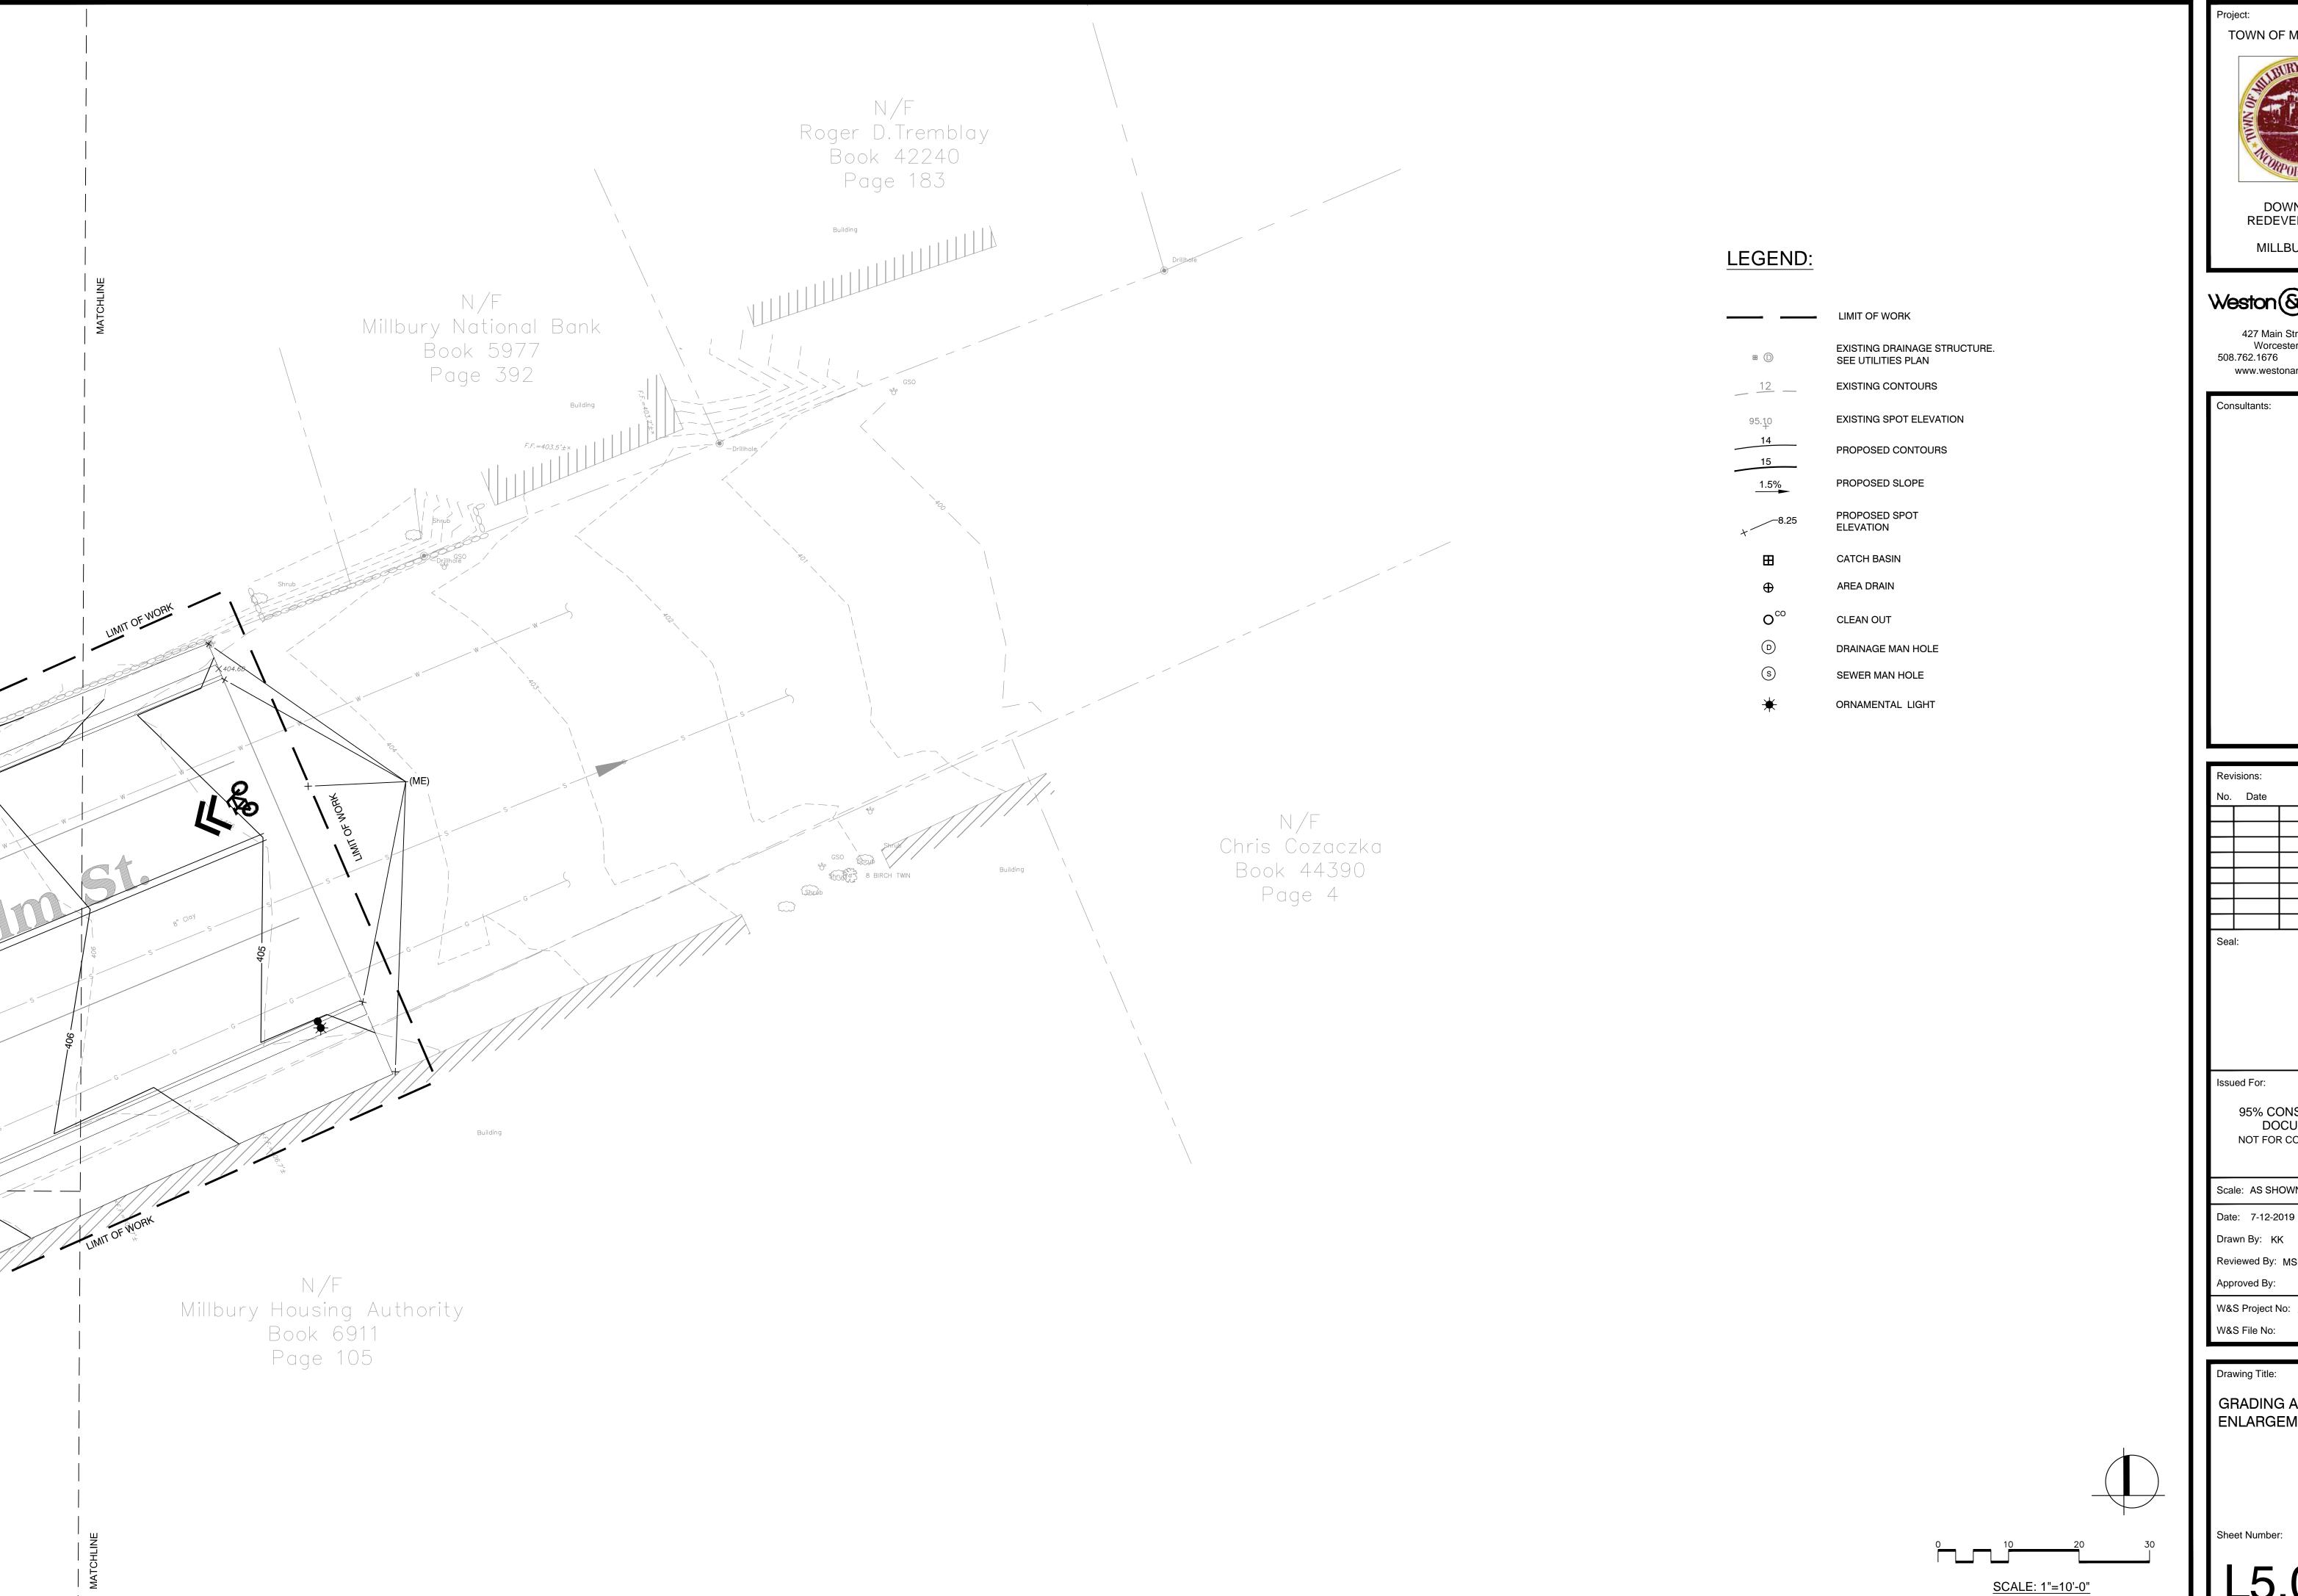
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Drawing Title:

GRADING AND UTILITIES ENLARGEMENT PLAN

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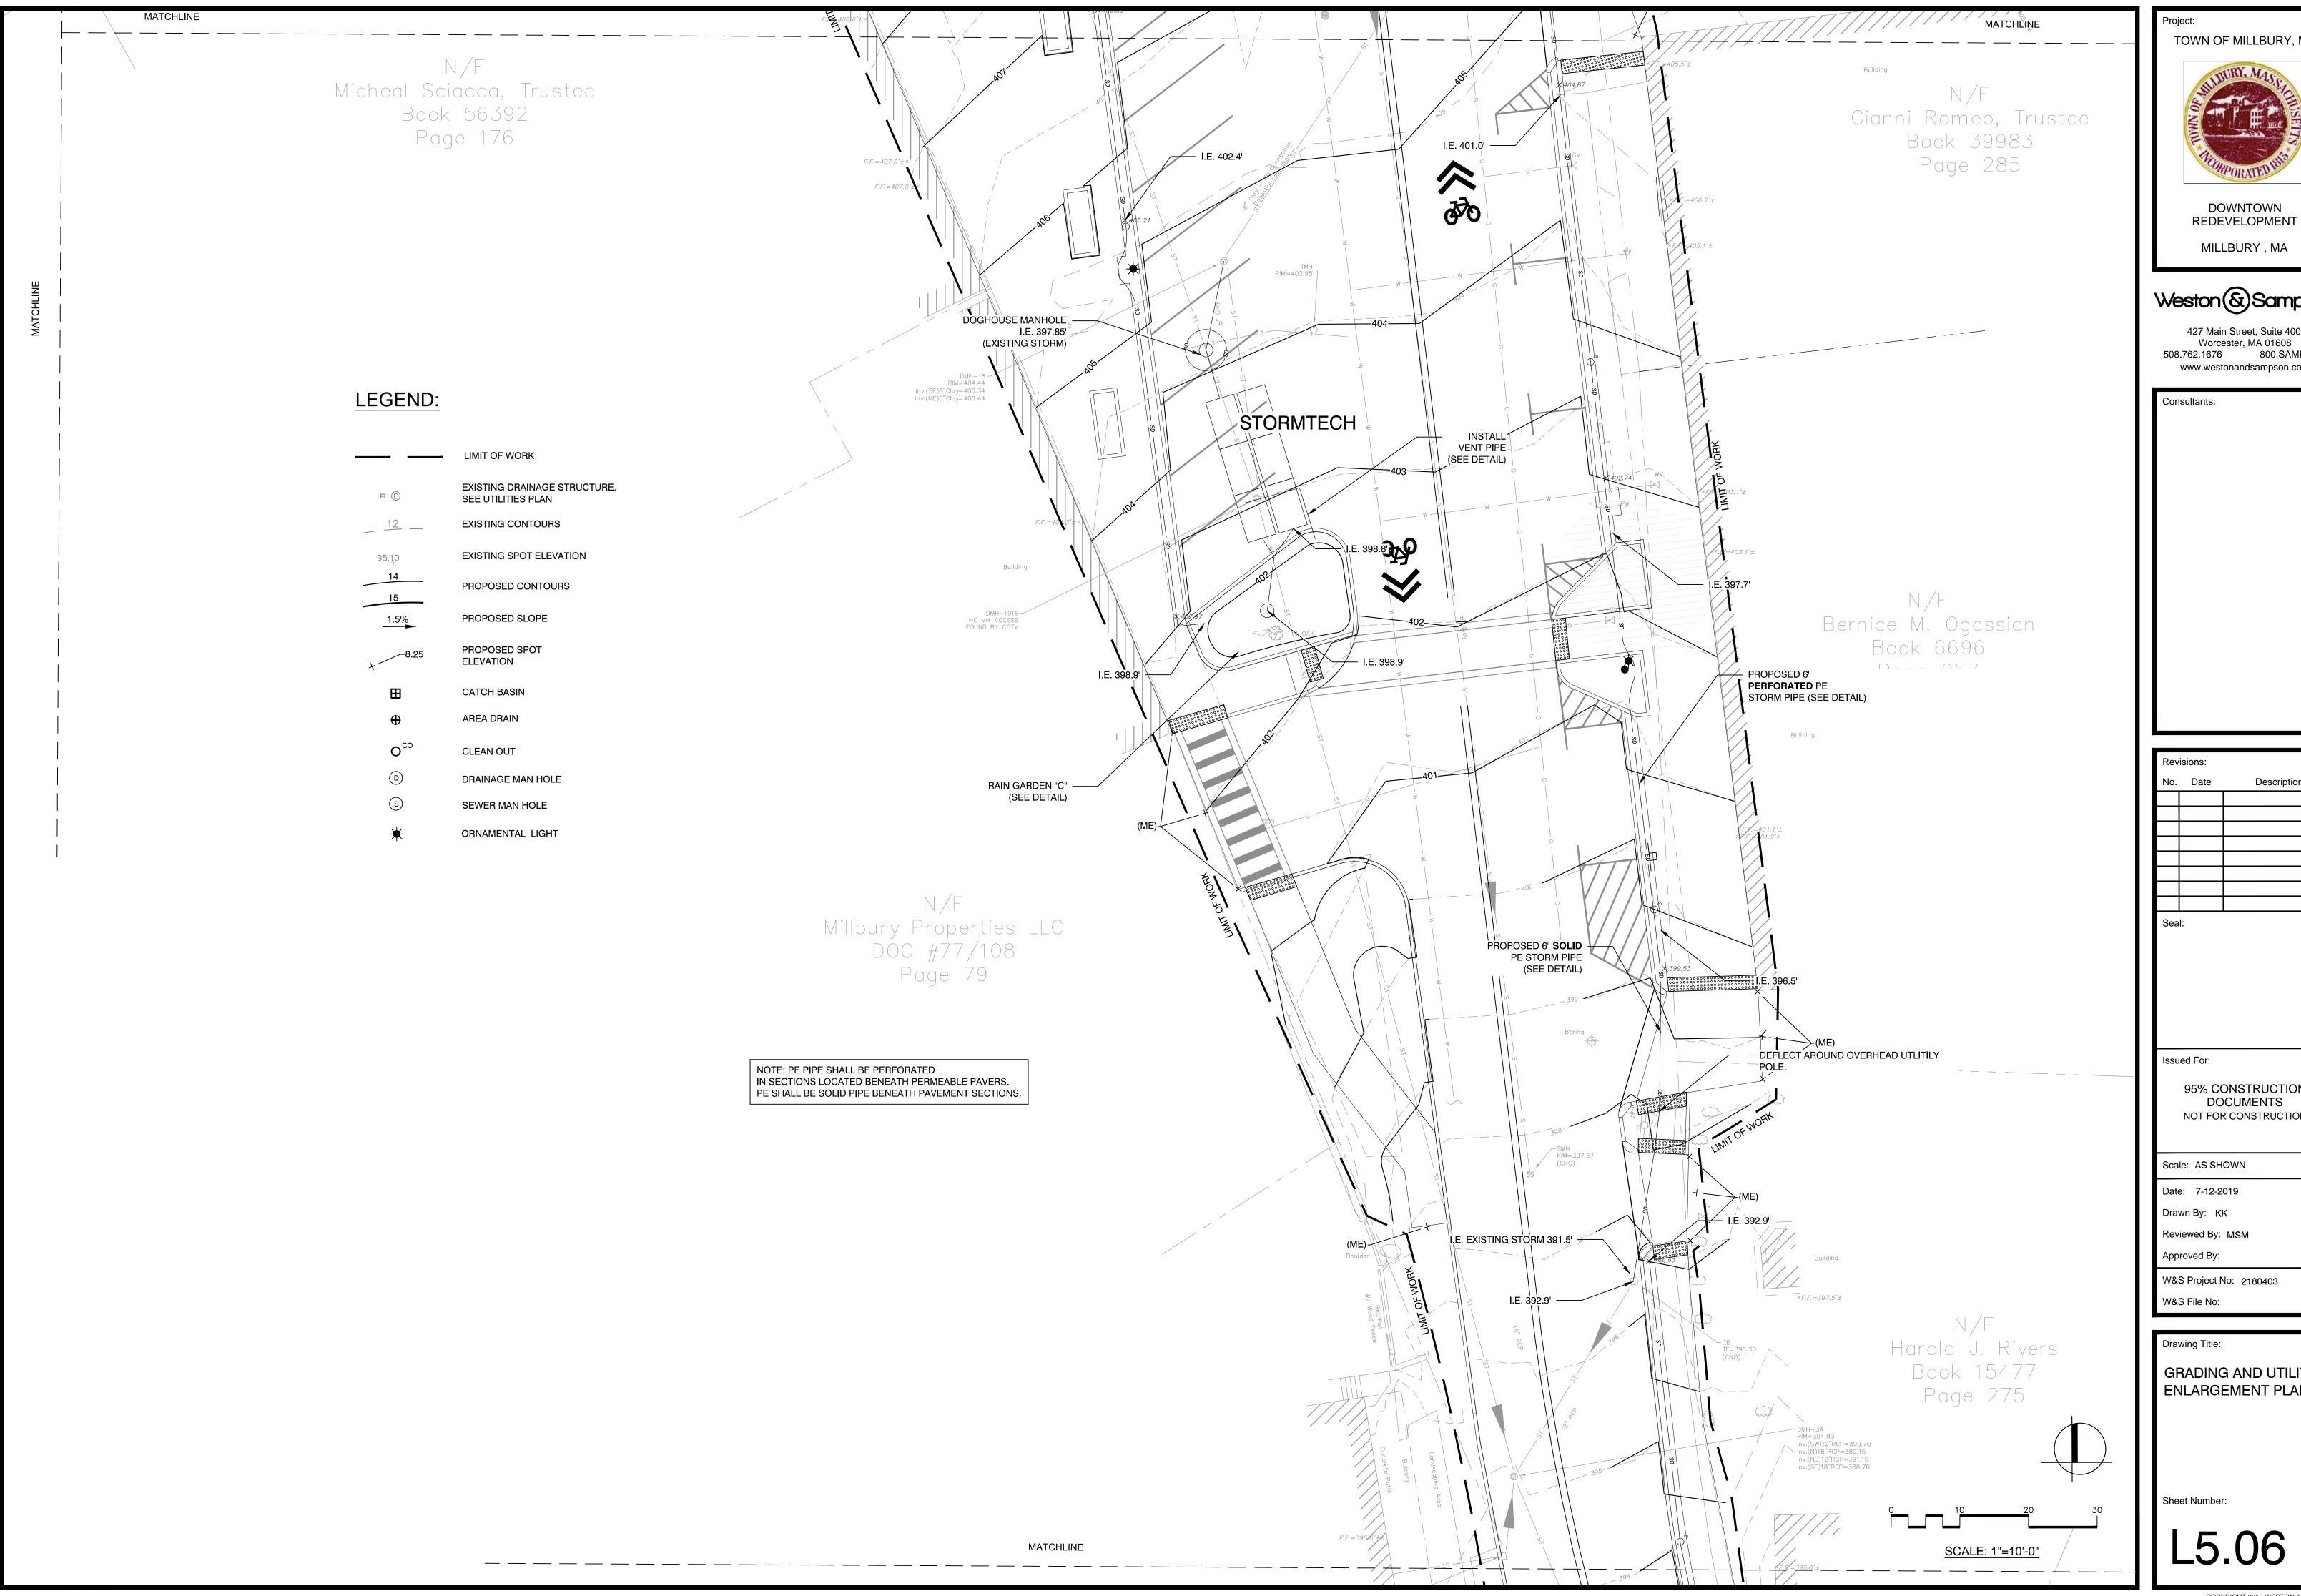
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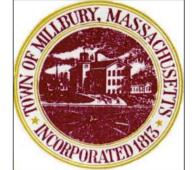
GRADING AND UTILITIES ENLARGEMENT PLAN

Sheet Number:

L5.05



TOWN OF MILLBURY, MA



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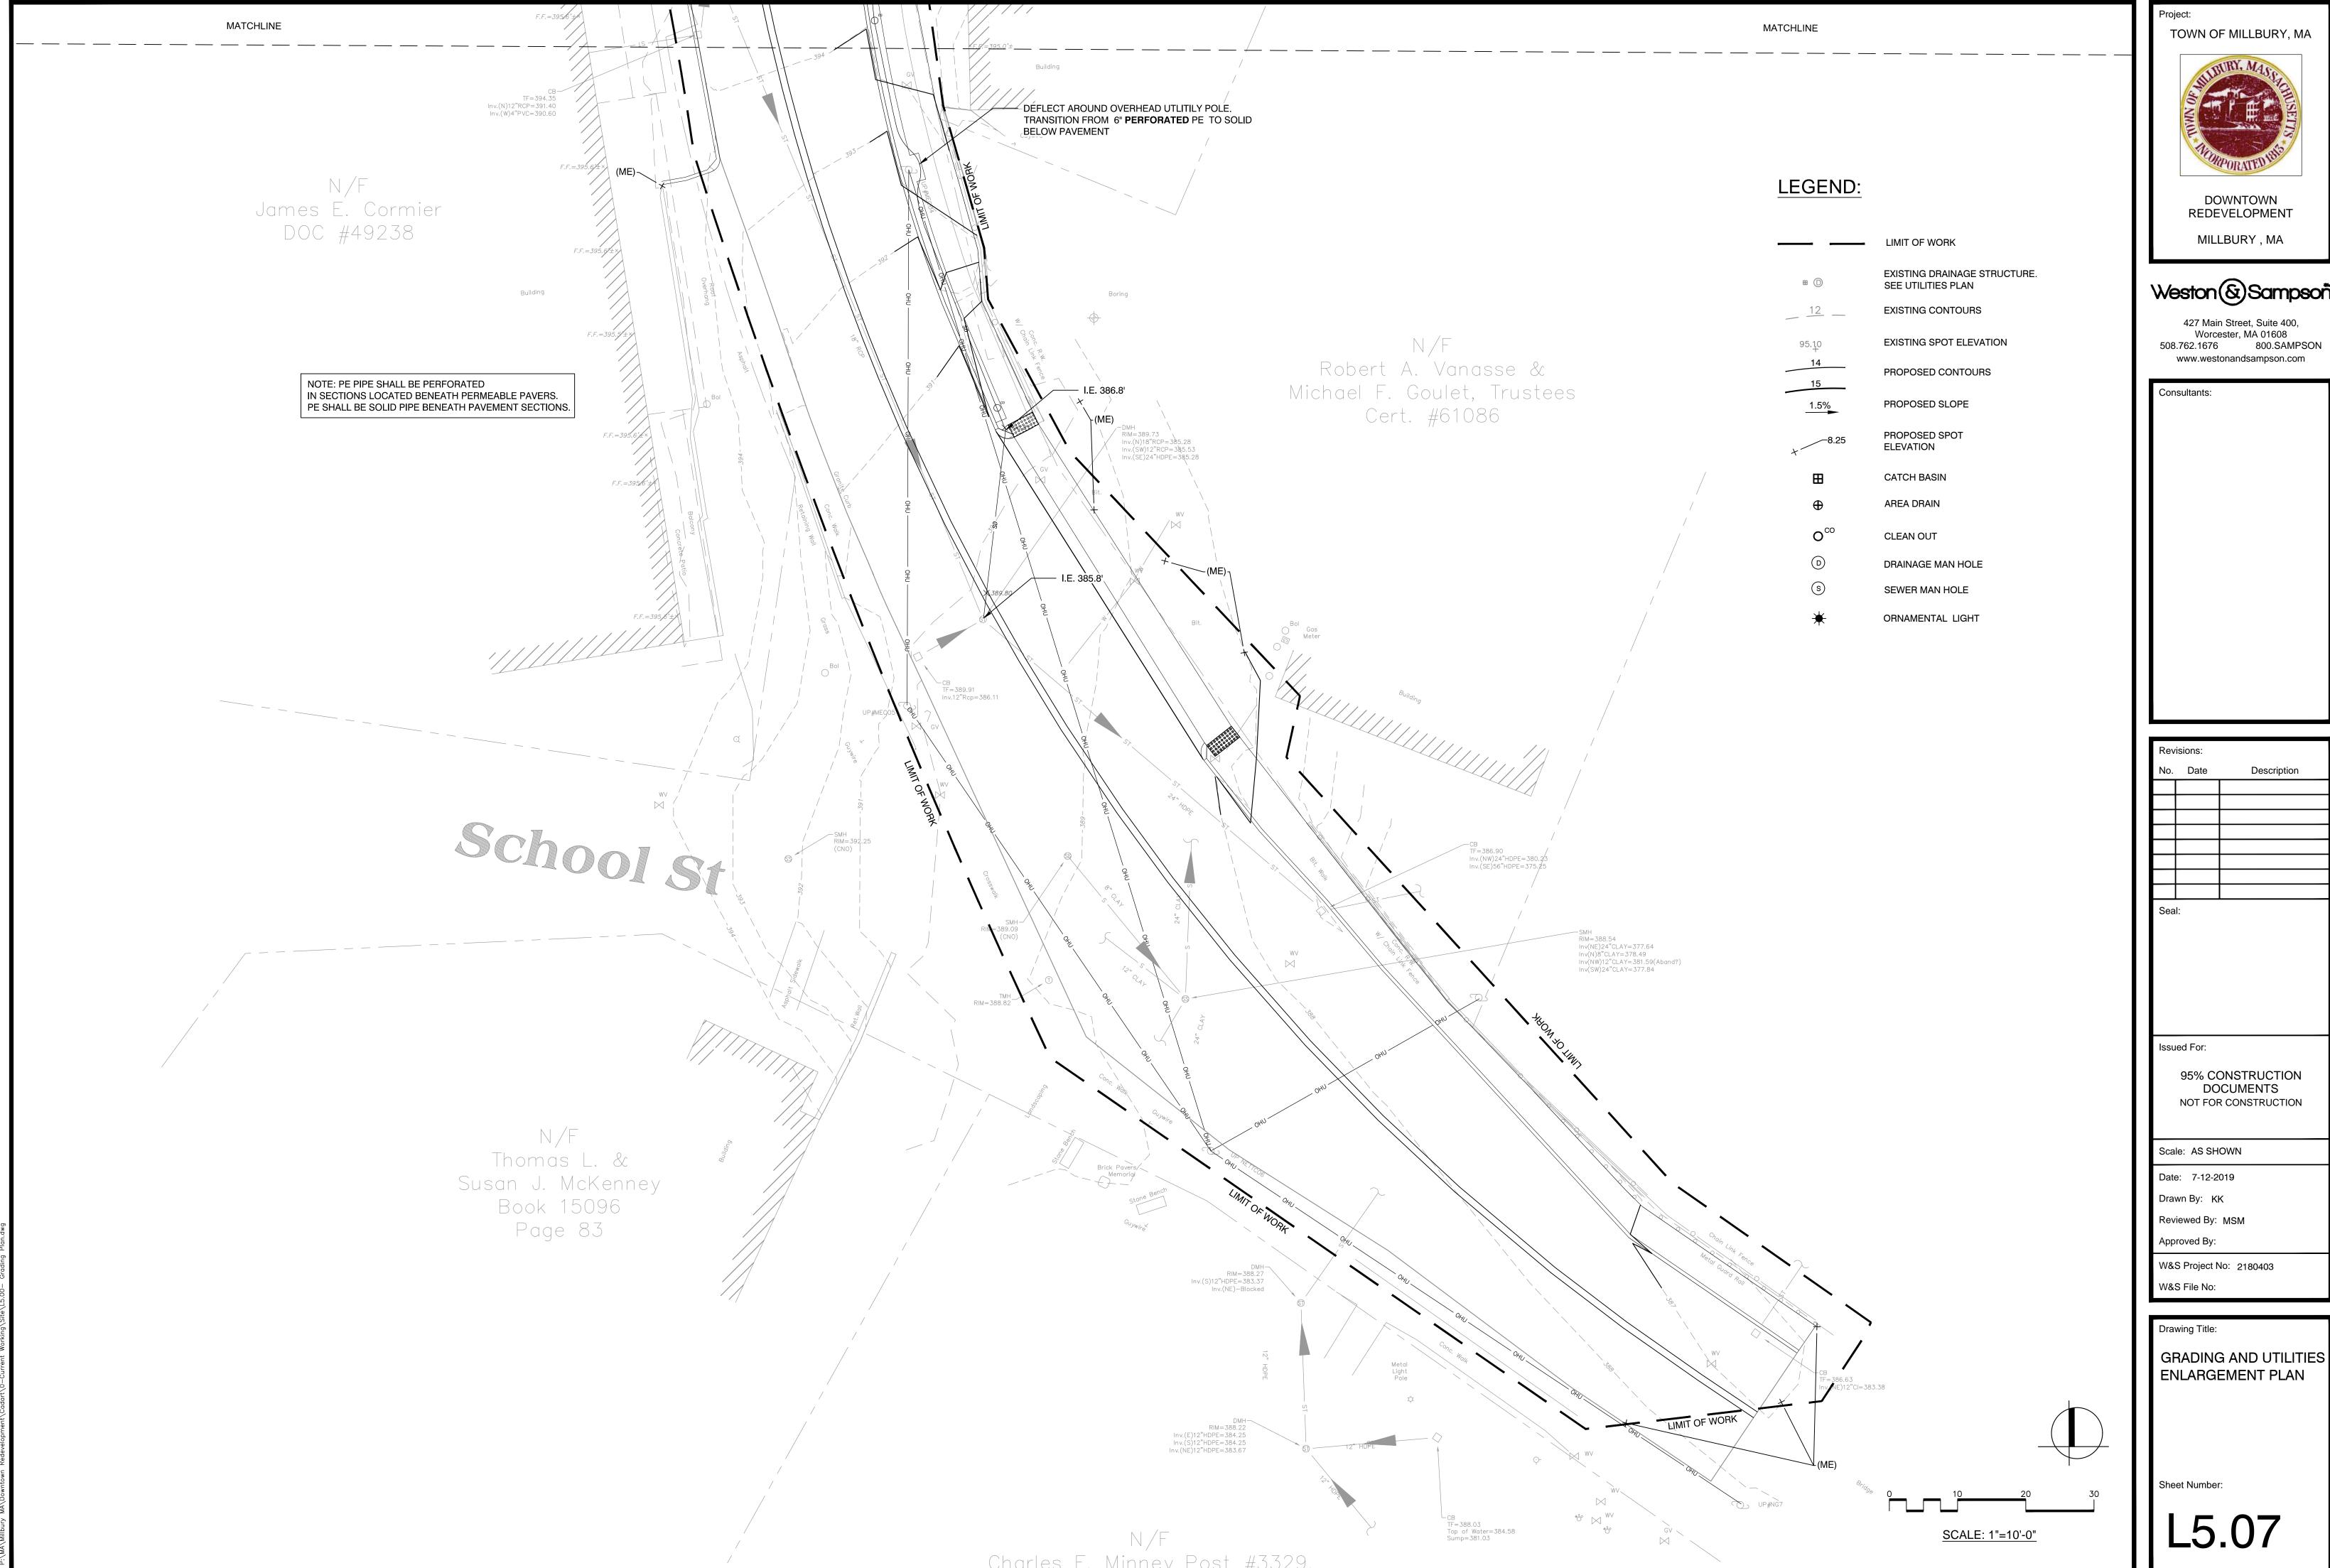
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GRADING AND UTILITIES ENLARGEMENT PLAN

L5.06



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		PLAN	NTIN	G SCHEDULE			
		DECIDU ABRV.		TREES  COMMON NAME	BOTANICAL NAME	SIZE	NOT
	SEE SHEET L7.01	AG		'Autumn Brilliance' SERVICEBERRY	AMELANCHIER X GRANDIFLORA 'Autumn Brillian	ce' 7-8' TALL* , B	SPACE 15-2
		CF GBA		PINK FLOWERING DOGWOOD  'Autumn Gold' MAINDENHAIR TREE	CORNUS FLORIDA ' Cherokee Princess'  GINKGO BILOBA 'Autumn Gold'		3&B SPACE 15-2 3&B SPACE 40' (
		GBA		'Princeton Sentry' COLUMNAR GINKGO	GINKGO BILOBA 'Princeton Sentry'		S&B SPACE 15' C
		PC		'Cleveland Select' FLOWERING PEAR	PYRUS CALLERYANA 'Cleveland Select'	3"-3.5" CAL.B	SPACE 35' C
		TC ZS	3	'Greenspire' LITTLELEAF LINDEN	TILIA CORDATA 'Greenspire'		3&B SPACE 35' C 3&B SPACE 30-5
		SHRUB	BS '	'Village Green' JAPANESE ZELKOVA	ZELKOVA SERRATA 'Village Green'	3 -3.5 CAL.B	XB OF AGE 30-0
	Church St	AM		'Low Scape Mound' BLACK CHOKEBERRY	ARONIA MELANOCARPA 'Low Scape Mound'		SPACE 2'+/-
				Hummingbird' SWEETSPIRE  'Arctic Fire' RED TWIG DOGWOOD	CLETHRA ALNIFOLIA 'Hummingbird'  CORNUS STOLONIFERA 'Farrow'		SPACE 4' O. SPACE 3'-4'
		DN	3.	1 'Night Glow' DWARF BUSH HONEYSUCKLE	DIERVILLA SPLENDENS 'EI Madrigal'	#2 CONT., B&	SPACE 3' O.
		DS JH		VARIEGATED DWARF BUSH HONEYSUCKLE HUGHES SPREADING JUNIPER	DIERVILLA SESSILIFOLIA 'Cool Splash'  JUNIPERUS HORIZONTALIS 'Hughes'		SPACE 3' O. SB SPACE 5' O.
		RA		4 SPREADING FRAGRANT SUMAC	RHUS AROMATICA 'Gro-Low'		SB SPACE 4' O.
		SX		'Bloomerang Dwarf Pink' REBLOOMING LILAC			SPACE 3-4'
	SEE SHEET L7.02	WF		'Spilled Wine' WEIGELA 'Sonic Bloom Pink' WEIGELA	WEGEILA FLORIDA 'Spilled Wine' WEIGELA FLORIDA 'Sonic Bloom Pink'		SPACE 2.5'+ SPACE 5' O.
		PEREN	NNIALS	S			
		AS AX #		BASKET-OF-GOLD  'Chantilly Lace' COMPACT GOATSBEARD	AURINIA SAXATILIS  ARUNCUS X 'Chantilly Lace'		SPACE 1.5'+  SB SPACE 3'+/-
		CX		FEATHER REED GRASS	CALAMAGROSTIS X ACUTIFLORA 'Karl Foerster'		SPACE 3'+/-
		. \		'Pardon My Cerise' DWARF BEE BALM	MONARDA DIDYMA 'Pardon My Cerise' (RED)		SPACE 1.5'
		NF PA		<ul><li>'Walkers Low' CATMINT</li><li>'Denim &amp; Lace' DWARF RUSSIAN SAGE</li></ul>	NEPETA X FAASSENII 'Walkers Low' PEROVSKIA ATRIPLICIFOLIA 'Denim & Lace'		SPACE 2.5' SPACE 3'+/-
		PAM	36	BLACK FLOWERING FOUNTAIN GRASS	PENNISETUM ALOPPECUROIDES 'Moudry'	#2 CONT., B&	SPACE 3'+/-
	SEE SHEET L7.03	SR#		'Lemony Lace' ELDERBERRY  Autumn Fire STONECROP	SAMBUCUS RACEMOSA 'Lemony Lace'  SEDUM SPECTABILE 'Autumn Fire'		SPACE 4-5'+ SB SPACE 2'+/-
		100	3		GARDEN APPROPRIATE	#2 OON1., DO	В   еглета
Slocal WSENprojects\MA\Millbury MA\Downtown Redevelopment\Cogort\U-Current working \pare \no.	School St	<6					30

TOWN OF MILLBURY, MA



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Date: 7-12-2019 Drawn By: KK

Reviewed By: MSM

Approved By:


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Drawing Title:

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Sheet Number:

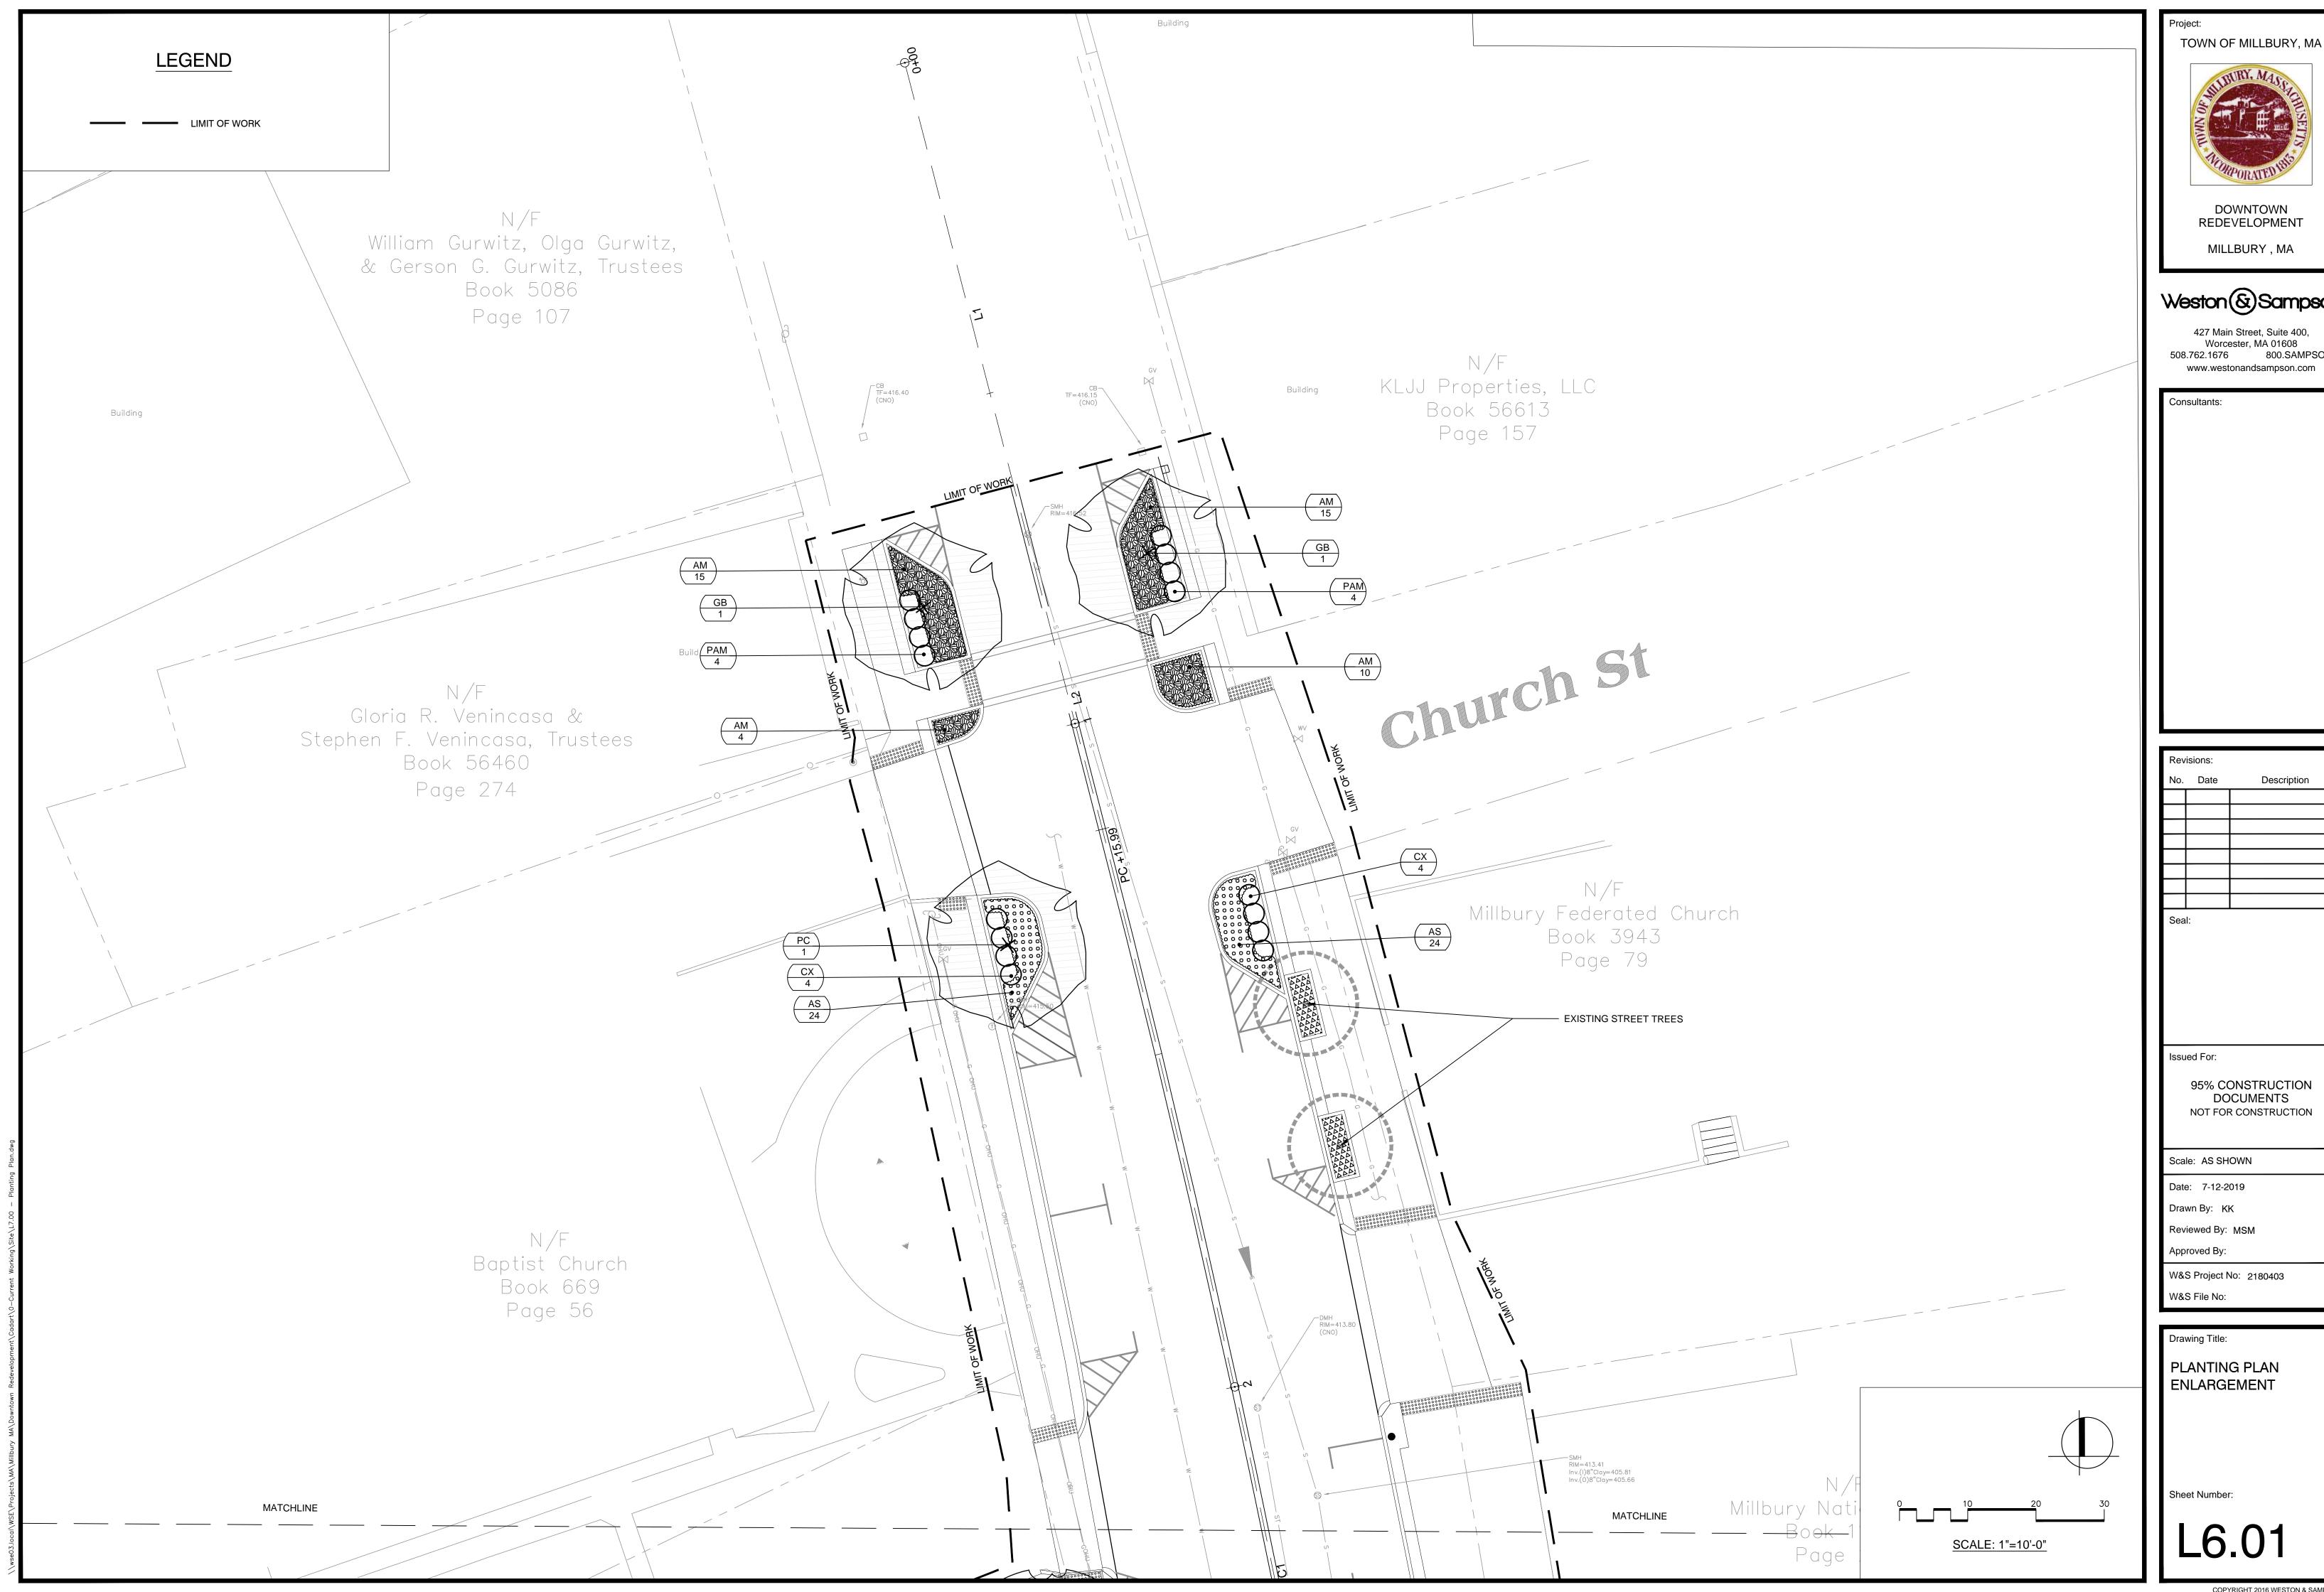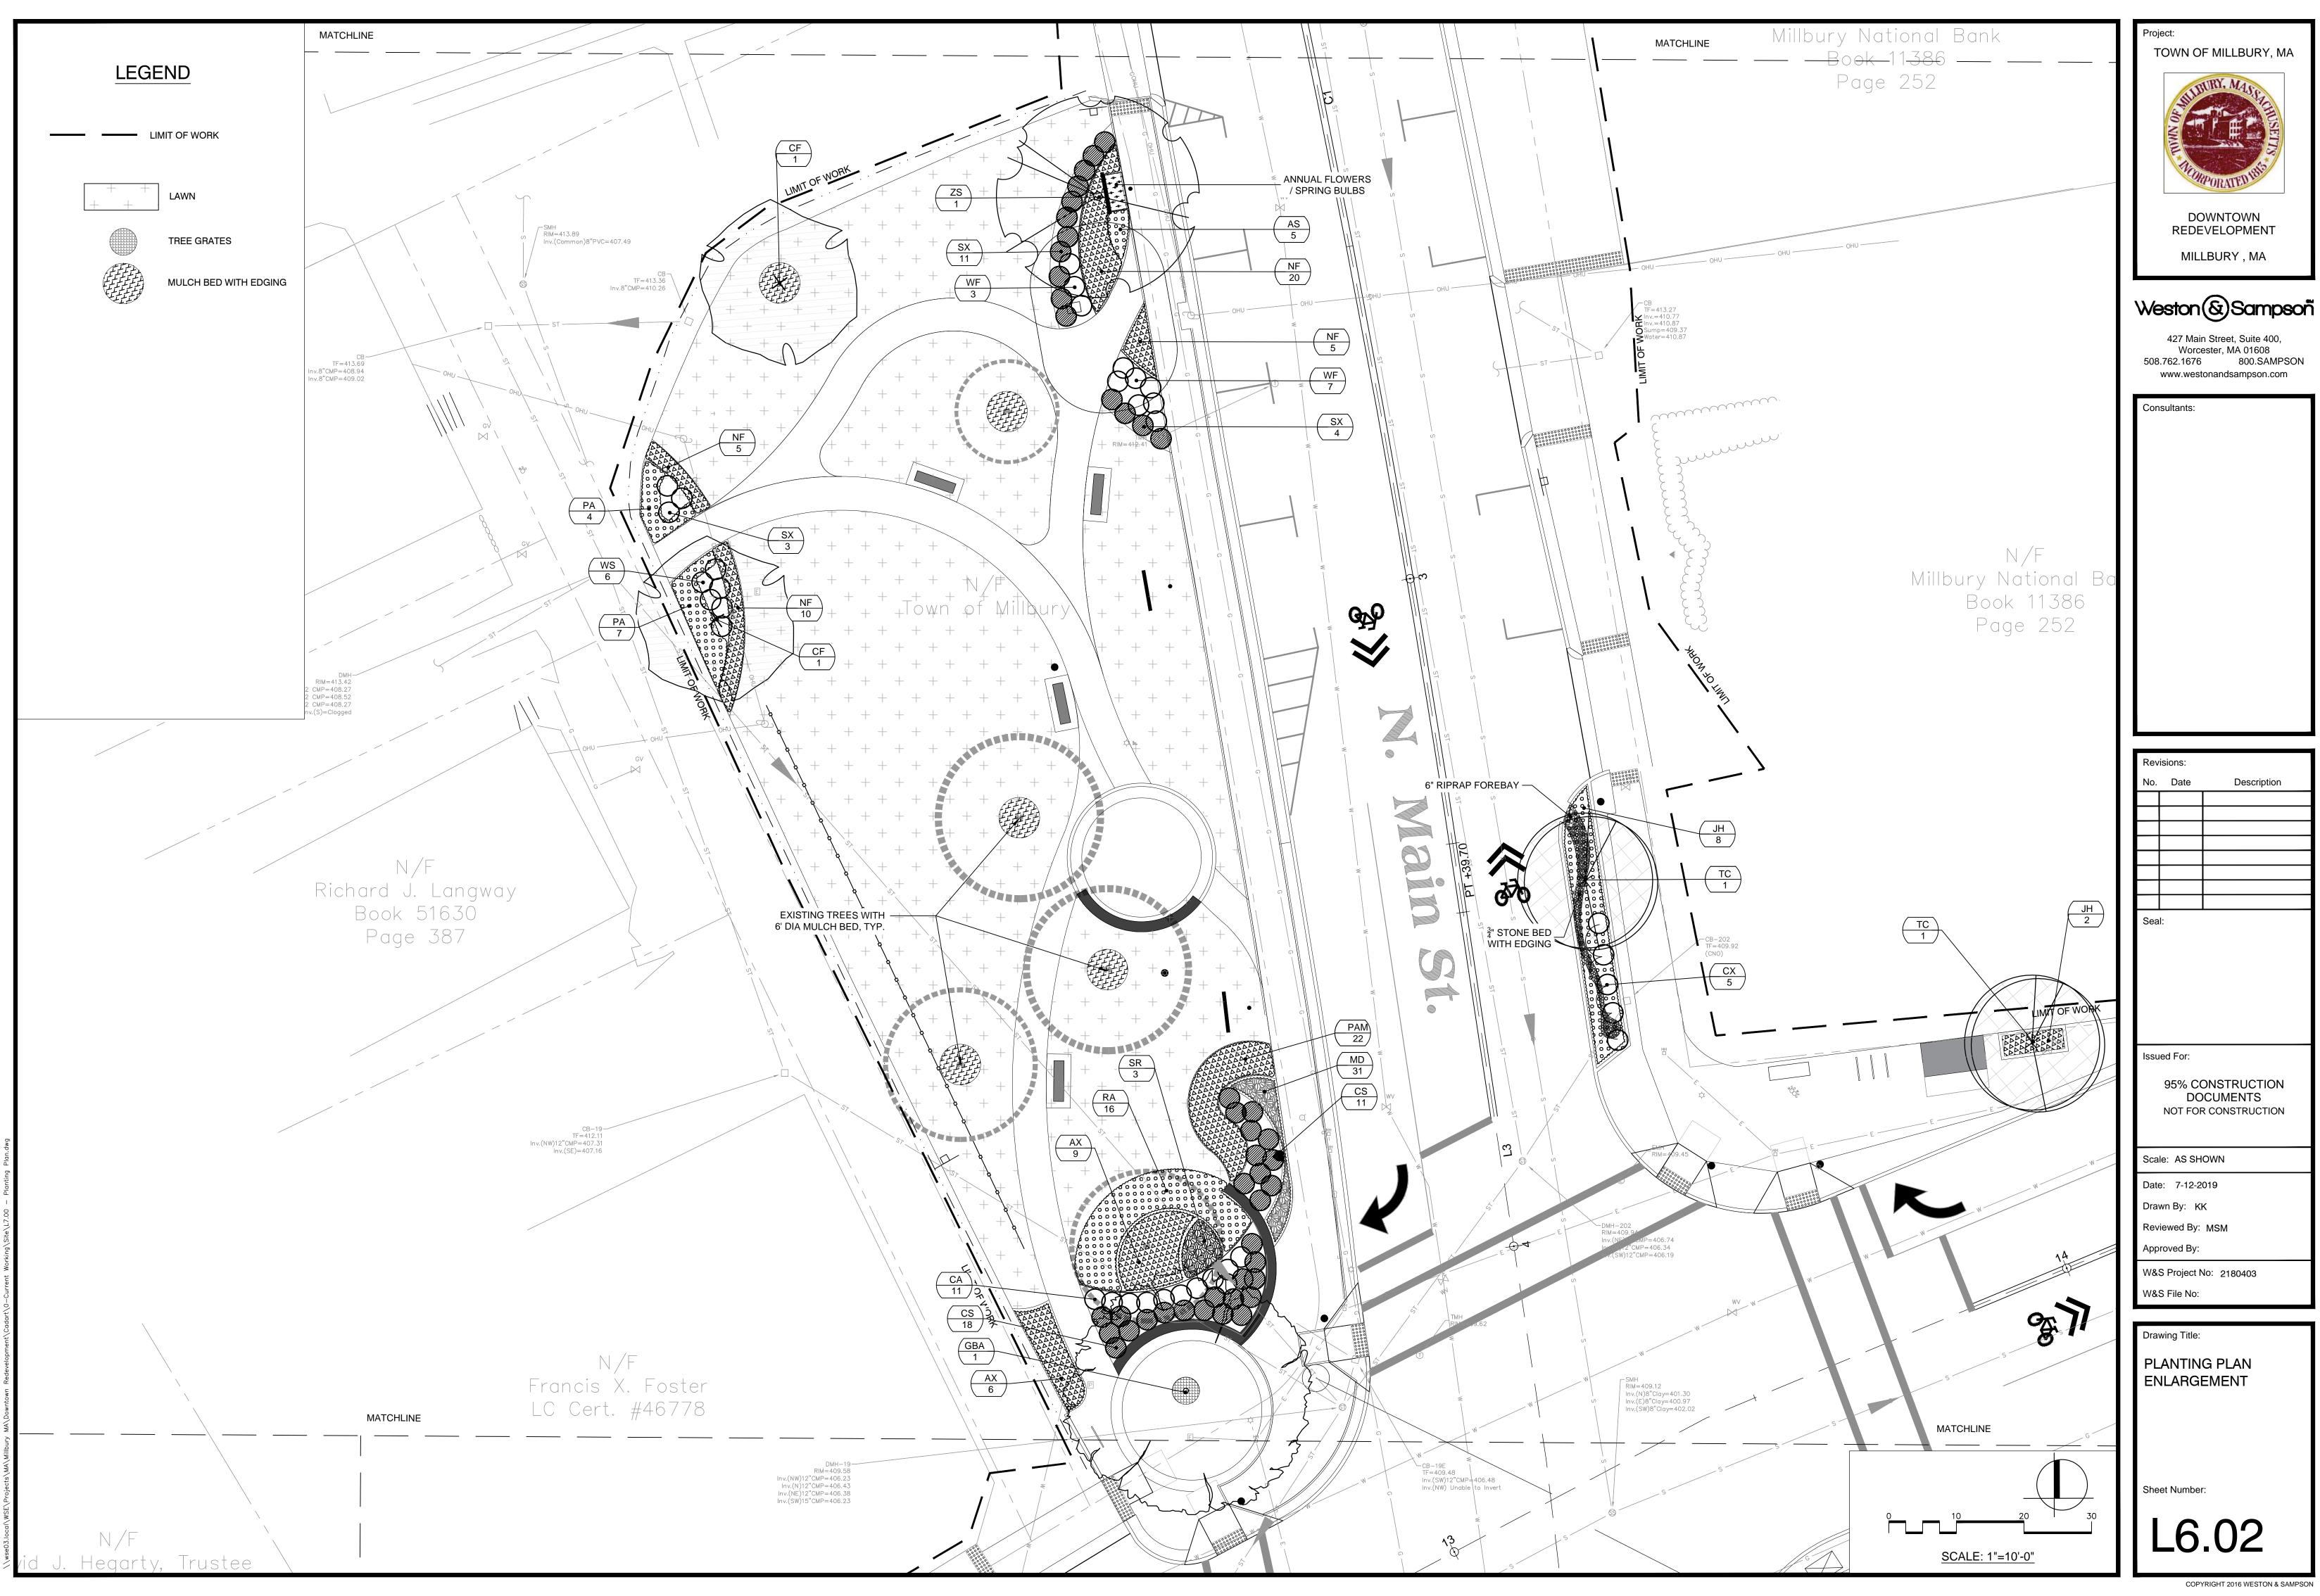
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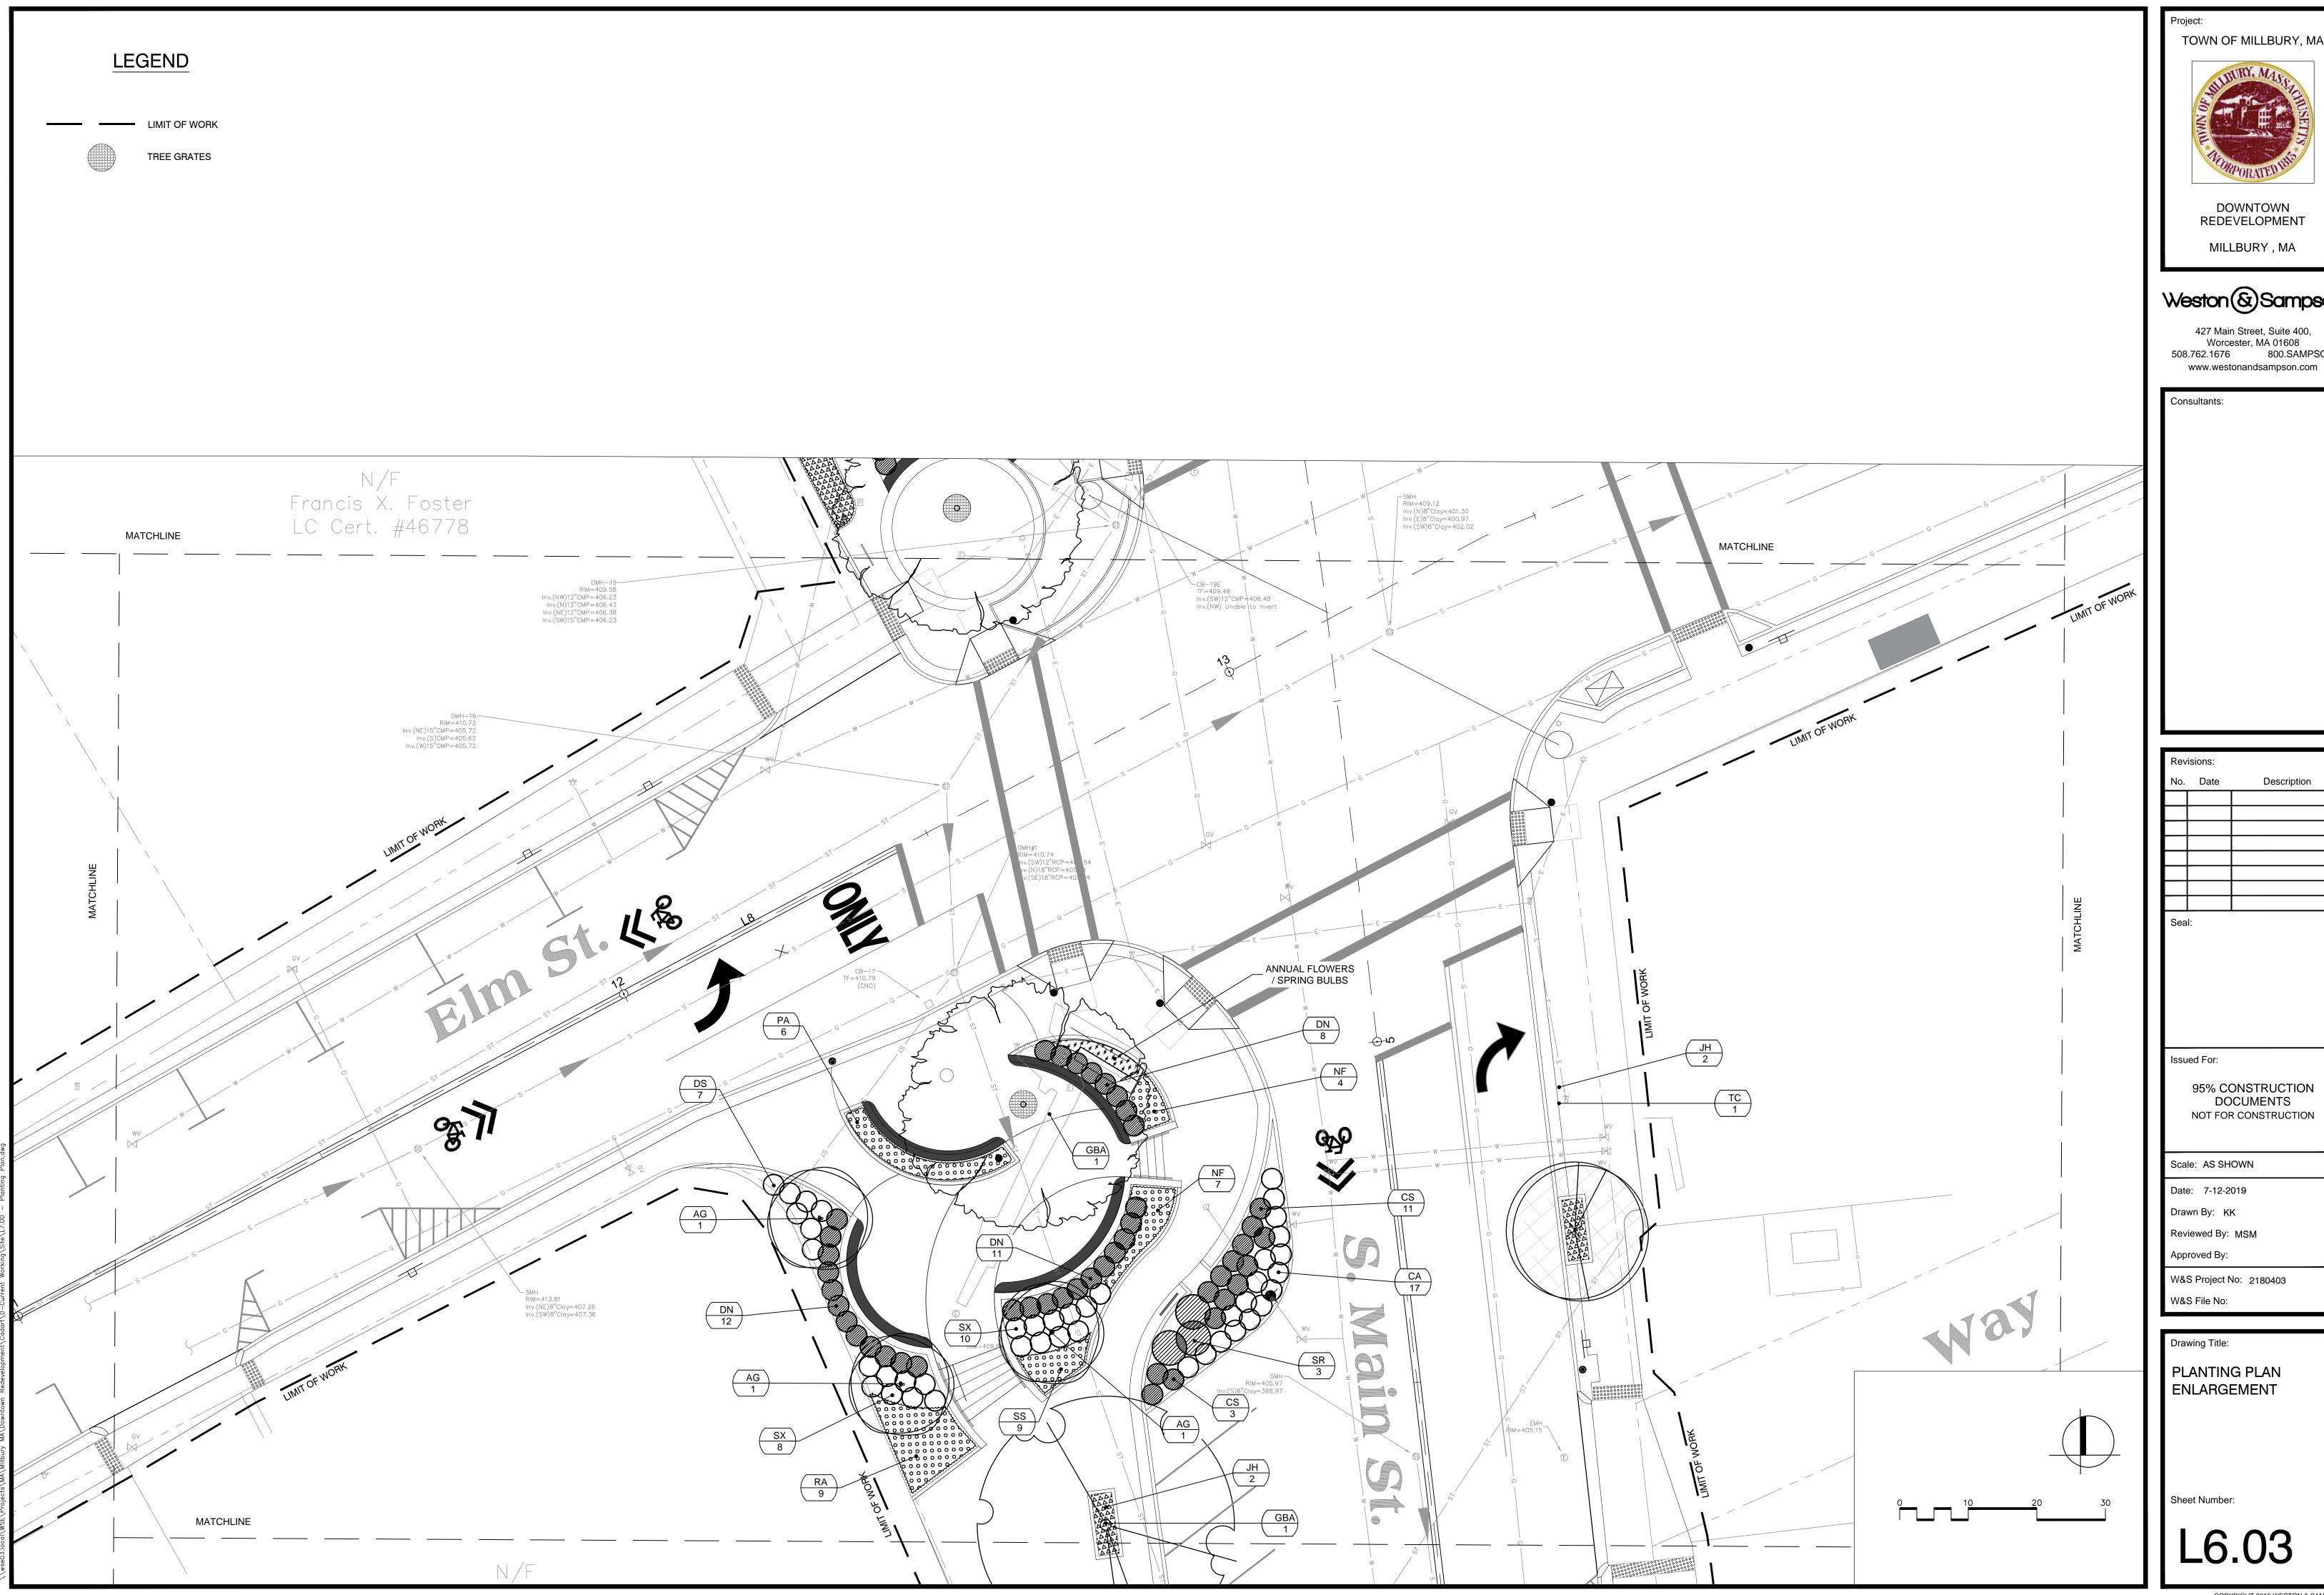


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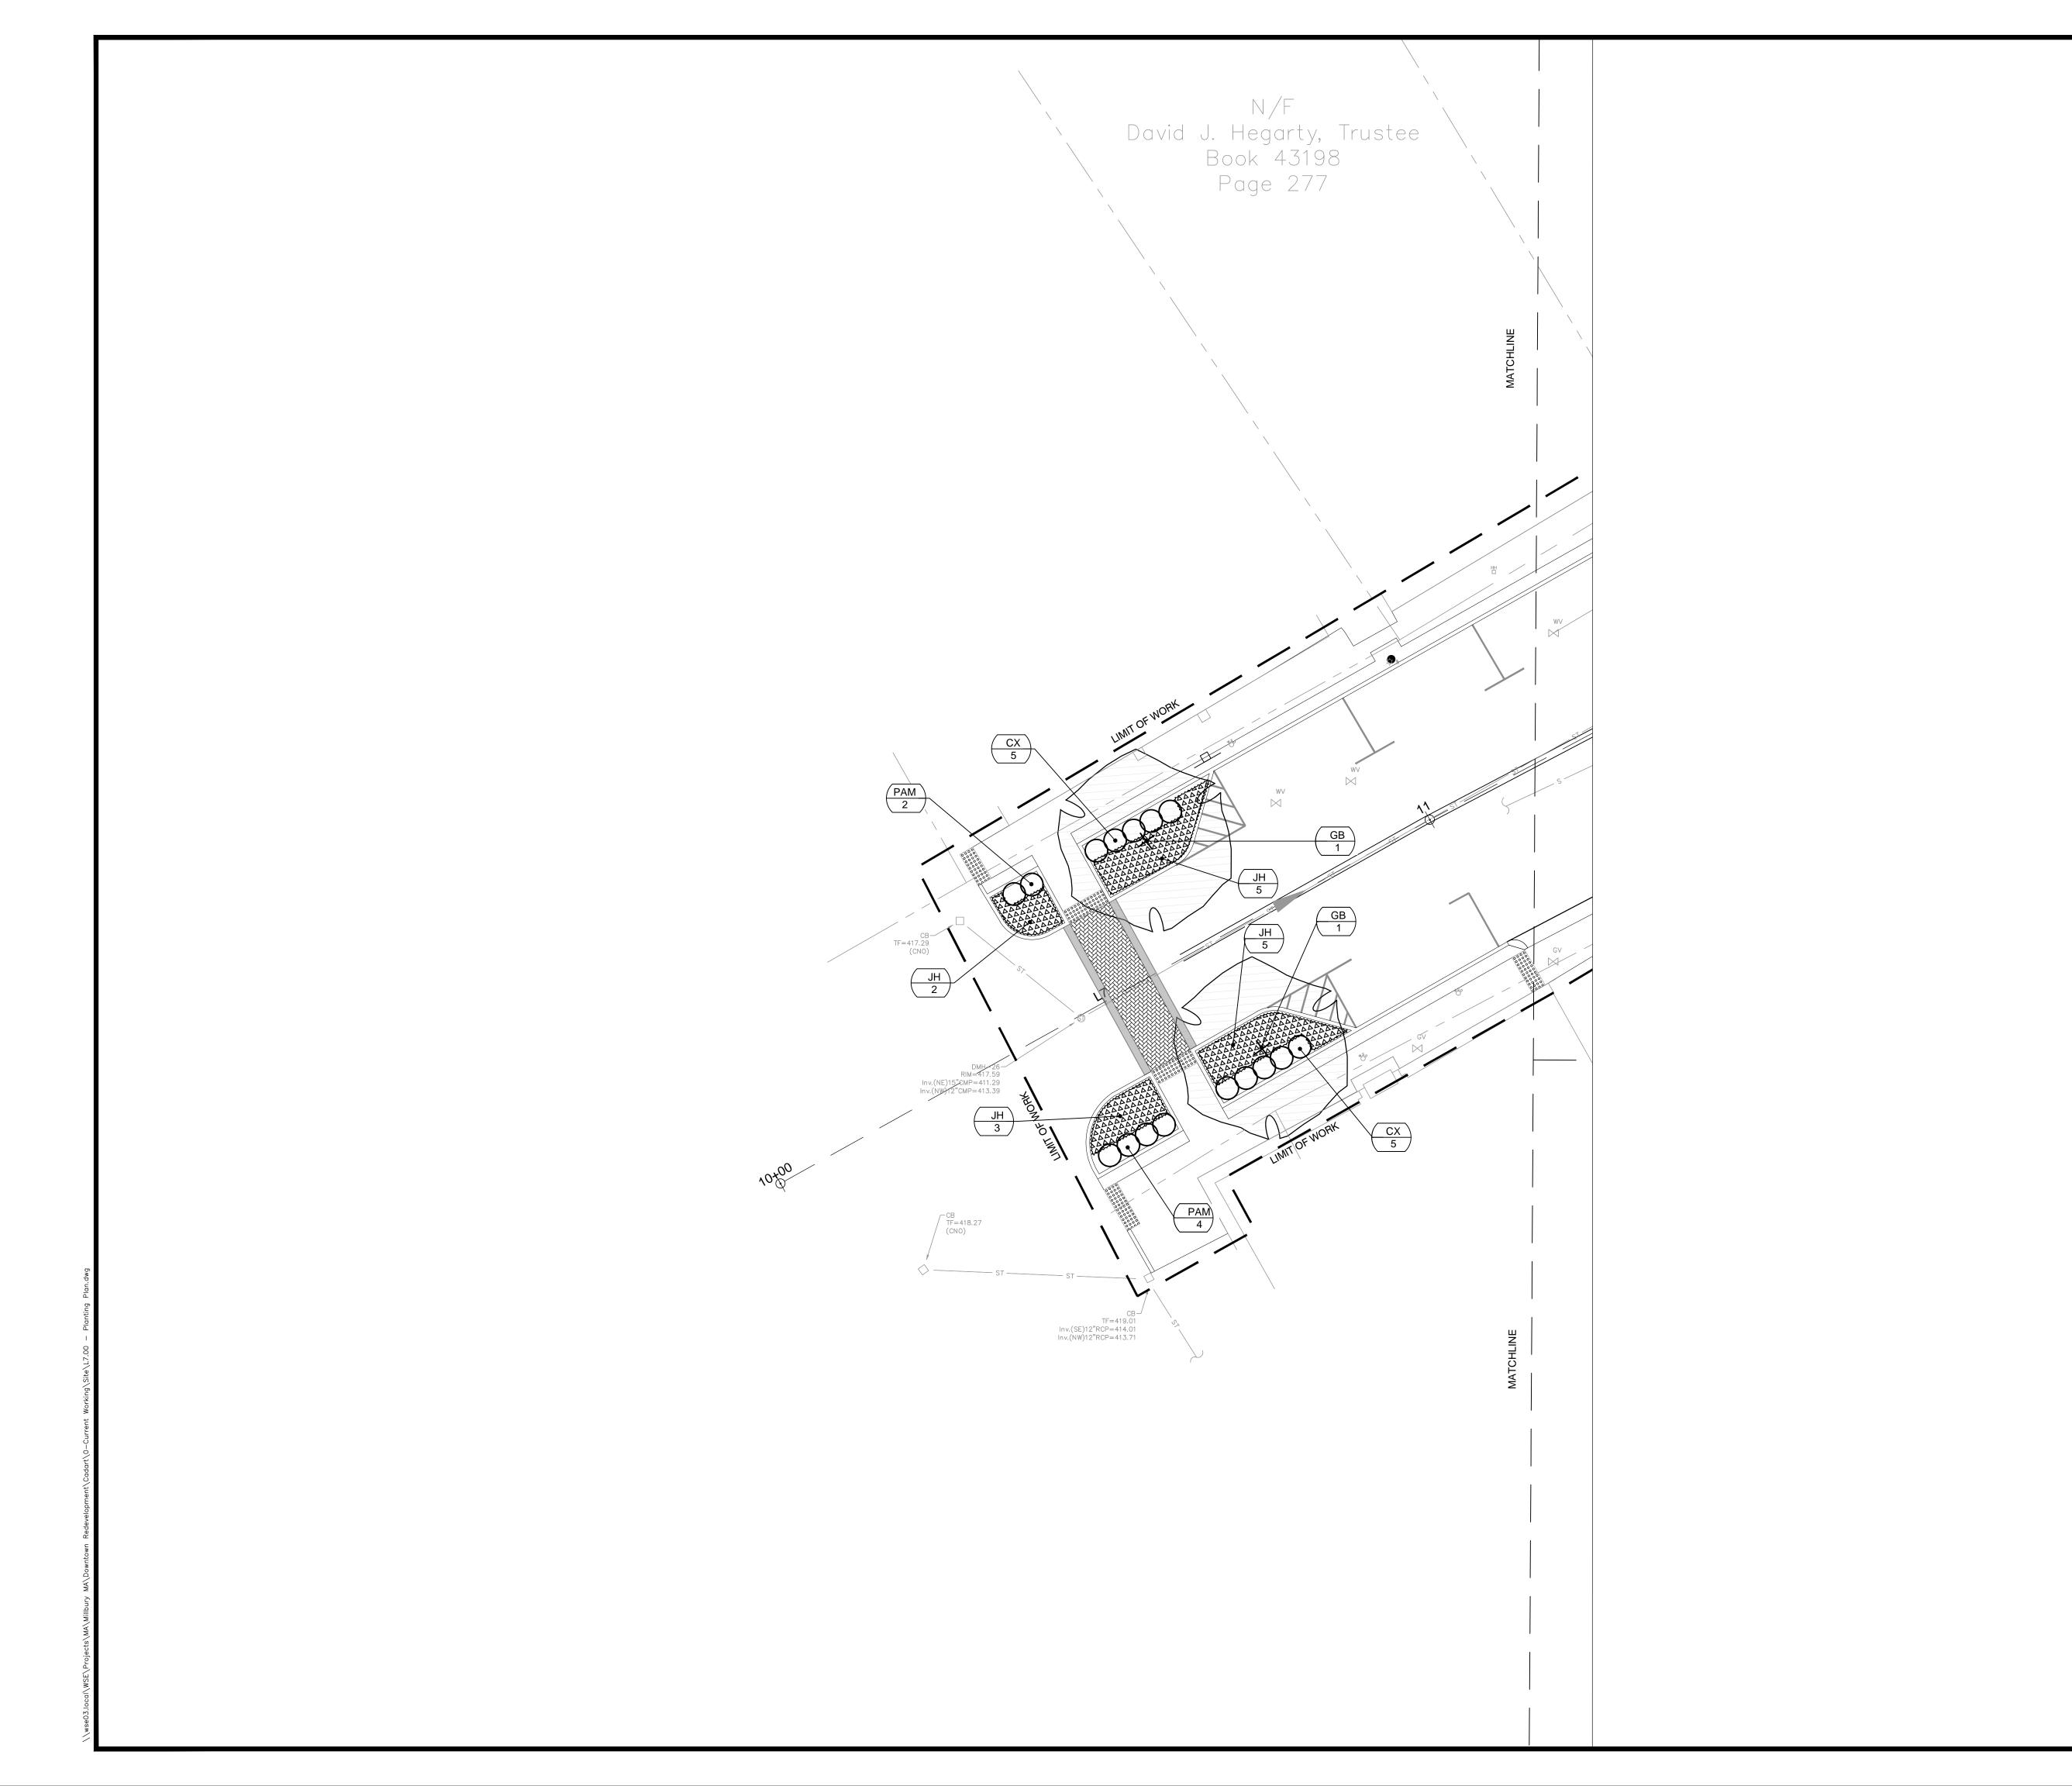
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Description




LEGEND

LIMIT OF WORK

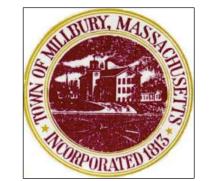Project:

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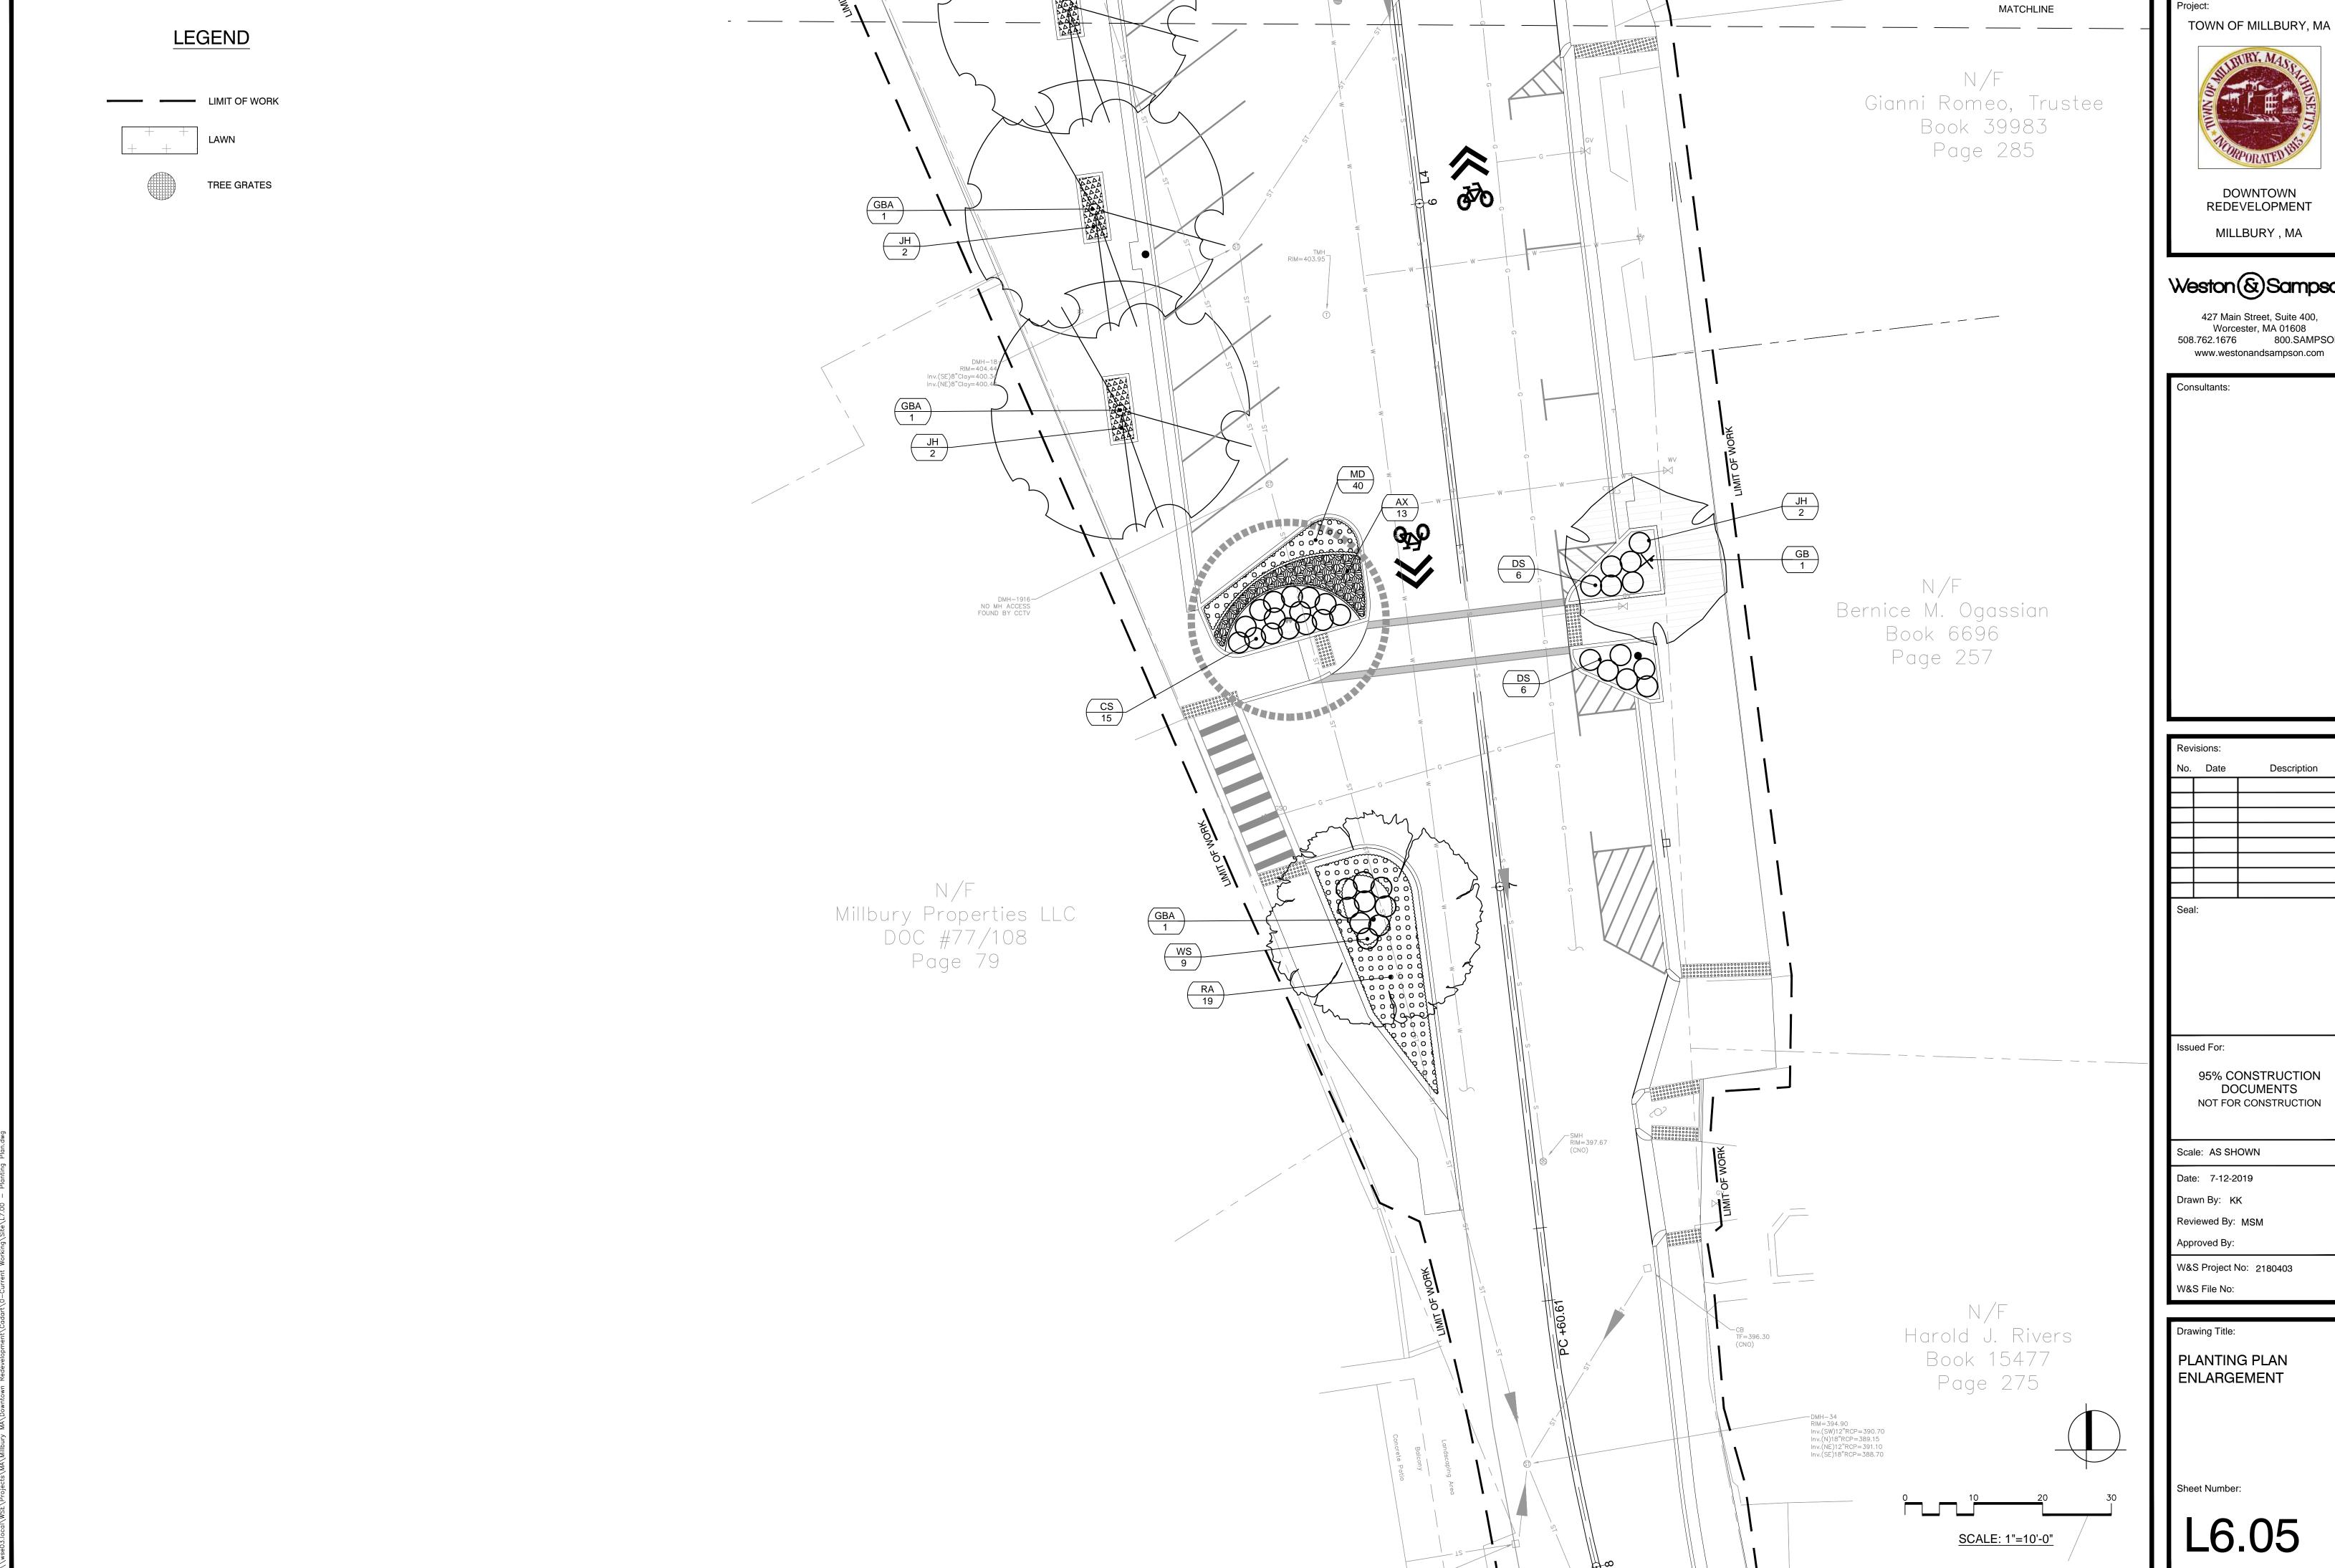
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PLANTING PLAN ENLARGEMENT

Sheet Number:

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16.04

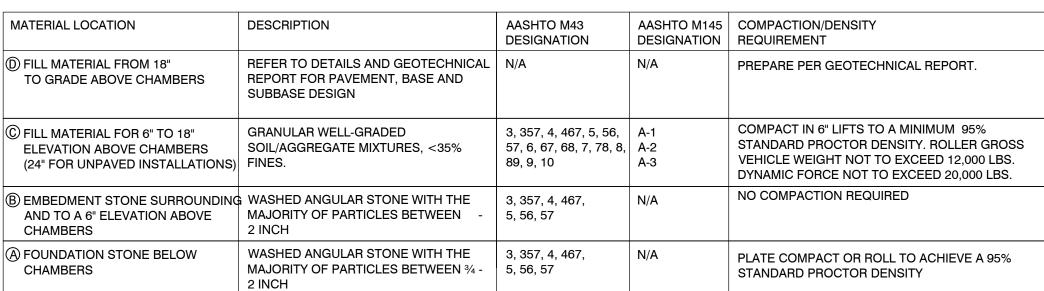




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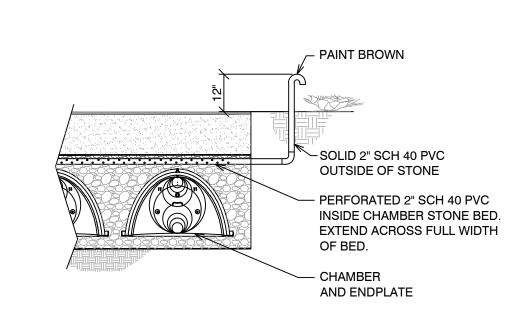
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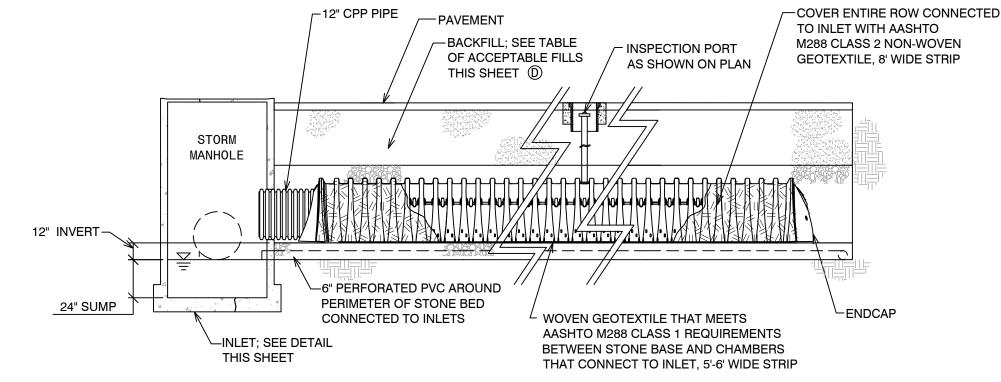


PLEASE NOTE: THE LISTED AASHTO DESIGNATIONS ARE FOR GRADATIONS ONLY. THE STONE MUST ALSO BE WASHED CRUSHED ANGULAR. FOR EXAMPLE, THE STONE MUST BE SPECIFIED AS WASHED, CRUSHED, ANGULAR NO. 4 STONE.

CHAMBER DETENTION - ACCEPTABLE FILL MATERIALS

SCALE: N.T.S.

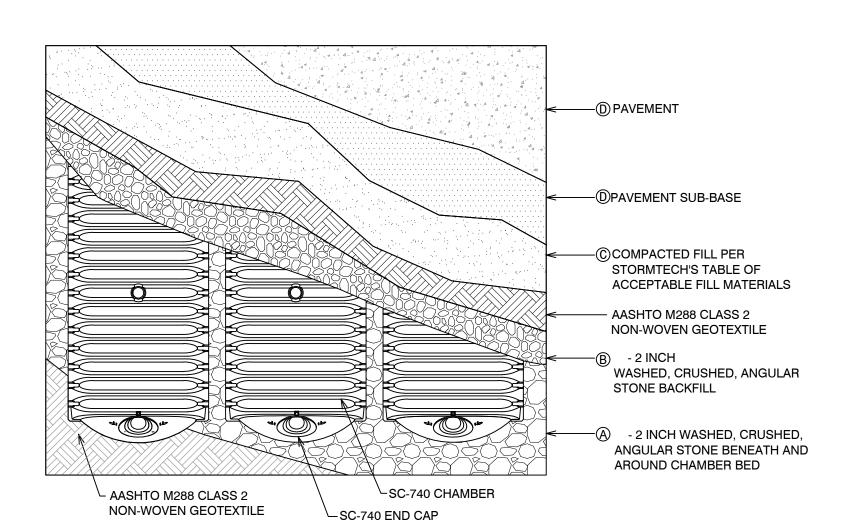





- 1. FOR DESIGN OF STORM MANHOLE SEE DETAIL, THIS SHEET.
- 2. SEE STORM MANAGEMENT PLAN, FOR LOCATION OF STORM PIPES AT MANHOLES, INVERT OF PIPES, ELEVATION OF BOTTOM OF STONE BED AND LAYOUT OF CHAMBER DETENTION SYSTEM.
- 3. DETAILS SHOWN FOR REFERENCE ONLY. LANDSAVER CHAMBERS ARE ALSO AN APPROVED DETENTION MATERIAL.


INSULATOR ROW - PROFILE VIEW, TYP. SCALE: N.T.S.

VENT DETAIL, TYP. SCALE: N.T.S.




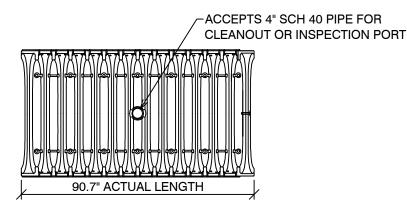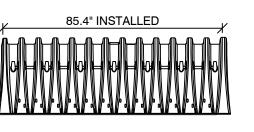CHAMBER DETENTION - PLAN VIEW, TYP. SCALE: N.T.S.





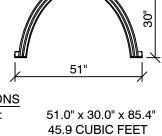NOMINAL CHAMBER SPECIFICATIONS SIZE (W x H x INSTALLED LENGTH): CHAMBER STORAGE: MINIMUM INSTALLED STORAGE: WEIGHT:



75 LBS.

74.9 CUBIC FEET

CHAMBER GENERAL NOTES

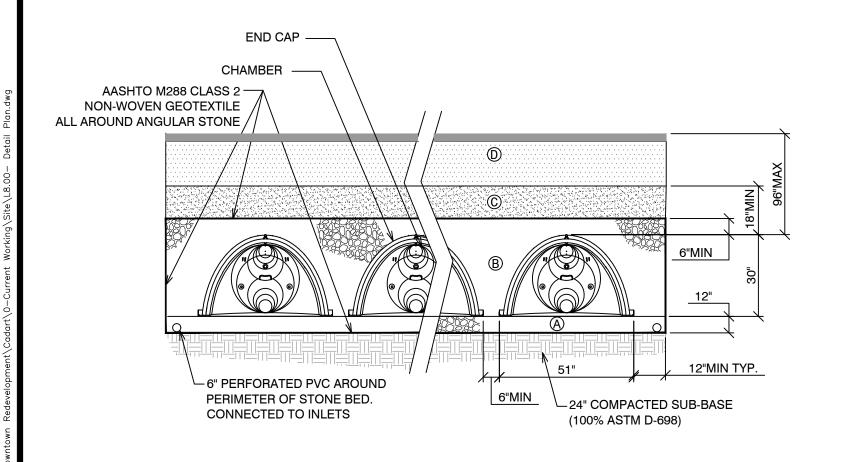
CONSTRUCTION AREAS.

- INSTALLATION PER MANUFACTURE.
- 2. INSULATOR REQUIREMENTS FOR SYSTEMS WITH PAVEMENT DESIGN (ASPHALT, CONCRETE PAVERS, ETC.): MINIMUM COVER IS 18 INCHES NOT INCLUDING PAVEMENT; MAXIMUM COVER IS 96 INCHES INCLUDING PAVEMENT. FOR INSTALLATIONS THAT DO NOT INCLUDE PAVEMENT, WHERE RUTTING FROM VEHICLES MAY OCCUR, MINIMUM REQUIRED COVER IS 24 INCHES, MAXIMUM COVER IS 96 INCHES.
- 3. THE CONTRACTOR MUST REPORT ANY DISCREPANCIES WITH CHAMBER FOUNDATION MATERIALS BEARING CAPACITIES TO THE DESIGN ENGINEER.
- 4. AASHTO M288 CLASS 2 NON-WOVEN GEOTEXTILE (FILTER FABRIC) MUST BE USED AS INDICATED IN THE PROJECT PLANS.
- 5. STONE PLACEMENT BETWEEN CHAMBERS ROWS AND AROUND PERIMETER MUST FOLLOW INSTRUCTIONS AS INDICATED IN THE MOST CURRENT VERSION MANUFACTURE'S INSTALLATION INSTRUCTIONS.
- 6. BACKFILLING OVER THE CHAMBERS MUST FOLLOW REQUIREMENTS AS INDICATED IN THE MOST CURRENT VERSION OF MANUFACTURE'S INSTALLATION INSTRUCTIONS.
- THE CONTRACTOR MUST REFER TO MANUFACTURE'S INSTALLATION INSTRUCTIONS FOR A TABLE OF ACCEPTABLE VEHICLE LOADS AT VARIOUS DEPTHS OF COVER. THE CONTRACTOR IS RESPONSIBLE FOR PREVENTING VEHICLES THAT EXCEED MANUFACTURE'S REQUIREMENTS FROM TRAVELING ACROSS OR PARKING OVER THE STORMWATER SYSTEM. TEMPORARY FENCING, WARNING TAPE AND APPROPRIATELY LOCATED SIGNS ARE COMMONLY USED TO PREVENT UNAUTHORIZED VEHICLES FROM ENTERING SENSITIVE
- 8. THE CONTRACTOR MUST APPLY EROSION AND SEDIMENT CONTROL MEASURES TO PROTECT THE STORMWATER SYSTEM DURING ALL PHASES OF SITE CONSTRUCTION PER LOCAL CODES AND DESIGN




CHAMBER, TYP.


SCALE: N.T.S.



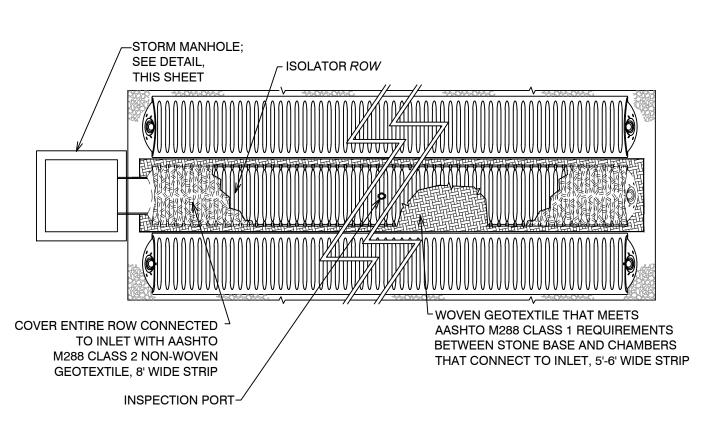CHAMBER DETENTION - ELEVATION VIEW, TYP.



INSULATOR ROW - PLAN VIEW, TYP.

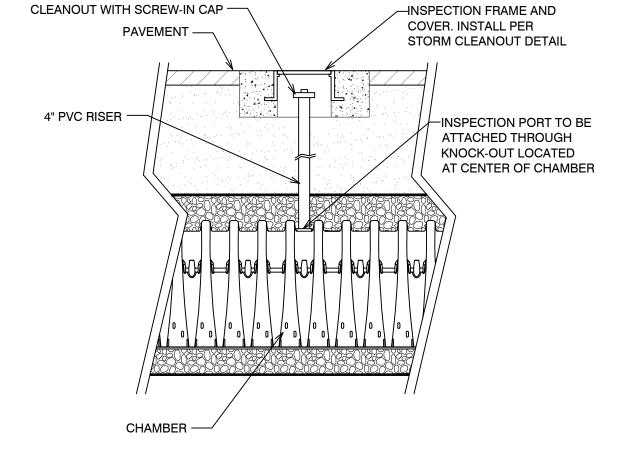

INSPECTION PORT DETAIL, TYP.

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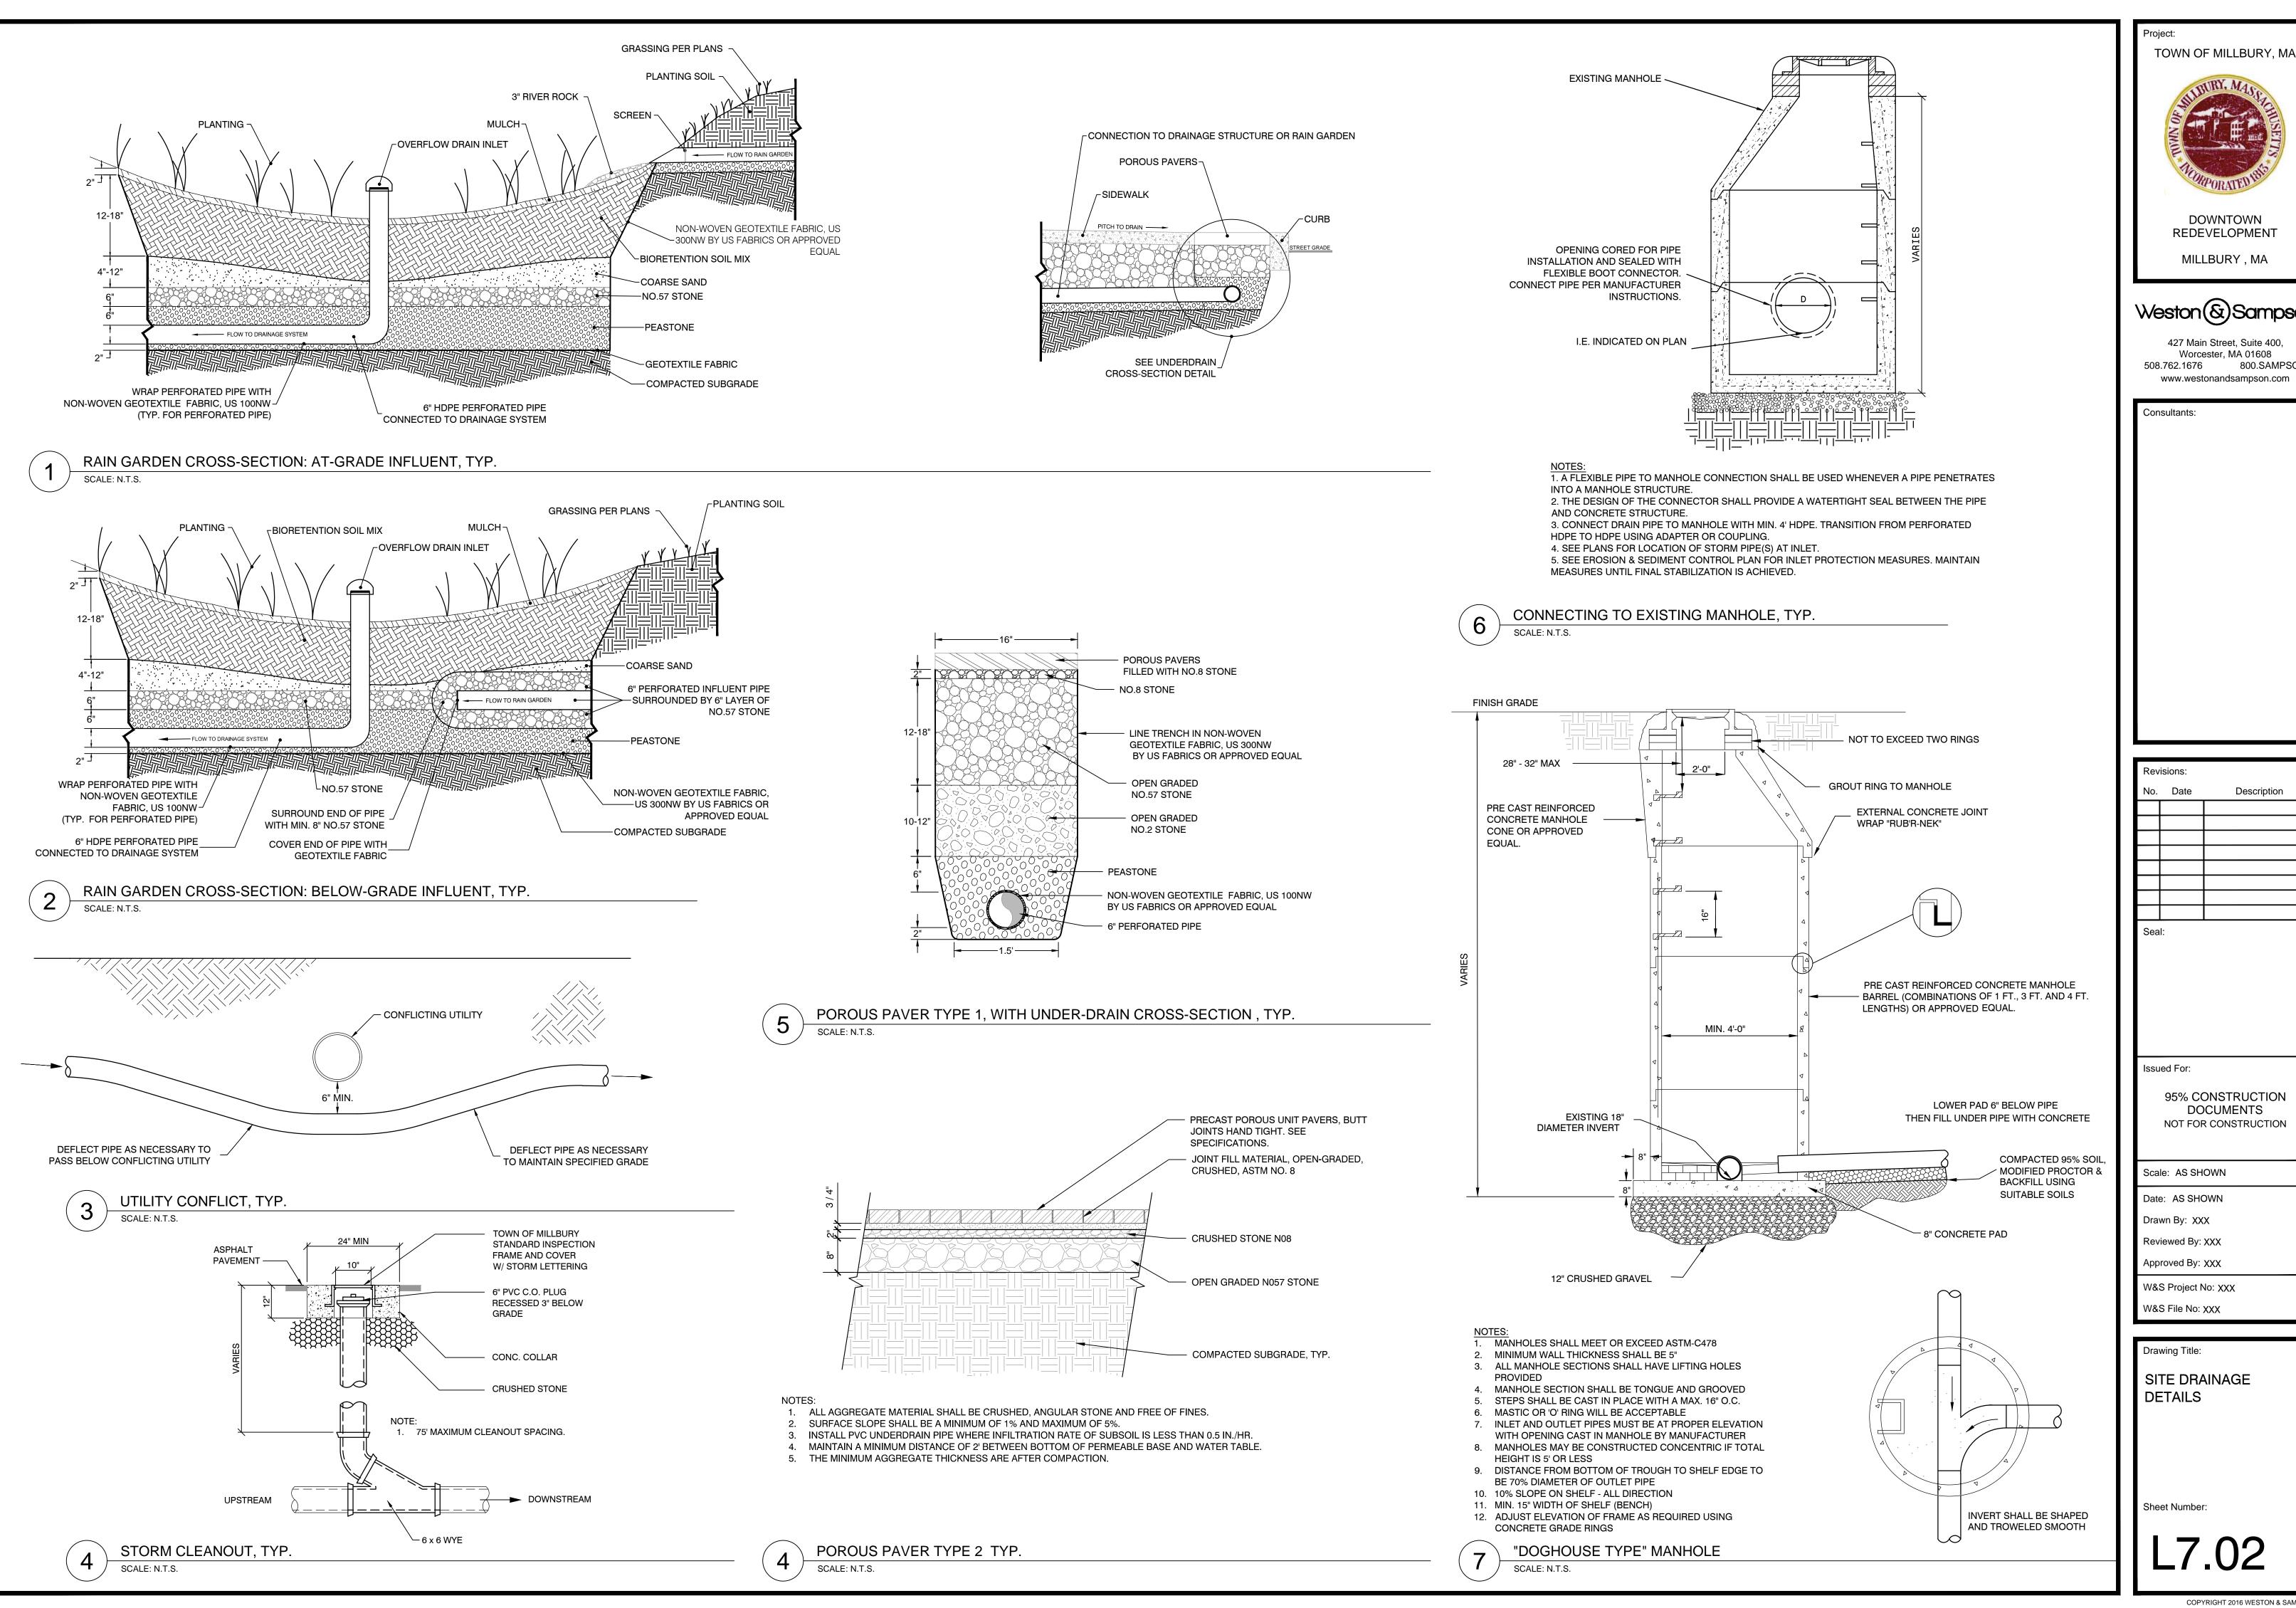
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W&S Project No: XXX W&S File No: XXX

Drawing Title:

SITE DRAINAGE DETAILS

Sheet Number:



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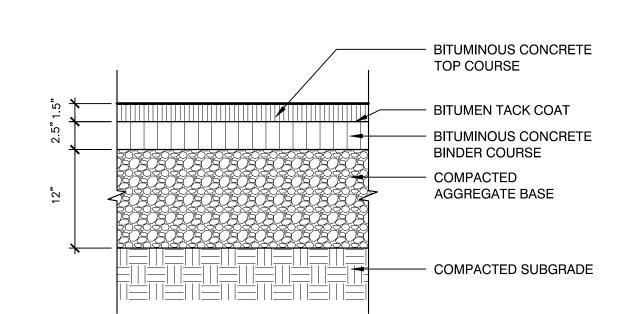
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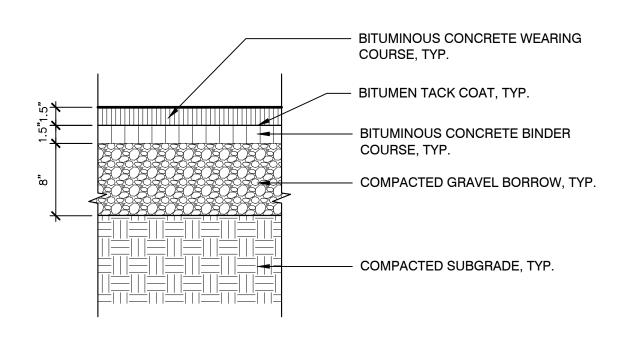
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Drawing Title: SITE DRAINAGE



1 VEHICULAR RATED BITUMINOUS CONCRETE PAVEMENT, TYP.

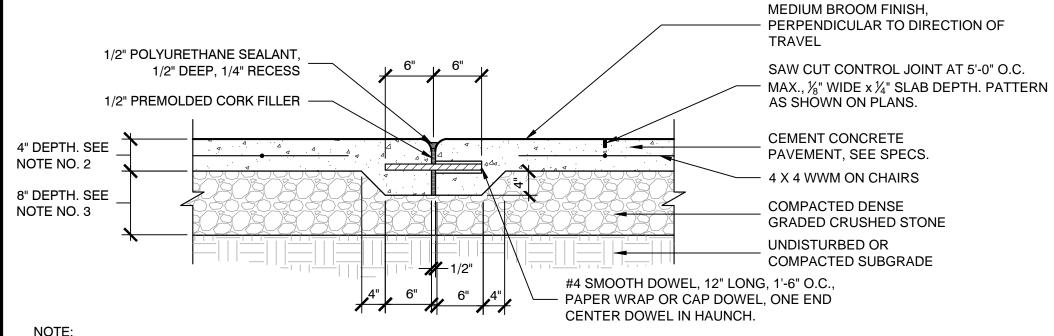
SCALE: N.T.S.



CONTRACTOR TO PROVIDE SMOOTH TRANSITION WHERE NEW PAVEMENT ABUTS EXISTING PAVEMENT, TYP.

PEDESTRIAN RATED BITUMINOUS CONCRETE PAVEMENT, TYP.


SCALE: N.T.S.



1. EXPANSION JOINT SPACING SHALL BE 25'-0" MAX, UNLESS OTHERWISE SHOWN ON PLANS.

- 2. NO REINF. @ 4" DEPTH PVMT. 6x6-W2.9xW2.9 WELDED WIRE FABRIC W/12" LAP @ 6" DEPTH PVMT.
- 3. USE 8" GRAVEL BORROW UNDER 4" CEM. CONC. WALK PVMT. USE 12" GRAVEL BORROW UNDER 6" CEM. CONC. PADS/SLABS.
- 4. DOWELS SHALL BE USED AT EXPANSION JOINTS, WHERE NEW CONCRETE PAVEMENT ABUTS EXISTING CONCRETE PAVING TO REMAIN, AND ANY PROPOSED CONCRETE RAMPS AND STAIRS.
- 5. FOR SIDEWALK PAVEMENT, USE BROOM FINISH PERPENDICULAR TO ROUTE OF TRAVEL.
- 6. DOWEL IS TYPICAL AT ALL EXPANSION JOINTS (18"O.C.) WITHIN CONCRETE PAVING AND NEW CONCRETE PAVING BETWEEN EXISTING CONCRETE PAVING TO REMAIN.
- 7. DELETE EXPANSION SLEEVE AND DOWEL WHERE JOINT ABUTS WALL, CURBS, OR OTHER VERTICAL SURFACES UNLESS OTHERWISE NOTED.

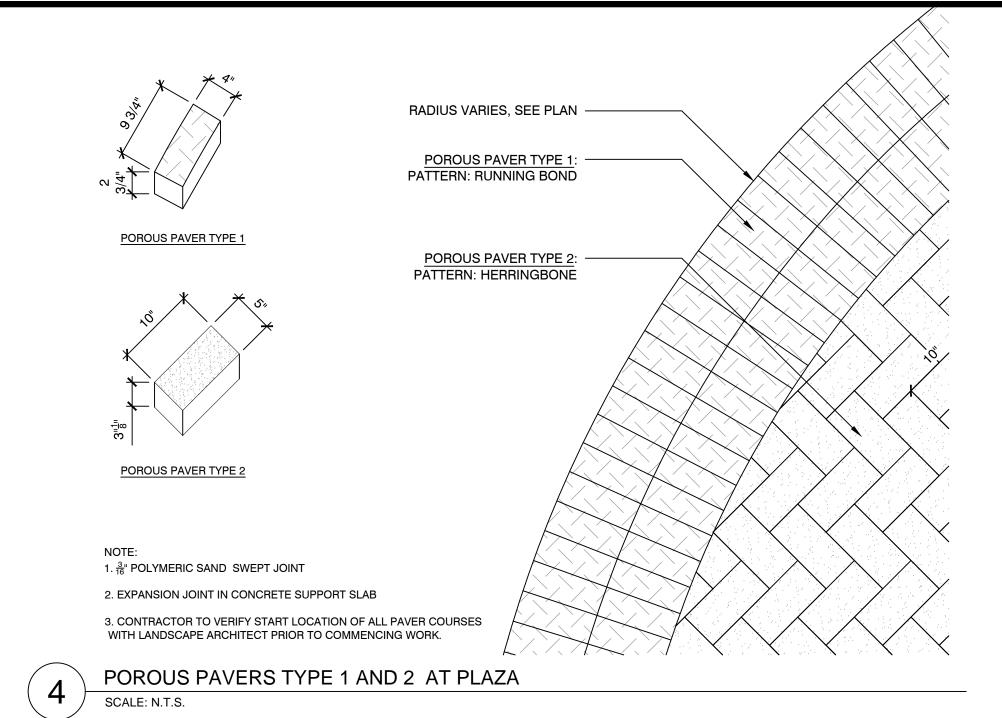3 CEMENT CONCRETE PAVEMENT, TYP. SCALE: N.T.S.



ADJACENT CONDITION, SEE MATERIAL PLANS

GRANITE CURB

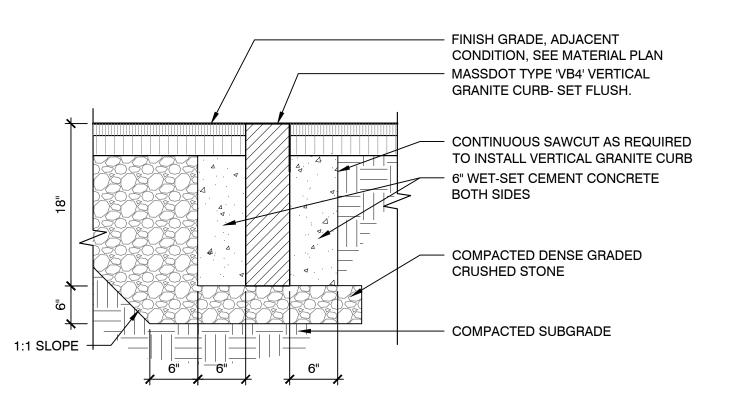
FINISH GRADE,
ADJACENT CONDITION,
SEE MATERIAL PLANS

SCARIFIED SUBGRADE,
4-IN DEPTH
6" WET-SET CEMENT
CONCRETE BOTH
SIDES

COMPACTED DENSE GRADED
CRUSHED STONE

COMPACTED SUBGRADE


5 VERTICAL GRANITE CURB, TYP.
SCALE: N.T.S.




1. CEMENT CONCRETE SHALL EXTEND TO THE BOTTOM OF THE BITUMINOUS CONCRETE.

2. ANY CLASS OF CEMENT CONCRETE ASSEPTABLE UNDER SECTION M4 OF TEH MASS. "SSHB" MAY BE USED.

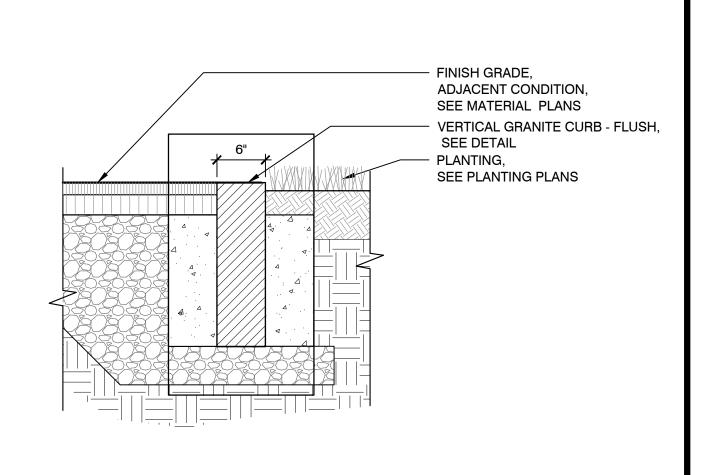6 VERTICAL GRANITE CURB - FLUSH, TYP. SCALE: N.T.S.



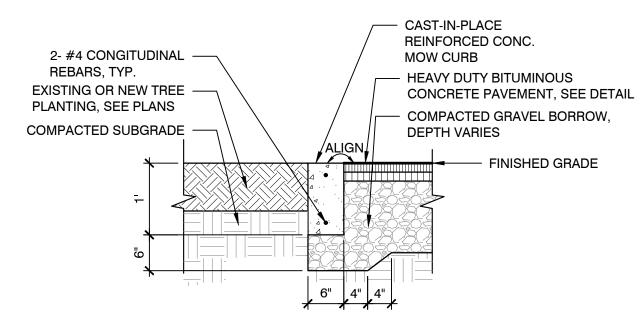7 VERTICAL GRANITE CURB-FLUSH AT PLANTING, TYP. SCALE: N.T.S.




NOTES:

 MOW STRIP CORNERS ADJACENT TO RESILIENT SURFACING SHALL BE SQUARE TO ENSURE SMOOTH INTERFACE BETWEEN MATERIALS.

- 2. MOW STRIP CORNERS ADJACENT TO PLANTING BED OR LAWN AREAS WILL HAVE  $\frac{1}{2}$ " CHAMFER
- 3. CONTRACTOR SHALL PROVIDE 1" PREMOLDED POLYETHYLENE FOAM EXPANSION JOIN, FULL DEPTH WITH SILICONE SEALANT EVERY 30' O.C. LINLESS OTHERWISE NOTED
- DEPTH WITH SILICONE SEALANT EVERY 30' O.C. UNLESS OTHERWISE NOTED.

  4. CONTRACTOR SHALL USE EXTREME CAUTION AT ROOT ZONE OF EXISTING TREES TO REMAIN. CONTRACTOR SHALL CLEAN CUT ANY ROOTS OVER 2" DIA. THAT ARE EFFECTED BY THE SCOPE OF WORK. CONTRACTOR SHALL CONSULT ARBORIST PRIOR TO ANY ROOT REMOVAL.

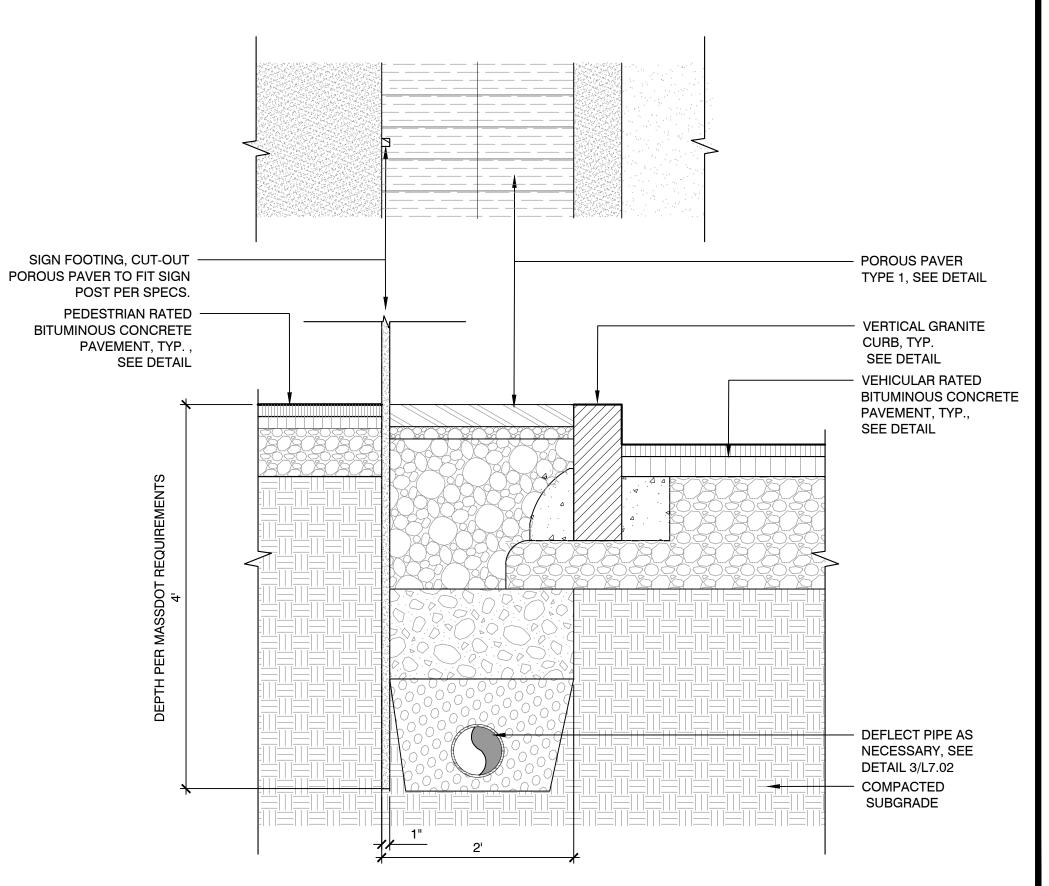8 MOW CURB - FLUSH, TYP.
SCALE: N.T.S.



SIGNAGE SURFACE MOUNT, TYP.

SCALE: N.T.S.

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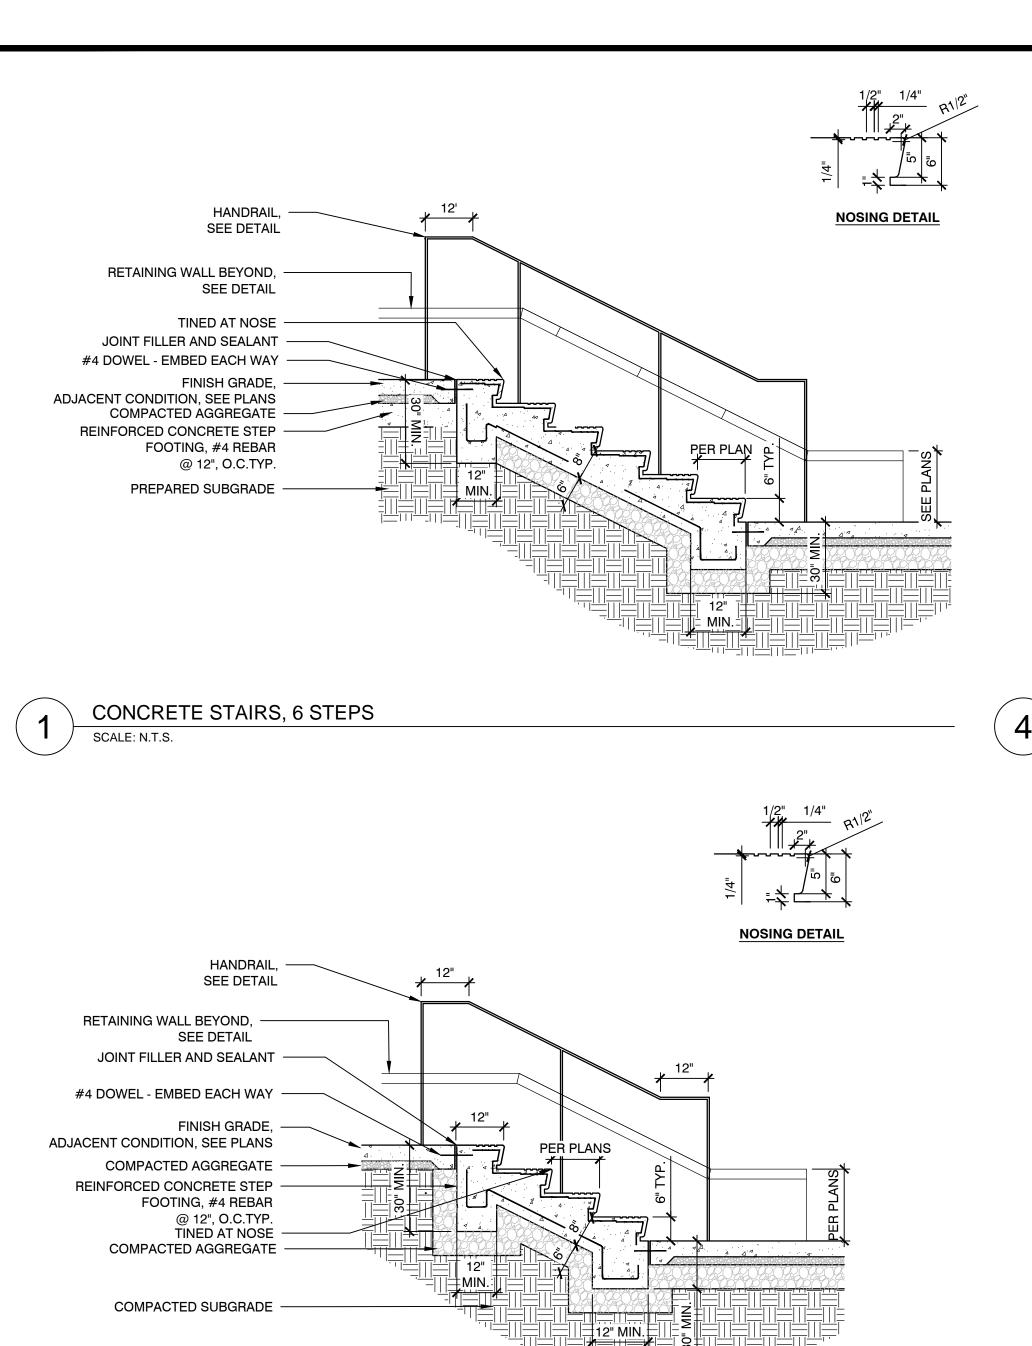
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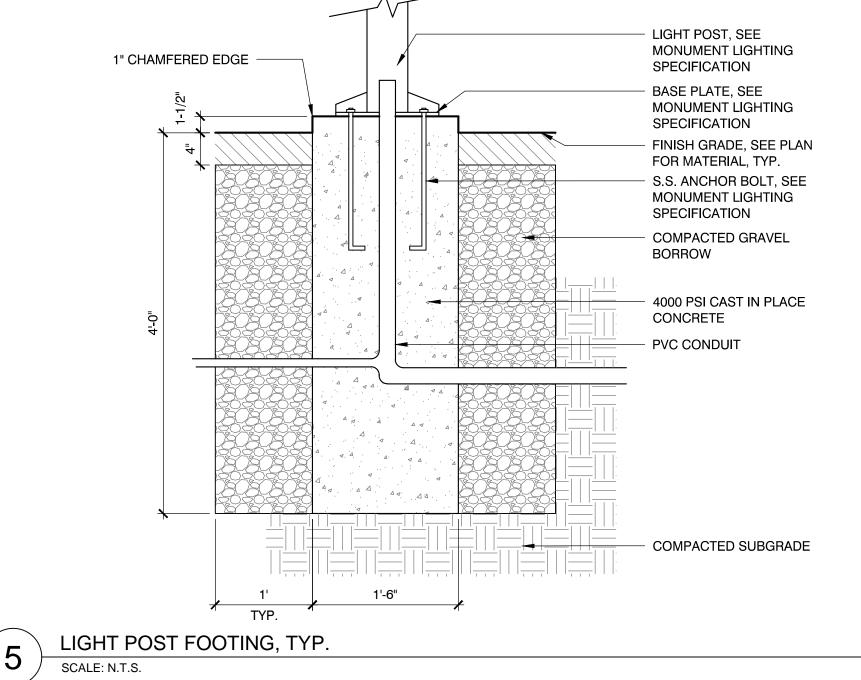
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SITE IMPROVEMENT DETAILS

Sheet Number:

| L7.03





1. ALL SITE FURNISHINGS SHALL

MANUFACTURER'S

FURNITURE SURFACE MOUNT, TYP.

TREE GRATE EDGING CONDITIONS, TYP.

SCALE: N.T.S.

RECOMMENDATIONS.

BE SURFACE MOUNTED PER

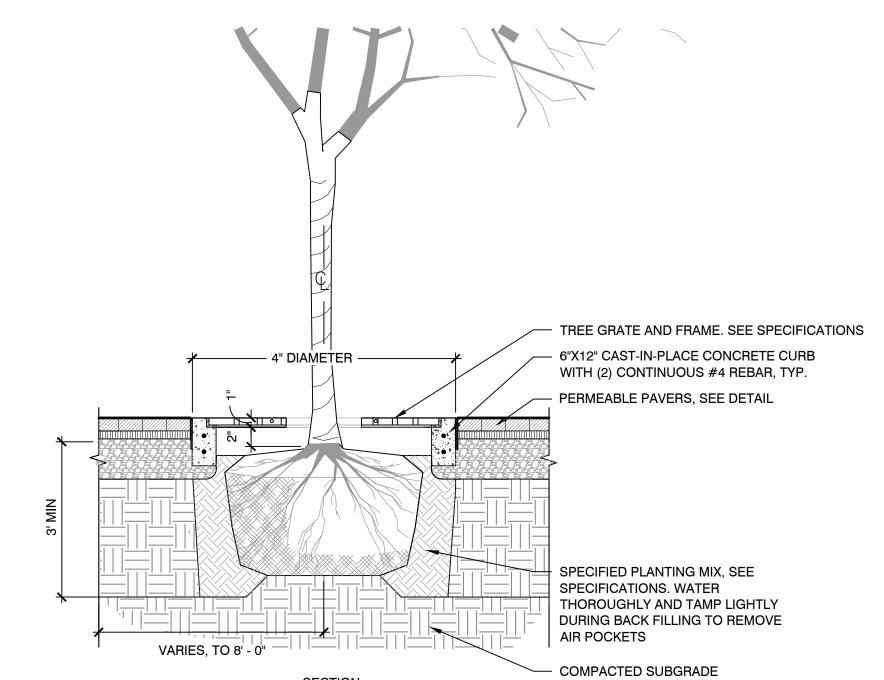
SURFACE MOUNT TO CONCRETE

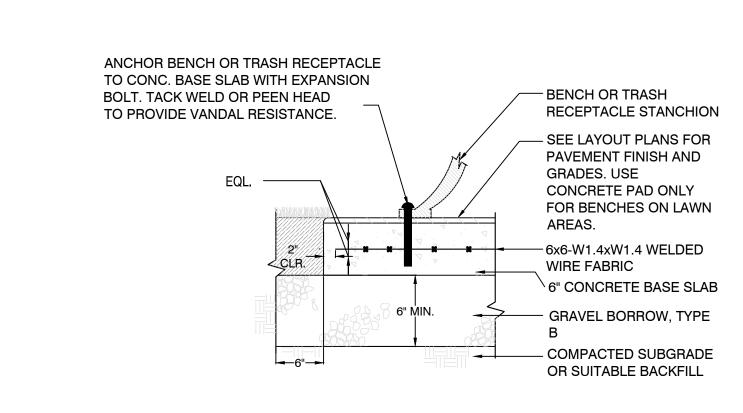
COMPACTED OR-

SCALE: N.T.S.


UNDISTURBED


SUBGRADE





BENCH FOOTING ON CONCRETE PAD, TYP.

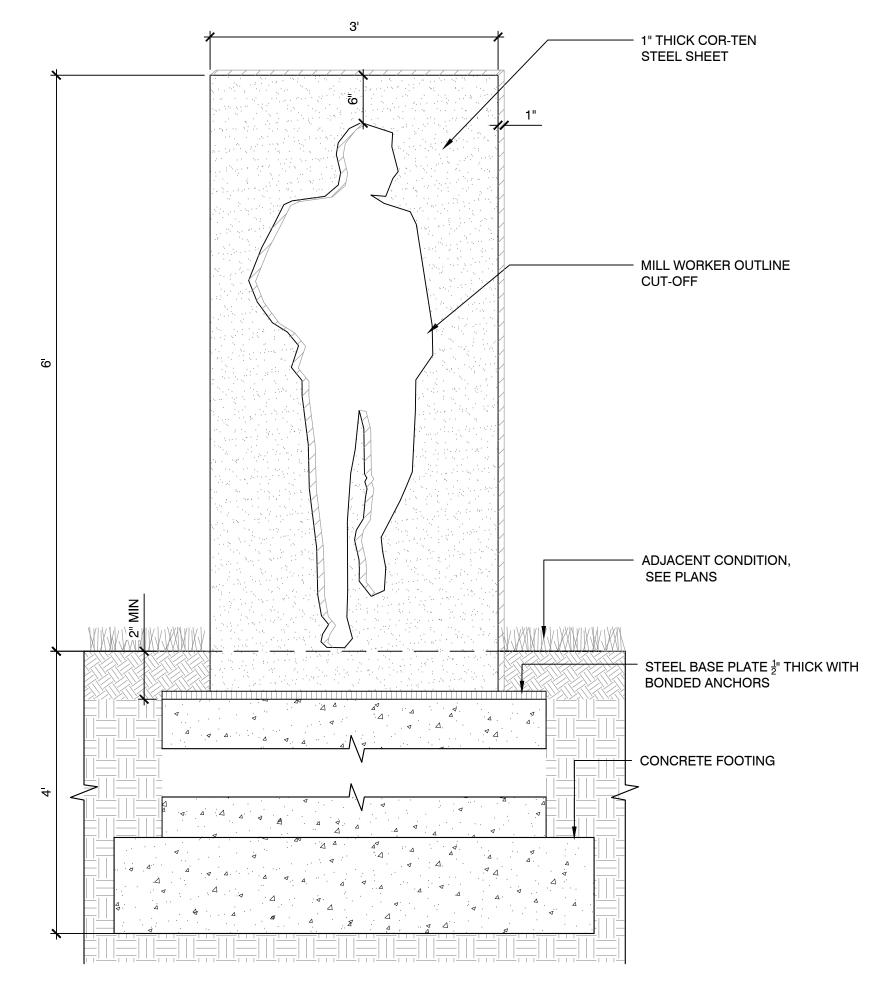

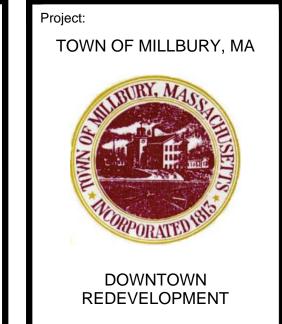

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3 HANDRAIL, TYP.
SCALE: N.T.S.

CONCRETE STAIRS, 4 STEPS

HANDRAIL 1/4 " THICK, 2" WIDE. — POST MOUNT ASSEMBLY,

HANDRAIL BASE PLATE, 1/8" THICK. - FINISH TO MATCH HANDRAIL.

2.ENSURE ADA COMPLIANCE.

PAINTED PER SPECS.

HOLD FOOTER 2" MIN. -BELOW FINISH GRADE

LANDSCAPE ARCHITECT PRIOR FABRICATION.

3.ENSURE HANDRAILS INSTALLED UPRIGHT AND PLUMB.

**SECTION AT FOOTER** 

1. SUBMIT SHOP DRAWINGS INCLUDING FIELD MEASUREMENTS FOR APPROVAL BY

SCALE: N.T.S.

PACTED SUBGRADE

WEATHERING STEEL SCULPTURE

SCALE: N.T.S.

-5%" x 4" S.S. ANCHOR BOLT, VANDAL RESISTANT WITH LEVELING WASHERS

FURNITURE BASE

-UNIT PAVERS

SEE DETAIL

-COMPACTED OR

UNDISTURBED

SUBGRADE

 $^{-5}\!\!8$ " x 4" S.S. ANCHOR BOLT, VANDAL RESISTANT WITH

-FURNITURE BASE

LEVELING WASHERS

- 4" CAST IN PLACE CONCRETE/

PAVEMENT, TYP., SEE DETAIL!

NOTES:

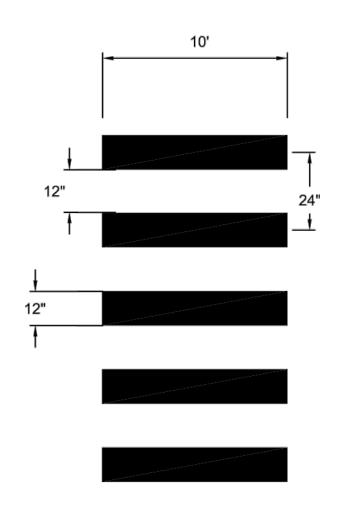
1. ALL SITE FURNISHINGS SHALL

MANUFACTURER'S


RECOMMENDATIONS.

BE SURFACE MOUNTED PER

SURFACE MOUNT TO UNIT PAVERS



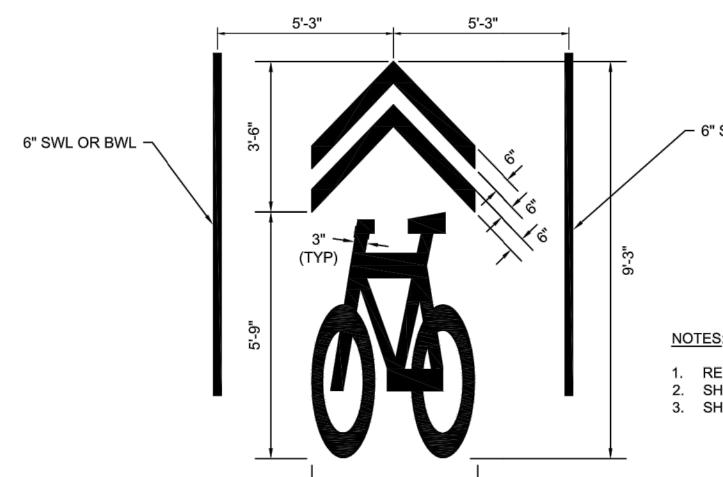- PAVEMENT MARKINGS SHALL BE THERMOPLASTIC AND CONFORM TO MASSDOT STANDARDS.
- 2. CROSSWALK LINE SHOULD BE BETWEEN ONE AND THREE FEET FROM THE CURB.
- CROSSWALK WITH STRIPPING DETAIL, TYP. SCALE: N.T.S.



3'-10"

SHARED LANE PAVEMENT LEGEND DETAIL, TYP.

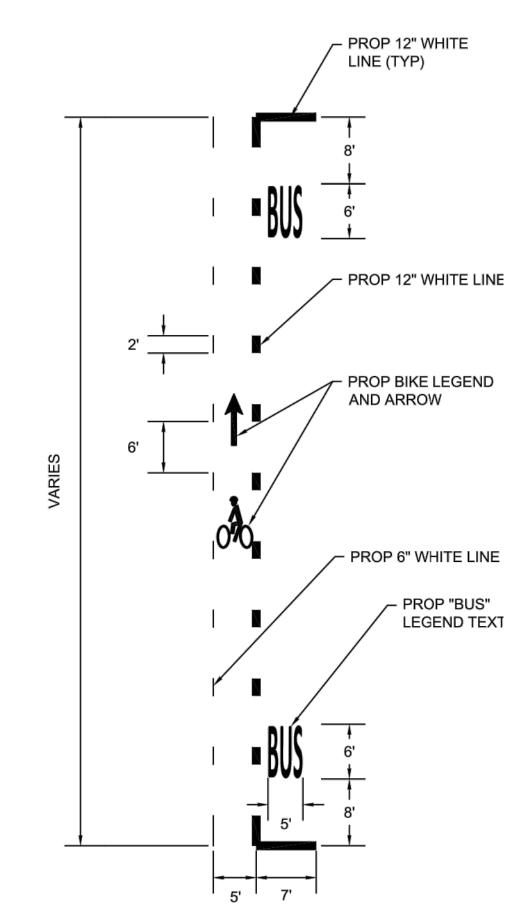
2'-6"

SCALE: N.T.S.

- REFER TO FIGURE 9C-9 IN THE MUTCD FOR MORE DETAIL.
- SHARED LANE MARKINGS SHALL BE EPOXY PAINT. 3. SHARED LANE MARKINGS SHALL BE ONE PIECE.

FED. AID PROJ. NO. NO. SHEETS 90 125 PROJECT FILE NO.







## NOTES:

- BUS STOP PAVEMENT MARKINGS SHOULD BE 7' FROM FACE OF CURB UNLESS OTHERWISE NOTED.
- 2. REFER TO SIGN AND PAVEMENT MARKING PLAN FOR LENGTH OF BUS STOP PAVEMENT MARKINGS.

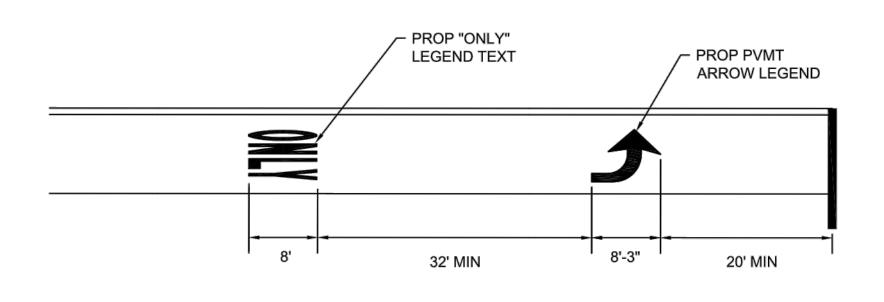
BUS AND BICYCLE LANE MARKING DETAIL, TYP. SCALE: N.T.S.



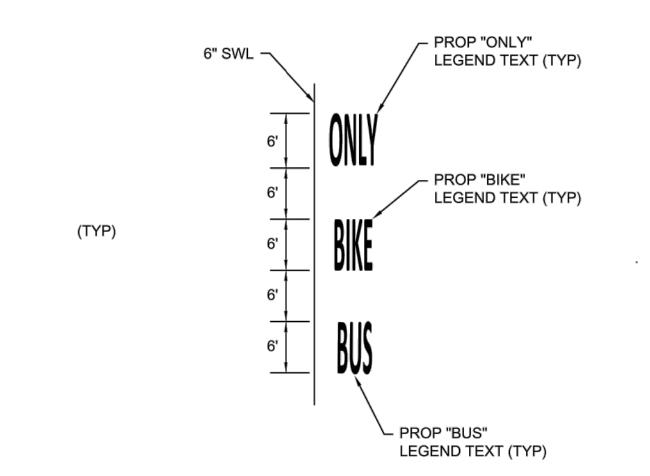
PAVEMENT ARROW AND LEGEND DETAIL, TYP. SCALE: N.T.S.




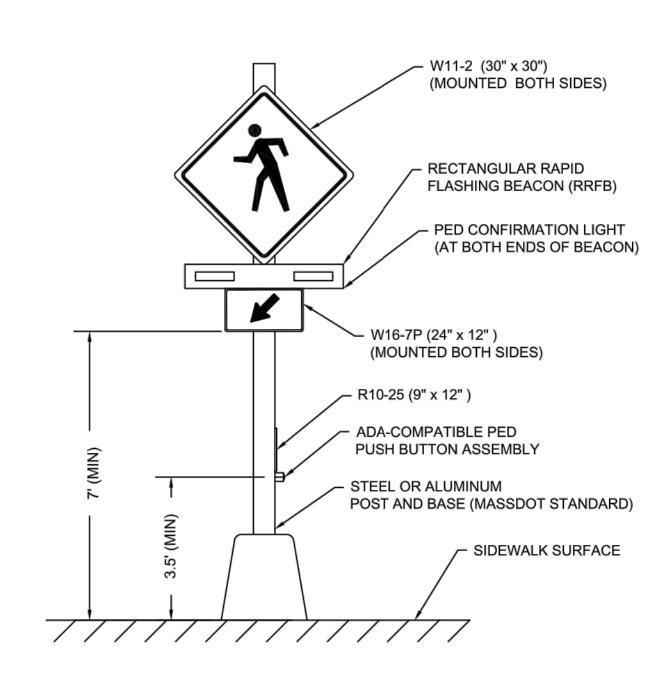- 1. BUS/BIKE/ONLY PAVEMENT MARKINGS SHOULD BE CENTERED IN THE LANE UNLESS OTHERWISE NOTED.
- BUS BIKE ONLY PAVEMENT MARKING DETAIL, TYP. SCALE: N.T.S.



- OPERATION OF RRFB LED LIGHTS SHALL CONFORM TO FHWA INTERIM APPROVAL IA-11.
- 2. EACH RRFB UNIT SHALL CONTAIN A CONFIRMATION LIGHT WITHIN THE BEACON AT EACH END THAT SHALL BE ILLUMINATED WHEN
- THE RRFB UNIT IS ACTIVATED. 3. THE RRFB UNITS AT EACH CROSSWALK LOCATION SHALL
- COMMUNICATE WIRELESSLY WITH EACH OTHER. 4. UPON ACTIVATION OF A WAITING PEDESTRIAN, RRFB UNITS SHALL FLASH SIMULTANEOUSLY FOR A PERIOD OF 20 SECONDS, THEN STOP FLASHING.
- 5. RRFB UNITS SHALL BE "TRAFFIC SAFETY CORP." BRAND OR APPROVED EQUAL.

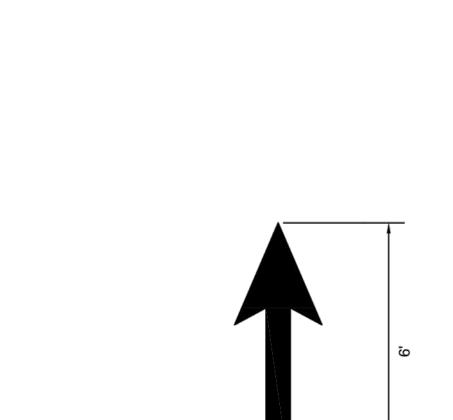


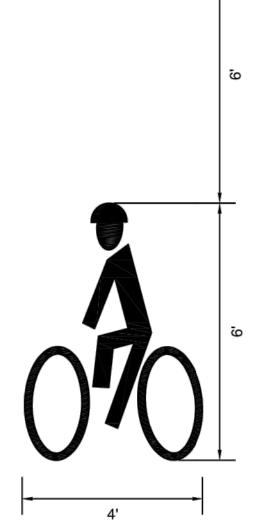

 BIKE LANE PAVEMENT MARKING SHALL BE EPOXY PAINT UNLESS OTHERWISE SPECIFIED.



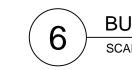BICLYCLE LANE CROSSING PAVEMENT MARKING DETAIL, TYP. SCALE: N.T.S.



RECTANGULAR RAPID FLASHING BEACON (RRFB) DETAIL, TYP. SCALE: N.T.S.

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BICYCLE LANE PAVEMENT - LEGEND DETAIL SCALE: N.T.S.

SEE BICYCLE LANE

PAVEMENT LEGEND DETAIL -

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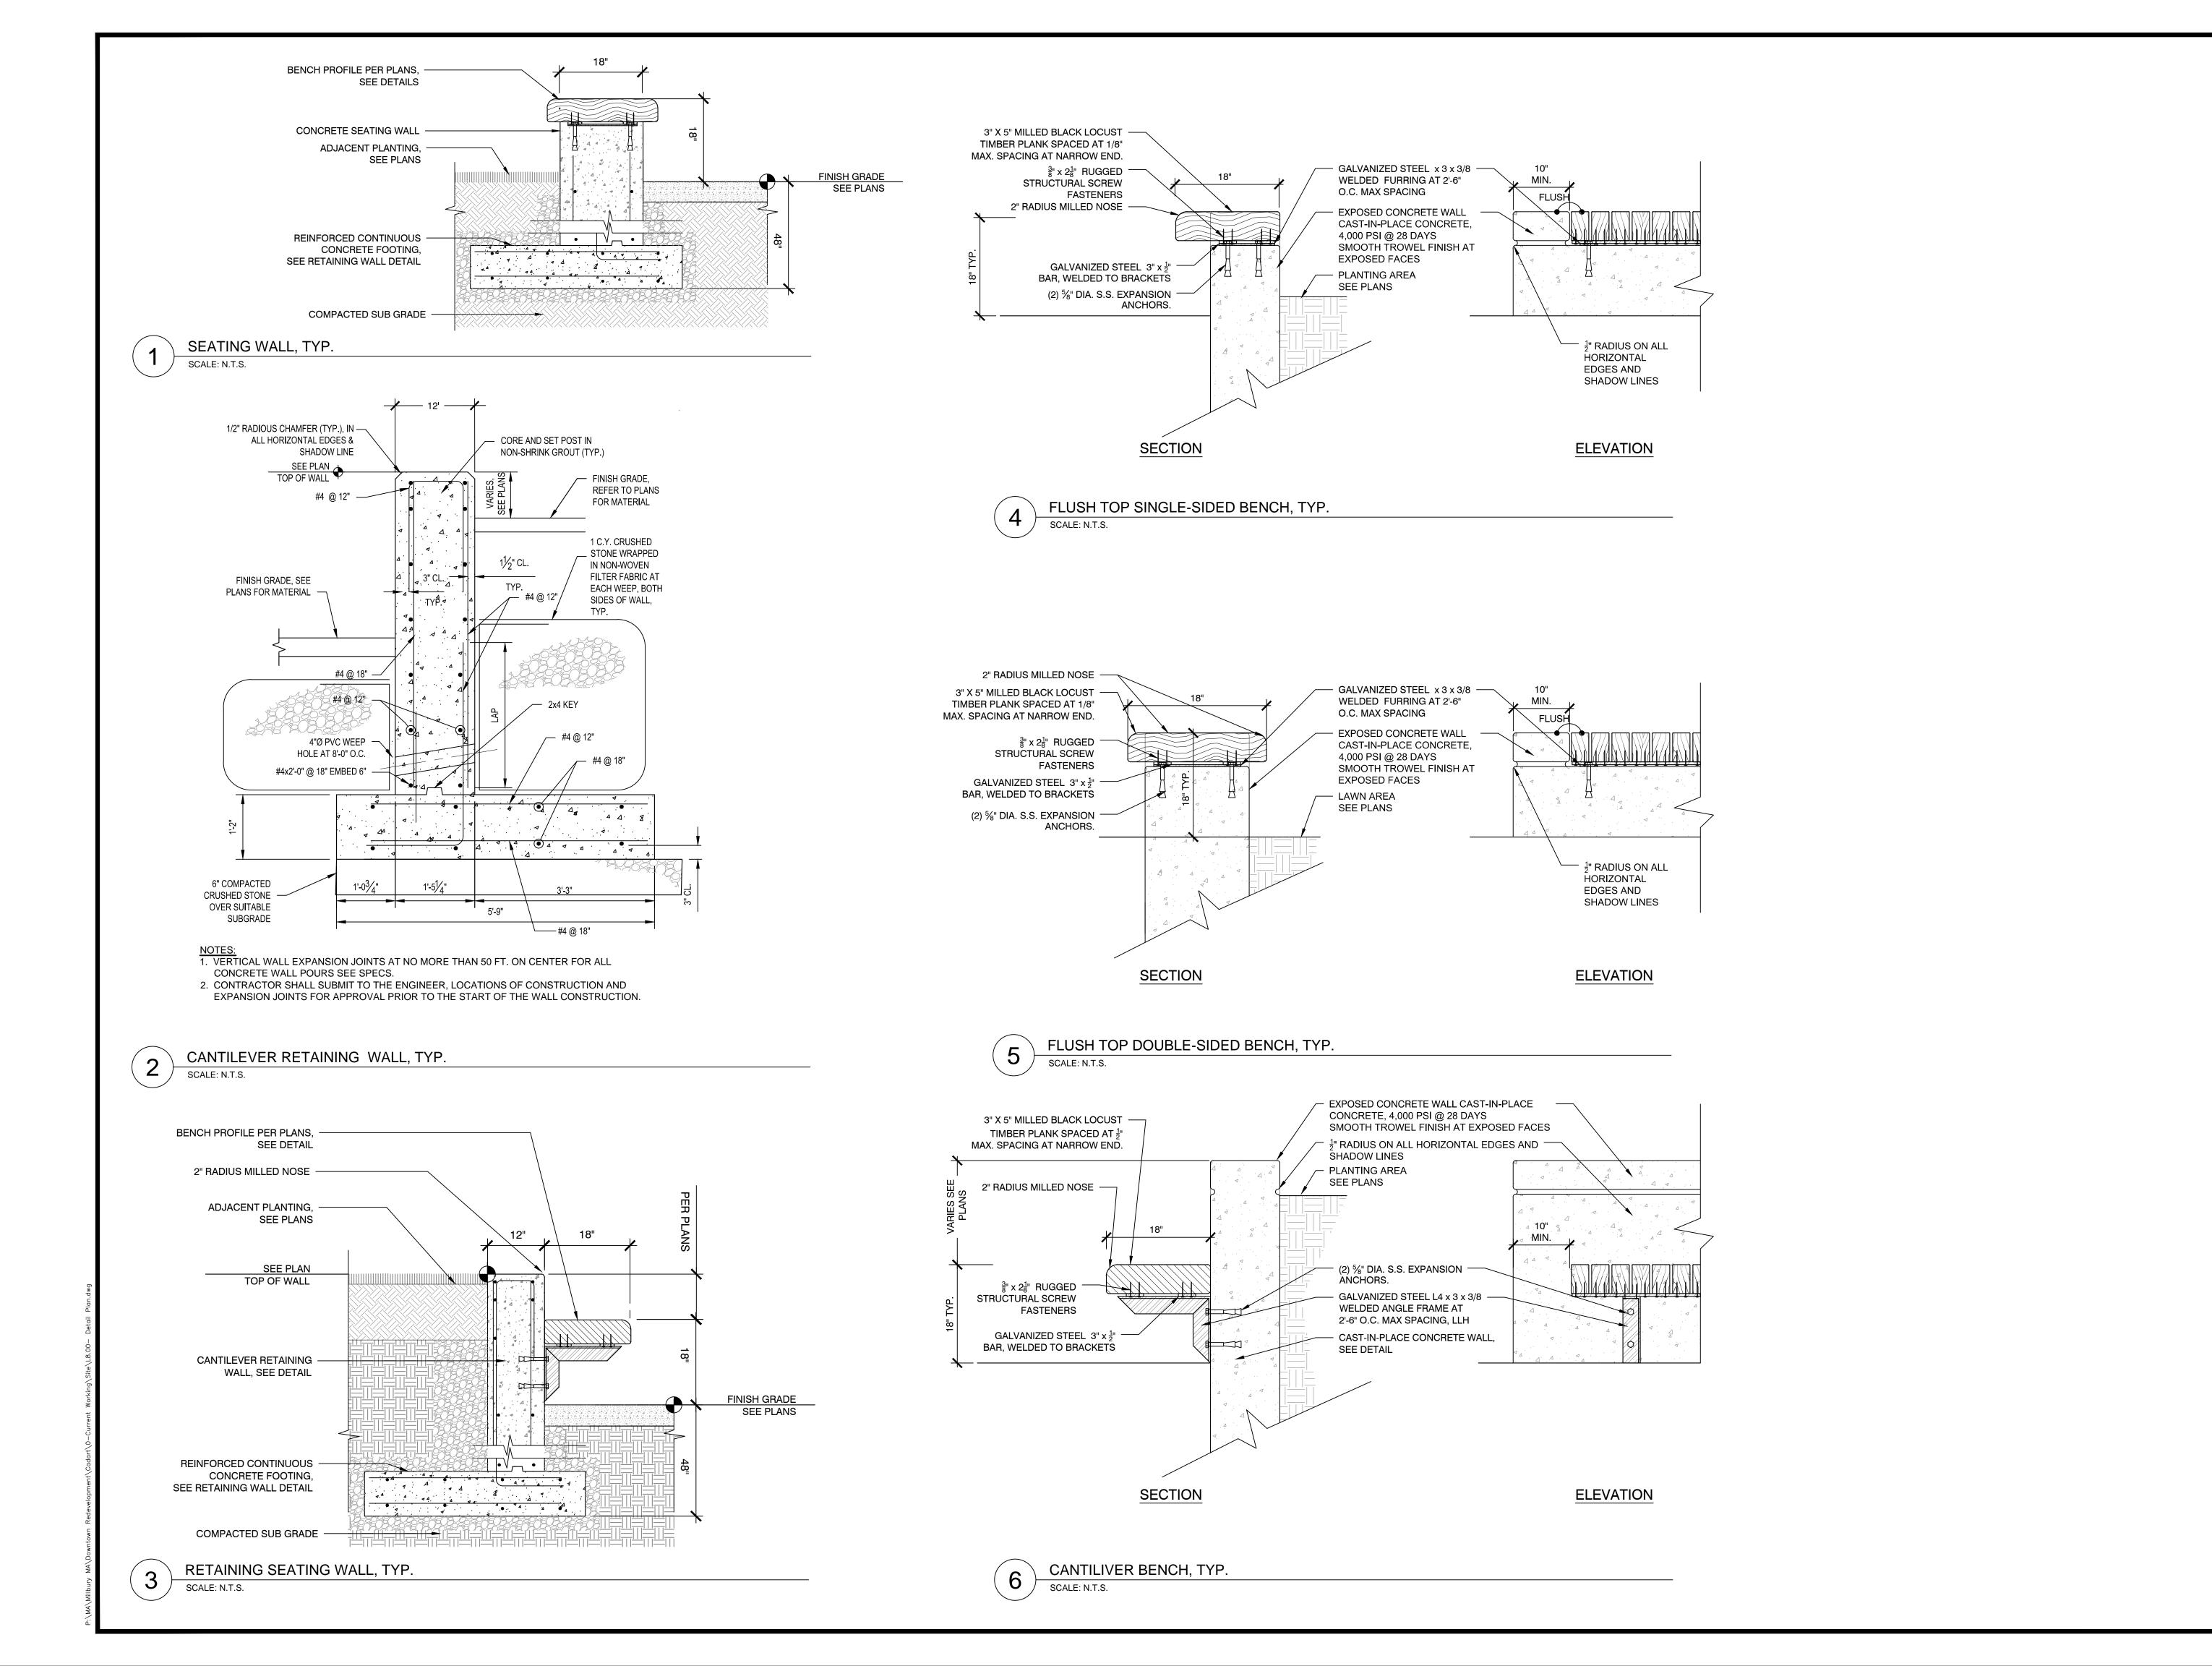
DETAILS

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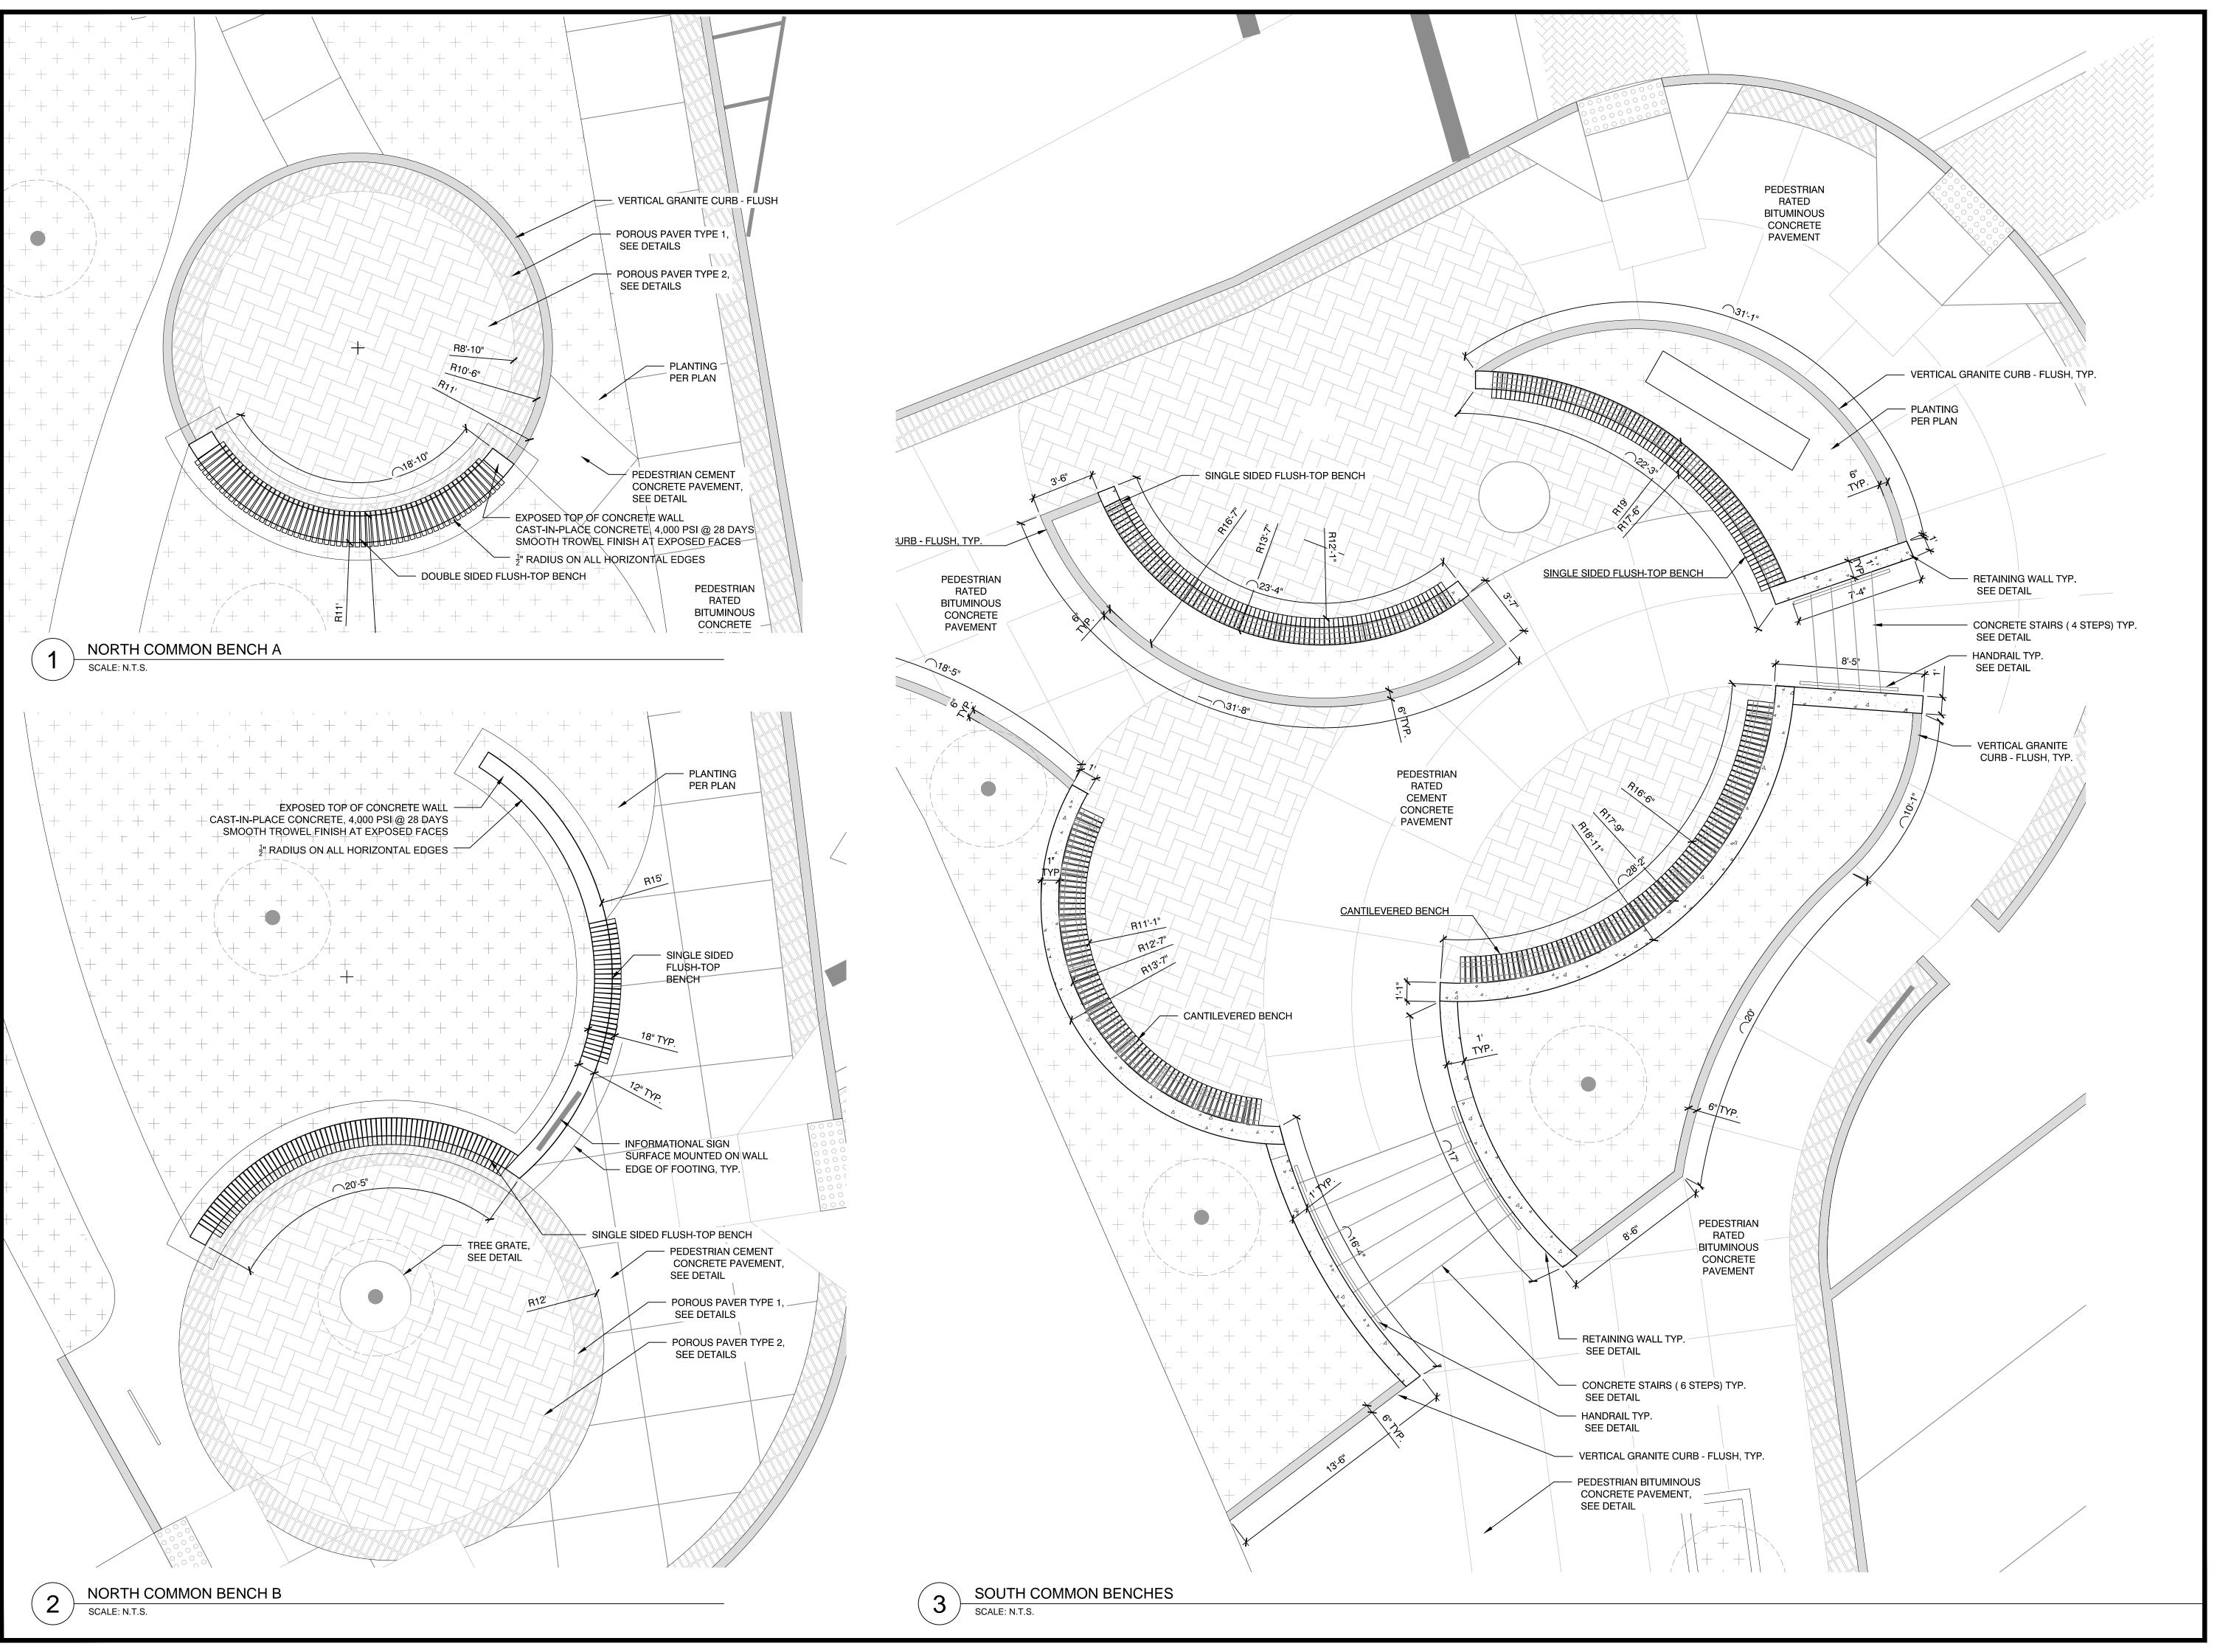
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Drawing Title:

SITE IMPROVEMENT DETAILS

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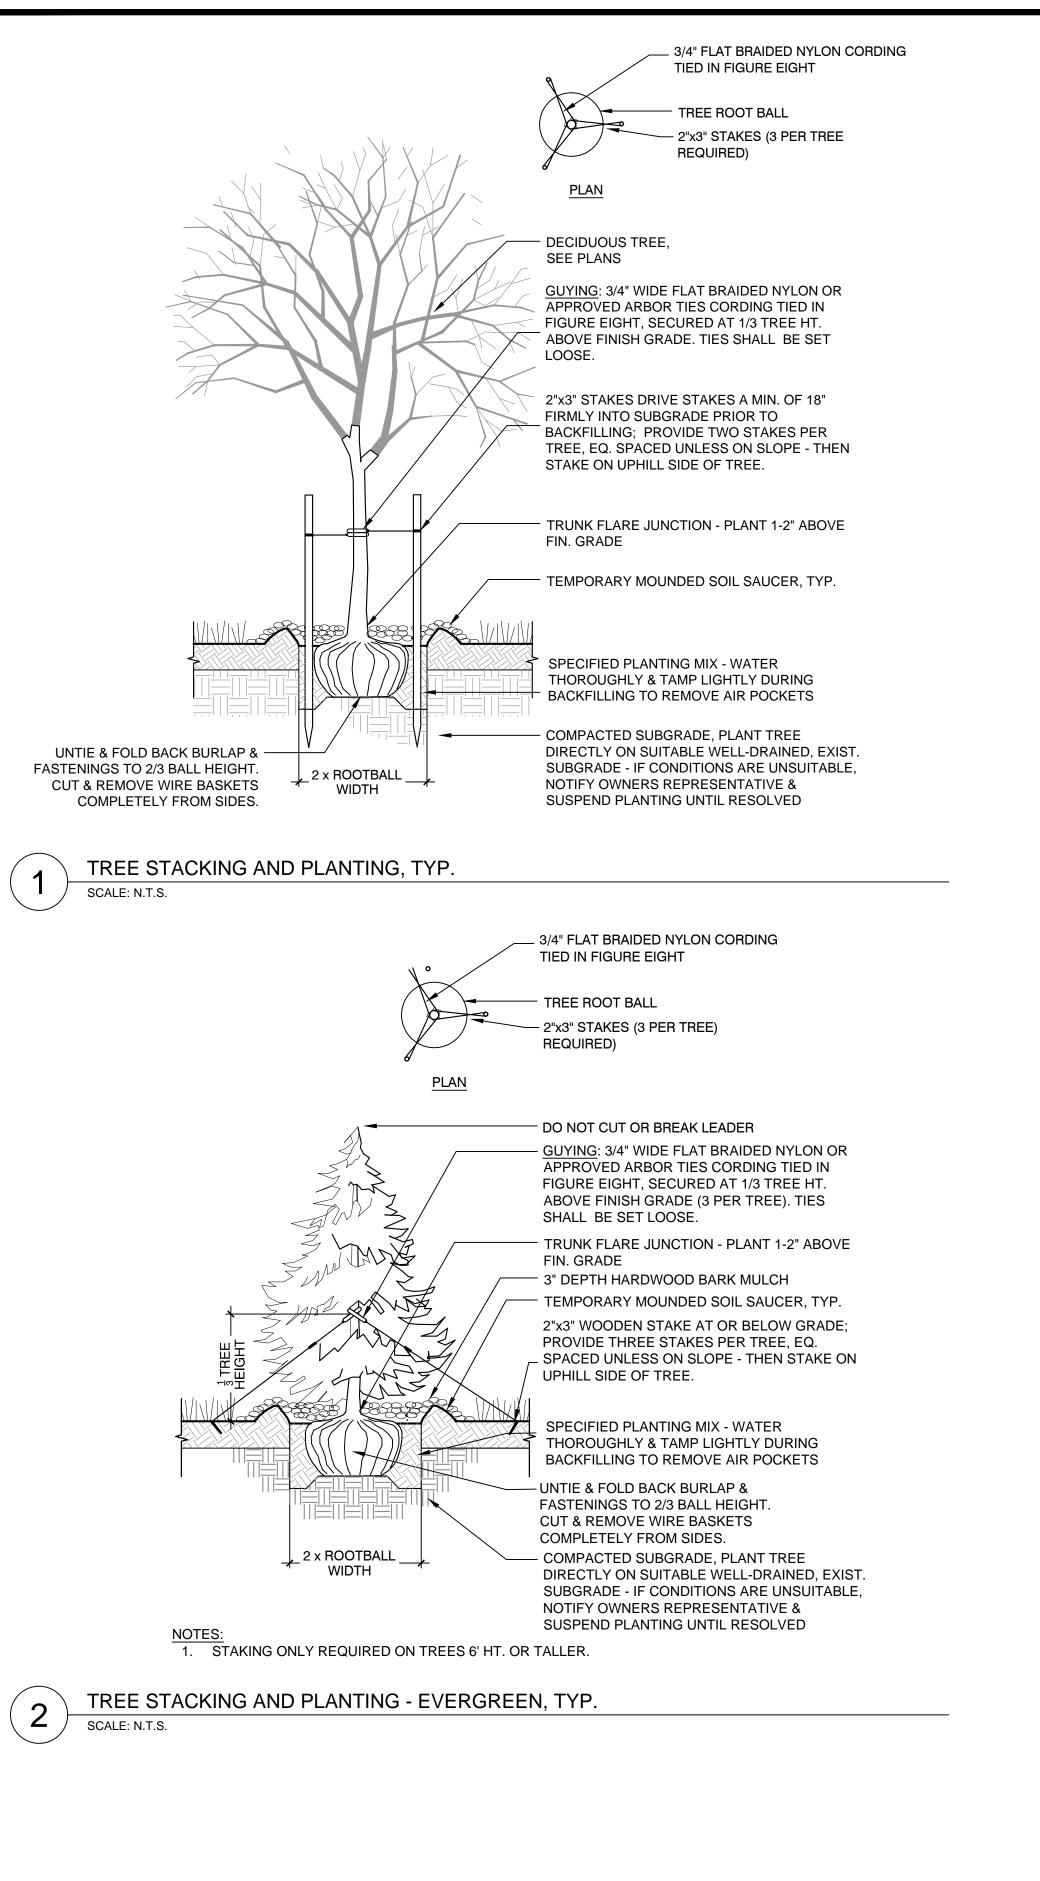
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SITE IMPROVEMENT DETAILS



HYDROMULCH SEED, SEE PLANS

LOAM TOP SOIL AMEND SOIL MIX SEE

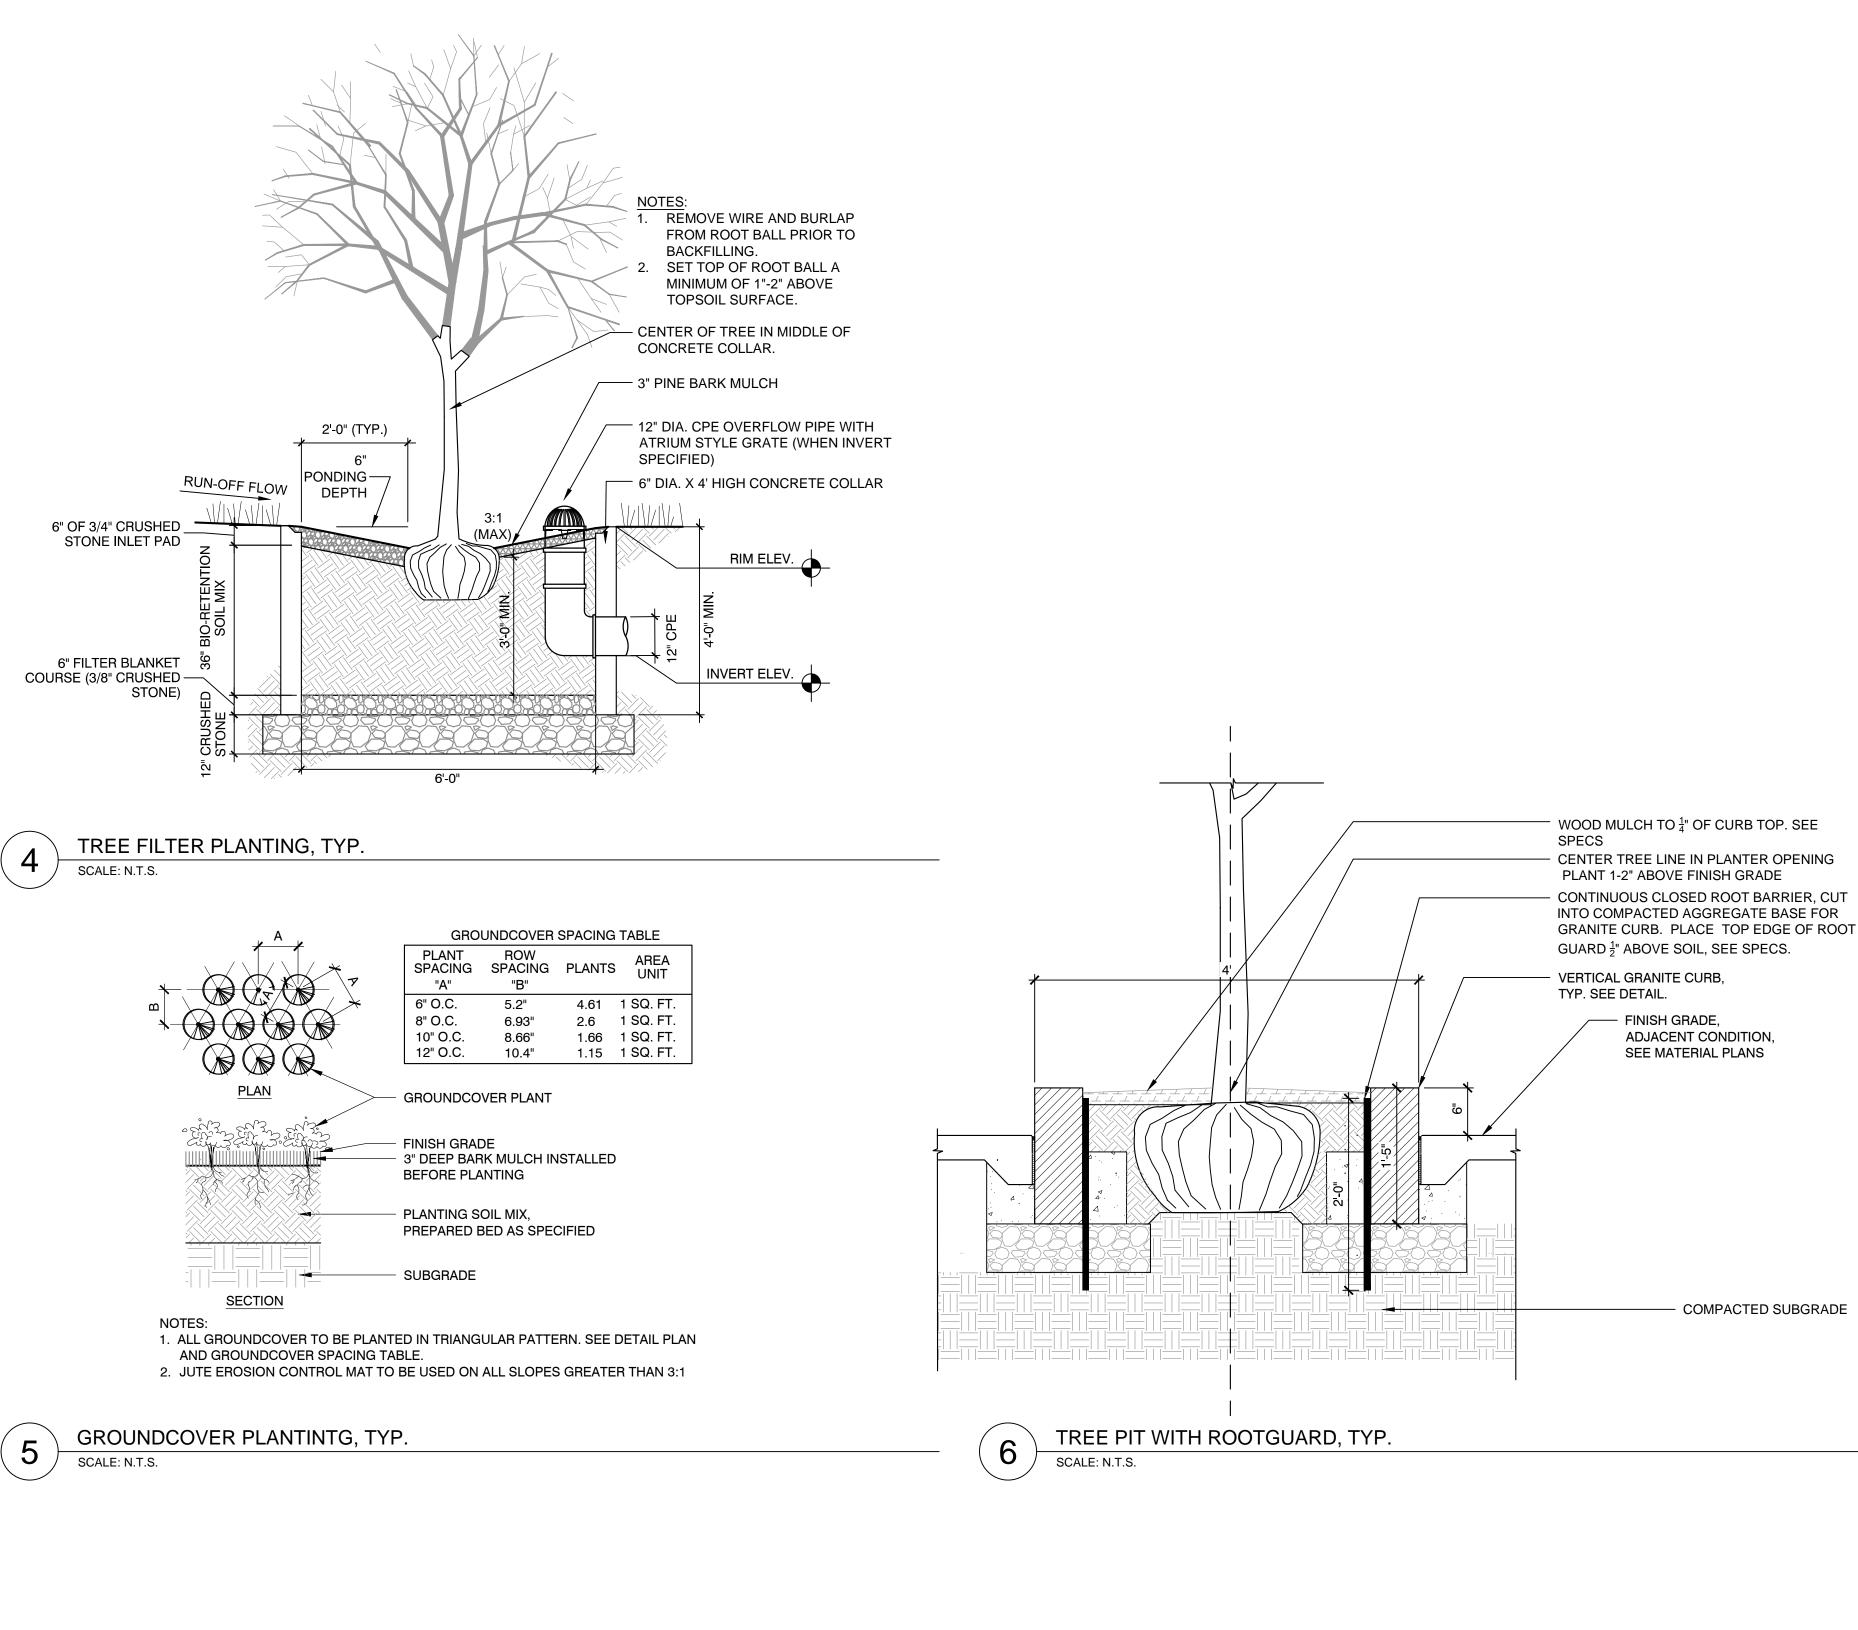
AND SPECIFICATIONS

SPECIFICATIONS

- COMPACTED SUBGRADE

LOAM AND SEED, TYP.

SCALE: N.T.S.



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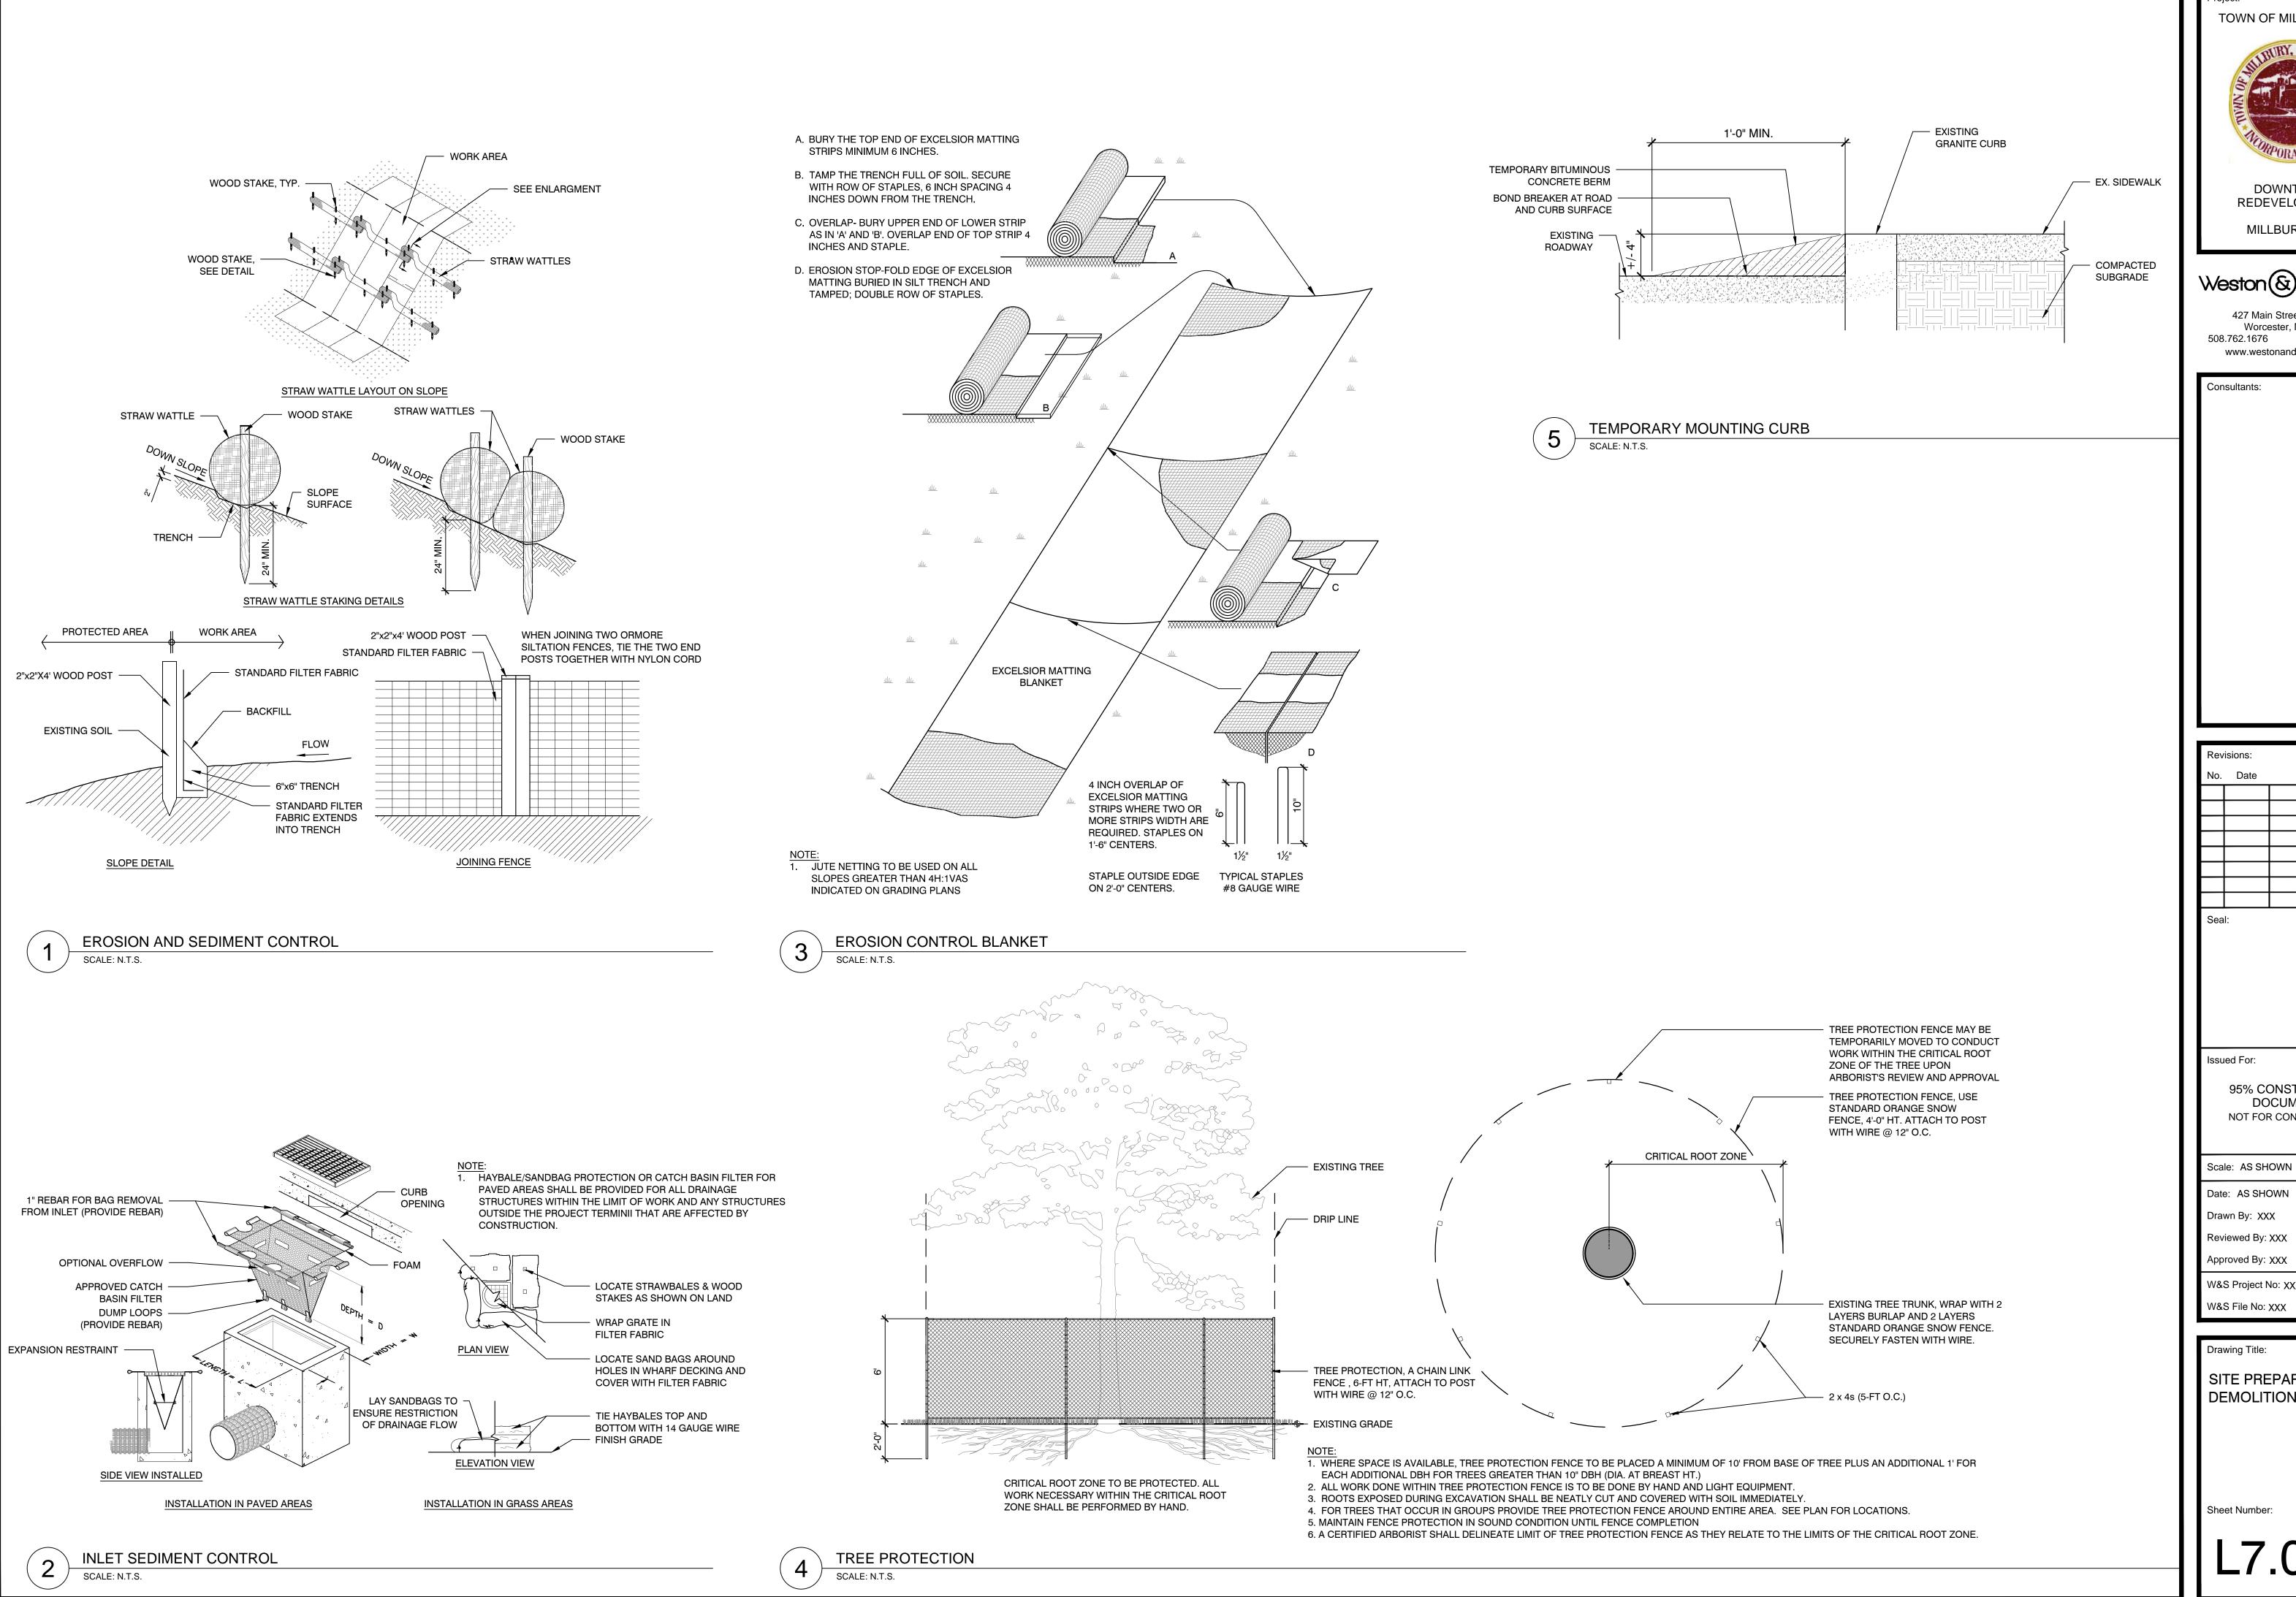
SEE MATERIAL PLANS

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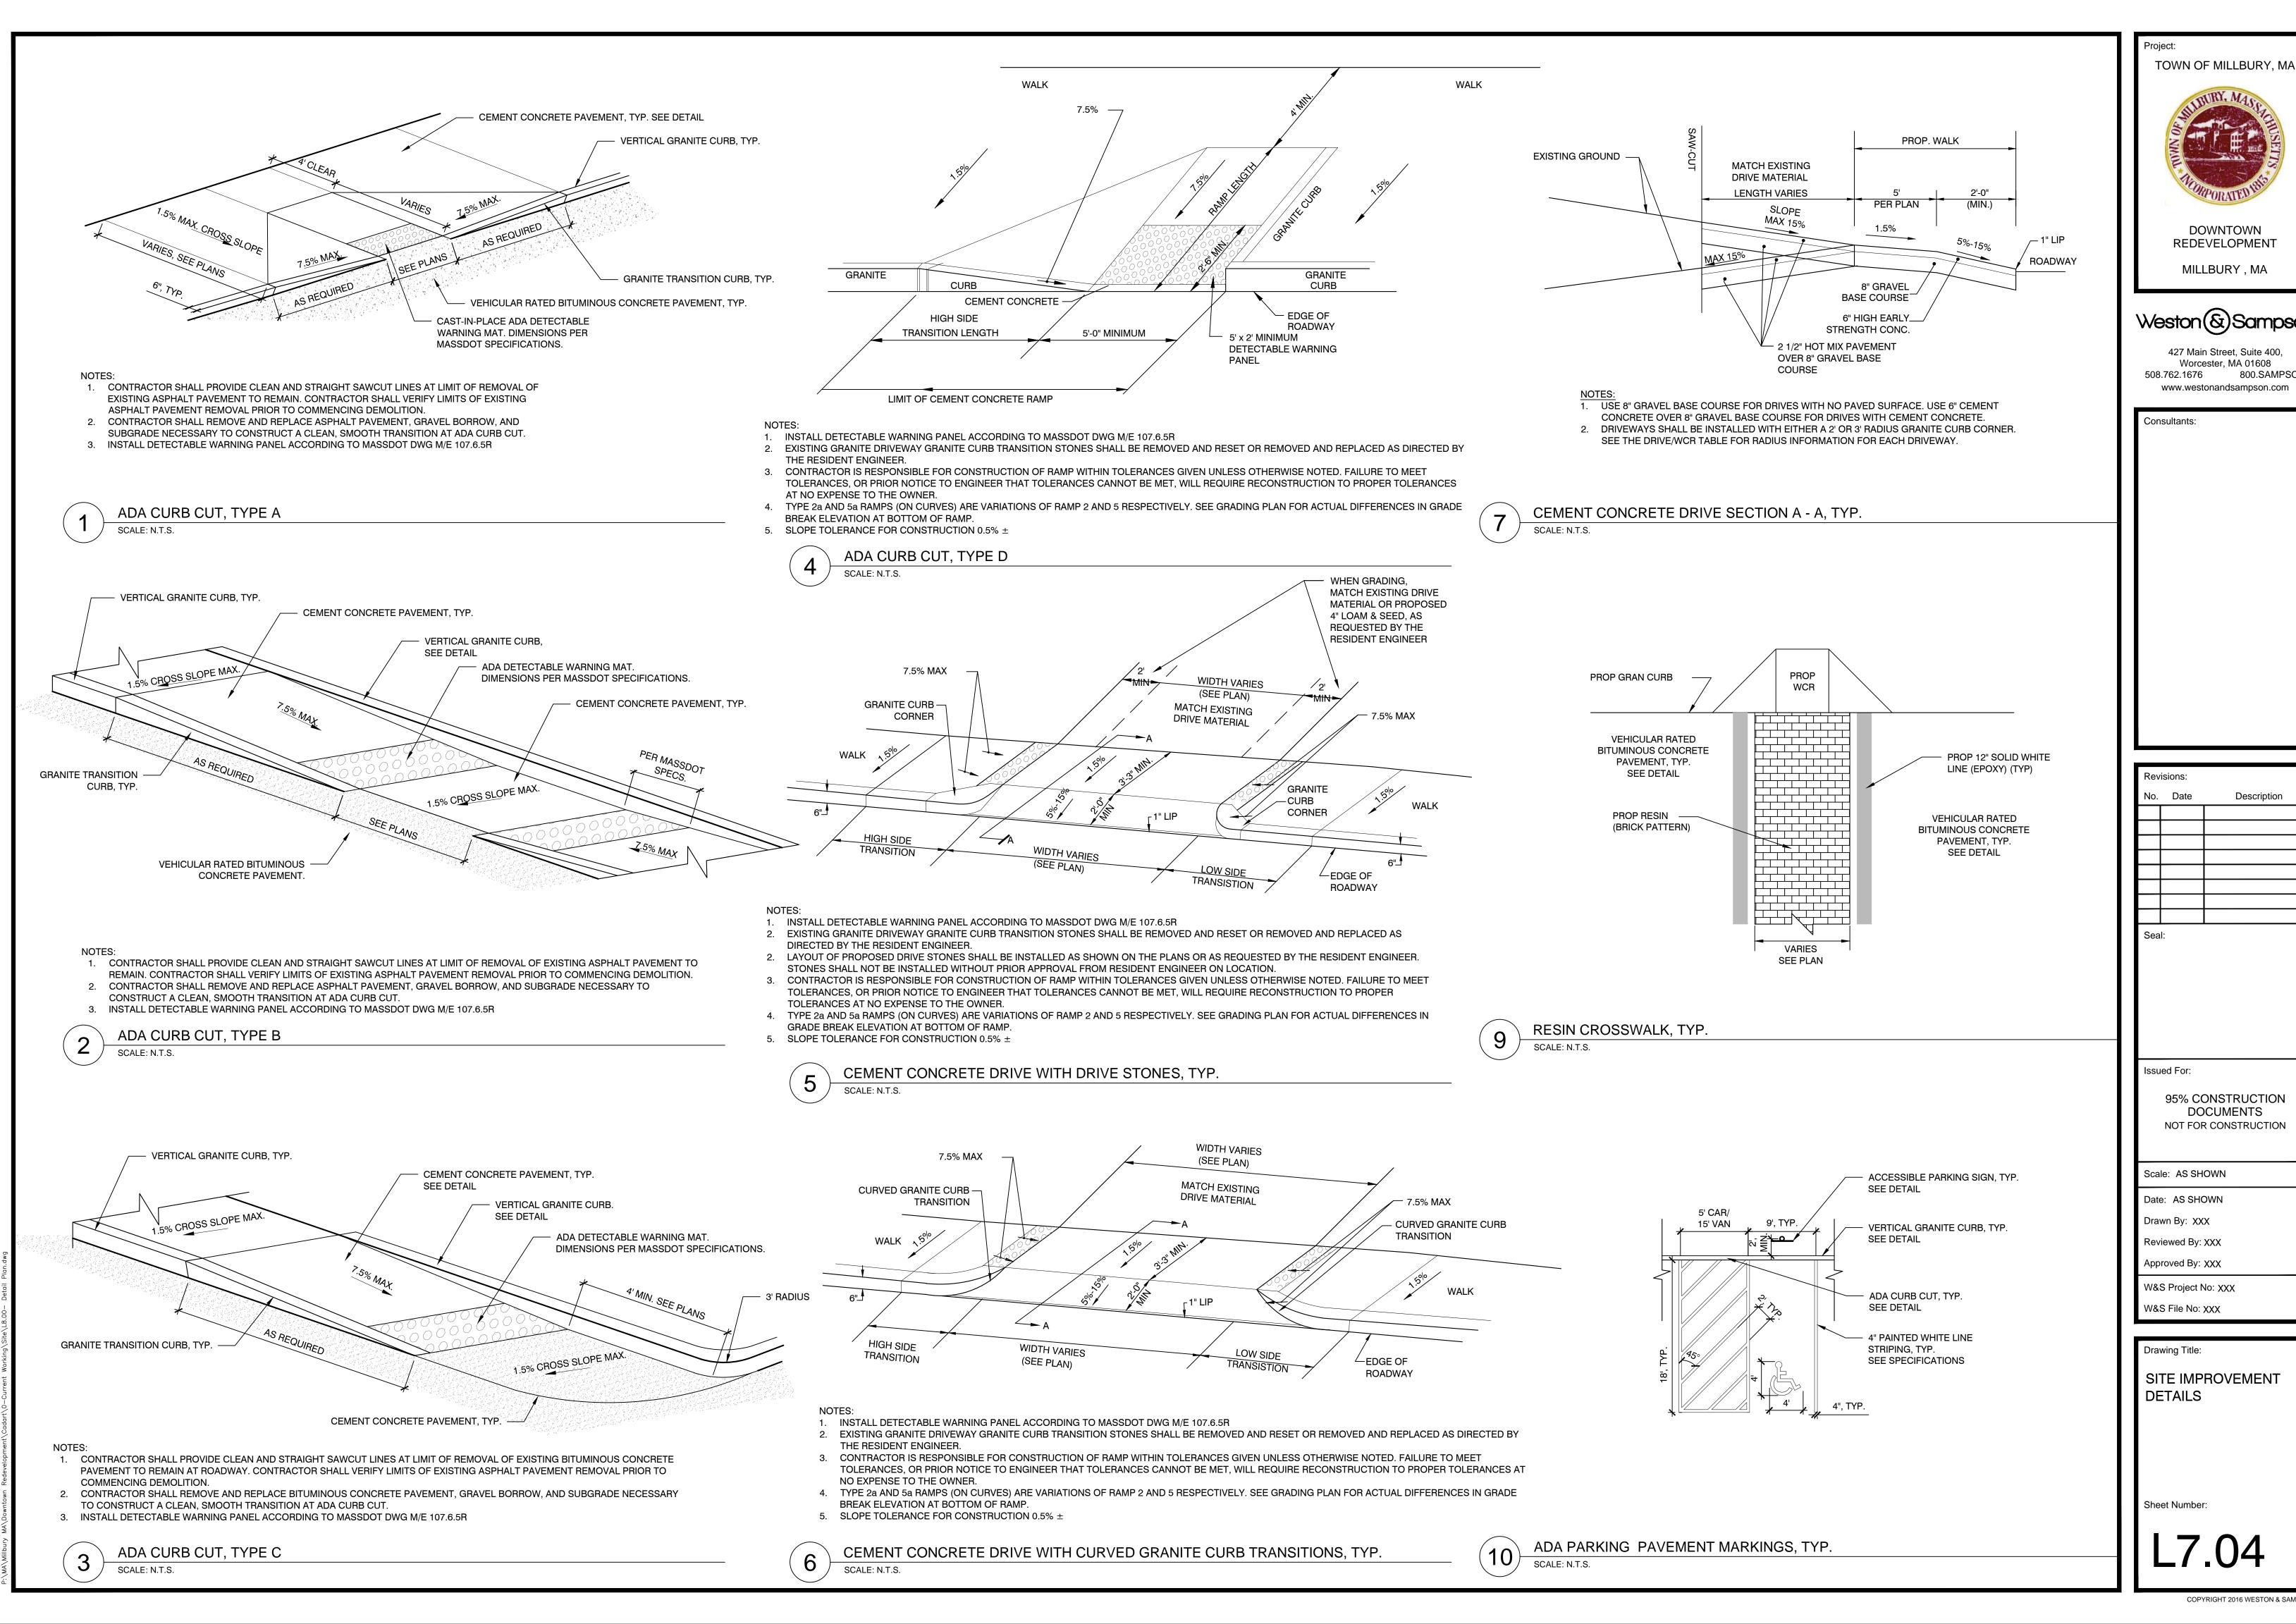
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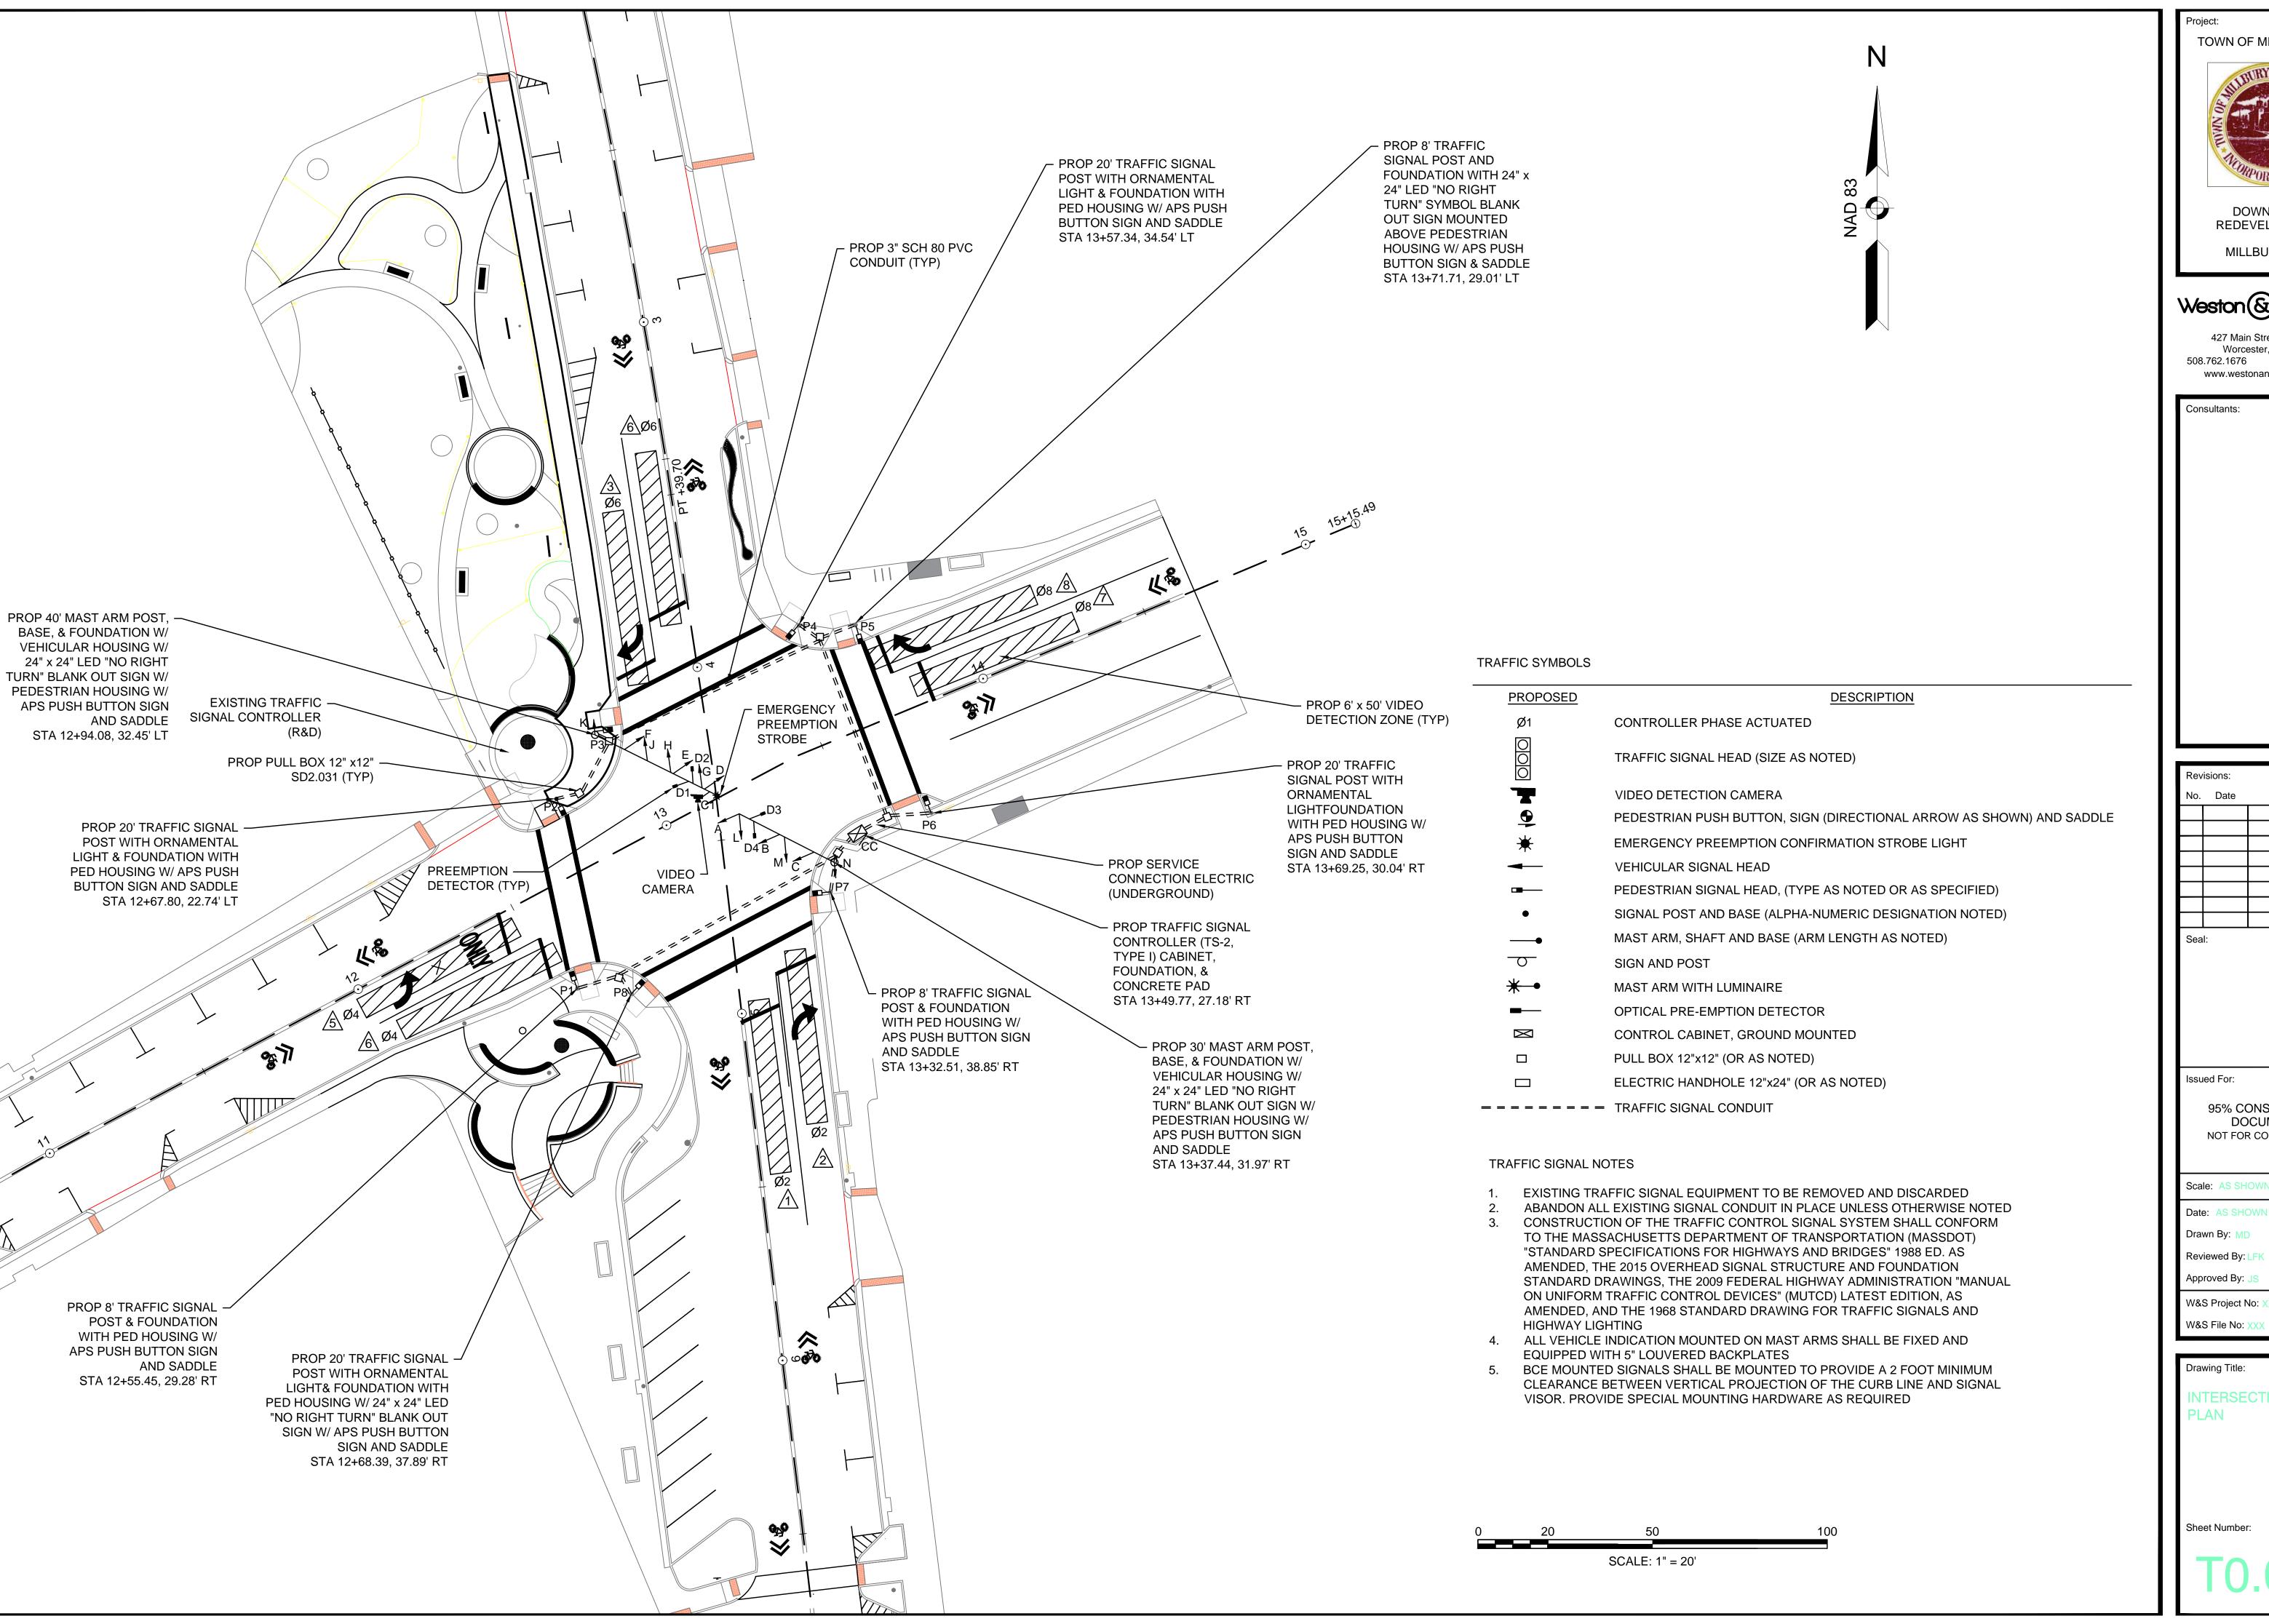
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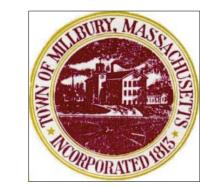


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**INTERSECTION SIGNAL** PLAN

	Ø2	Ø4	Ø6	Ø7	Ø8	Ø9
NAD 83 Z		·	<b>▼</b>		ļ ,	(PED.)
	- H	4 17		4 H		

				1											l .						
SEQUENCE AND TIMING FOR FUI	LL ACTUATED CON	TROL (ISOL	ATED)																		
STREET	DIRECTION	HOUSINGS	1	2	3	4	5	6	7	8	9	1	2	3	10	11	12	13	14	15	FLASH OPER.
ELM STREET	EB	А	R	R	R	FYA	Υ	R	R	R	R	G	Υ	Υ	R	R	R				FR
ELM STREET	EB	В	R	R	R	G	Υ	R	R	R	R	R	R	R	R	R	R				FR
ELM STREET	EB	С	R	R	R	G	Υ	R	R	R	R	R	R	R	R	R	R				FR
ELM STREET	WB	D	R	R	R	R	R	R	R	R	R	R	R	R	G	Υ	R				FR
ELM STREET	WB	Е	R	R	R	R	R	R	R	R	R	R	R	R	G	Υ	R				FR
ELM STREET	WB	F	R	R	R	R	R	R	R	R	R	R	R	R	G	Υ	R				FR
N. MAIN STREET	SB	G	R	R	R	R	R	R	G	Υ	R	R	R	R	R	R	R				FY
N. MAIN STREET	SB	Н	R	R	R	R	R	R	G	Υ	R	R	R	R	R	R	R				FY
N. MAIN STREET	SB	J	R	R	R	R	R	R	G	Υ	R	R	R	R	R	R	R				FYR
N. MAIN STREET	SB	K	R	R	R	R	R	R	G	Υ	R	R	R	R	R	R	R				FYR
S. MAIN STREET	NB	L	G	Υ	R	R	R	R	R	R	R	R	R	R	R	R	R				FY
S. MAIN STREET	NB	М	G	Υ	R	R	R	R	R	R	R	R	R	R	R	R	R				FY
S. MAIN STREET	NB	N	G	Υ	R	R	R	R	R	R	R	R	R	R	R	R	R				FY
PEDESTRIAN CROSSING	EB-WB	P3-P4	DW	DW	DW	DW	DW	DW	DW	DW	DW	DW	DW	DW	DW	DW	DW	W	FDW	DW	
PEDESTRIAN CROSSING	NB-SB	P1-P2	DW	DW	DW	DW	DW	DW	DW	DW	DW	DW	DW	DW	DW	DW	DW	W	FDW	DW	
PEDESTRIAN CROSSING	EB-WB	P7-P8	DW	DW	DW	DW	DW	DW	DW	DW	DW	DW	DW	DW	DW	DW	DW	W	FDW	DW	
PEDESTRIAN CROSSING	NB-SB	P5-P6	DW	DW	DW	DW	DW	DW	DW	DW	DW	DW	DW	DW	DW	DW	DW	W	FDW	DW	
		TIMIT	NG IN	SECO	NDS				•			•		•			•		•		
MINIMUM GREEN (INITIAL)			5			10			10			5			10						
PASSAGE TIME (VEHICLE)			3			3			3			3			3						
MAXIMUM 1			12			48			12			7.5			37						
MAXIMUM 2			18			40			18			7.5			29						
YELLOW CLEARANCE				3.5			3.5			3.5			3.5			3.5					CY
RED CLEARANCE					1.5			1.5			1.5			-			1.5			3	EMERGENCY ONLY
WALK (W)																		7			ERG
PEDESTRIAN CLEARANCE																			13		E
DEGALI				<u> </u>			<u></u>														
RECALL				MIN	014	+	MIN			OFF			OFF		OFF				OFF		
MEMORY			NC	N-LO	CK	NC	DN-LO	CK	NC	N-LO	CK	NC	N-LO	CK	_ NC	N-LO	CK		LOCK		

MAX 1 - ALL OTHER TIMES

MAX 2 - PM PEAK HOURS 3-6 PM

★ PEDESTRIAN PHASE UPON PUSH BUTTON ACTIVATION ONLY


24" x 24" LED "NO RIGHT TURN" BLANK OUT SIGNS SHALL BE ILLUMINATED DURING EXCLUSIVE PEDESTRIAN PHASE

Ø2+Ø6	Ø7	Ø4+Ø8	Ø9*
			**

Ø 8

- ---- = PERMISSIVE MOVEMENT
  - ★ = UPON PUSH BUTTON ACTIVATION

## NEMA DUAL RING PHASING NOTES:

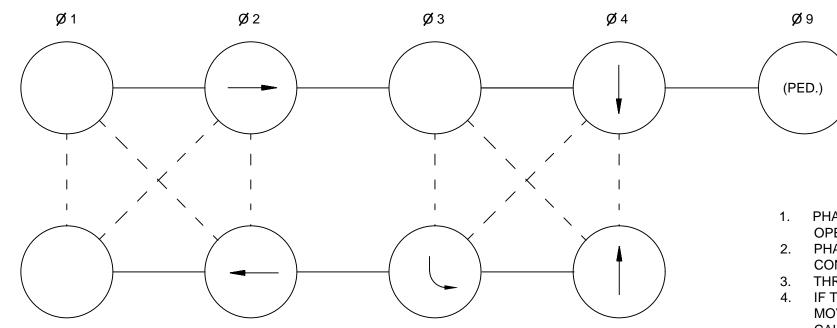

- 1. PHASES ASSOCIATED BY A SOLID LINE SHALL NOT
- OPERATE CONCURRENTLY. 2. PHASES ASSOCIATED BY A DASHED LINE MAY OPERATE
- CONCURRENTLY.
- THROUGH MOVEMENTS MAY INCLUDE RIGHT TURNS. 4. IF THE ASSIGNED RIGHT OF WAY FOR ANY TRAFFIC MOVEMENT IS TO REMAIN IN EFFECT DURING THE NEXT CALLED PHASE, THE SIGNAL INDICATIONS FOR THAT TRAFFIC MOVEMENT SHALL NOT CHANGE DURING THE CHANGE INTERVAL(S) UNLESS OTHERWISE NOTED.

APPROACH	PREEMPTION PHASE DETECTOR	VEHICLE PHASE CALLED	MOVEMENT
EASTBOUND	D1	Ø4	
WESTBOUND	D3	Ø8	<u> </u>
NORTHBOUND	D4	Ø2	
SOUTHBOUND	D2	Ø6	

### EMERGENCY VEHICLE PREEMPTION OPERATION:

- 1. EMERGENCY VEHICLE PREEMPTION SHALL BE ACTUATED BY AN OPTICAL SIGNAL FROM AN OPTICAL EMITTER MOUNTED ON AN EMERGENCY VEHICLE AND RECEIVED BY AN OPTICAL DETECTOR LOCATED AT INTERSECTION. A SEPARATE RECEIVING DETECTOR IS REQUIRED FOR EACH DETECTED APPROACH.
- 2. PREEMPTION SIGNALS FROM MULTIPLE APPROACHES SHALL BE SERVICED ON A FIRST DETECTED FIRST SERVED BASIS.
- 3. IN RESPONSE TO A PREEMPTION SIGNAL RECEIVED AT AN INTERSECTION BY AN OPTICAL DETECTOR, THE CONTROLLER SHALL TIME THE CLEARANCE INTERVALS OF THE ACTIVE PHASE (IF DIFFERENT THAT TO BE SERVICED) AND ADVANCE TO AND/OR HOLD IN EMERGENCY VEHICLE PREEMPTION PHASE UNTIL PREEMPTION SIGNAL CEASES. THE CONTROLLER SHALL THEN TIME CLEARANCES AND SIMILARLY SERVICE OTHER EMERGENCY VEHICLE PREEMPTION SEQUENCES IN THE ORDER RECEIVED (IF RECEIVED) OTHERWISE, RESUME NORMAL PREFERENTIAL PHASE SEQUENCE.
- 4. PREEMPTION MINIMUM GREENS SHALL BE SIX SECONDS. 5. NORMAL CLEARANCES SHALL BE PROVIDED ON PHASES THAT ARE TERMINATED BY PREEMPTION DEMAND.
- 6. ACTUAL TIMMING FOR PREEMPTION SHALL BE DETERMINED IN THE FIELD IN COORDINATION WITH THE FIRE DEPARTMENT AND SHALL BE APPROVED BY MHD PRIOR TO OPERATION.

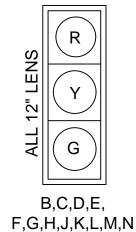
### MAJOR ITEMS REQUIRED PAY ITEM QUANTITY ITEM CONTROLLER NEMA 8 PHASE T52 - TYPE 1 CAB. FDN SERVICE CONNECTION, TYPE UNDERGROUND 8' SIGNAL POLE, BASE & FDN 10' SIGNAL POLE, BASE & FDN 12 | 1 WAY, 3 SECTION, SIGNAL HOUSINGS (12" LED) 1 WAY, 4 SECTION, SIGNAL HOUSINGS (12" LED) "FLASHING YELLOW ARROW" 12 5" 3 SECTION BACK PLATES (LOUVERED) WITH 3" REFLECTIVE BORDER 5" 4 SECTION BACK PLATES( LOUVERED) WITH 3" REFLECTIVE BORDER 16" PEDESTRIAN COUNTDOWN HOUSING, TYPE LED (INT'L SYMBOL) PEDESTRIAN PUSH BUTTON SIGN & SADDLE (APS) EMERGENCY VEHICLE PREEMPTION PHASE SELECTION MODULE DUAL CHANNEL EMERGENCY PREEMPTION RECEIVERS PREEMPTION CARD RACK EMERGENCY VEHICLE PREEMPTION CONFIRMATION STROBE (WHITE) 40' TYPE II GALV. STEEL MAST ARM ASSEMBLY, BASE & FDN 30' TYPE II GALV. STEEL MAST ARM ASSEMBLY, BASE & FDN 24" x 24" LED BLANK OUT PANEL "NO RIGHT TURN" SYMBOL VIDEO DETECTION SYSTEM W/ 360° FISH EYE CAMERA W/ MOUNTING BRACKET & 10' EXTENSION POLE, MULTIPLEXER, MONITOR, AUTOMATIC CONTROL UNIT & POINTING DEVICE, ISOLATION AMPLIFIERS FOR CABLING & SOFTWARE 811.31 12" x 12" PULL BOX SD2.031

PLUS ALL NECESSARY DUCT, CABLE, LABOR, MISCELLANEOUS MATERIAL AND EQUIPMENT TO COMPLETE THE INSTALLATION.

### VIDEO DETECTOR DATA

DETECTOR NUMBER	DETECTOR ZONE SIZE	Ø CALLED	MODE A=PULSE B=PRES.	DELAY TIME	EXT. TIME
1	VIDEO 6'x50'	Ø4	В	-	-
2	VIDEO 6'x50'	Ø2	В	-	-
3	VIDEO 6'x50'	Ø6	В	-	-
4	VIDEO 6'x50'	Ø6	В	-	-
5	VIDEO 6'x50'	Ø4	В	-	-
6	VIDEO 6'x50'	Ø4	В	-	-
7	VIDEO 6'x50'	Ø8	В	-	-
8	VIDEO 6'x50'	Ø8	В	-	-

# PROPOSED SIGNAL IDENTIFICATION





16" LED

**DUAL DISPLAY** ONE SECTION (COUNTDOWN)

# NOTES:

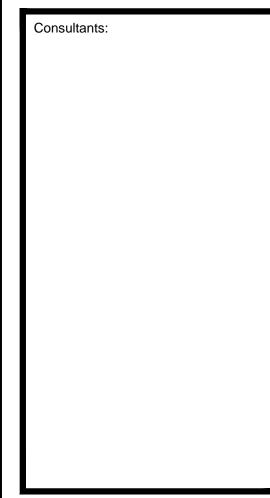
- ALL SIGNALS SHALL HAVE CAP VISORS
- ALL SIGNALS SHALL BE 12" LED WITH 5" LOUVERED BACKPLATES ALL BACKPLATES SHALL HAVE A 3" RETROREFLECTIVE BORDER
- ALL PED INDICATORS SHALL HAVE SUN CAP VISORS 5. SIGNAL HEAD A TO BE FLASHING YELLOW ARROW SETUP

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Drawing Title: SIGNAL TIMING PLAN

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A	ABBREVIATIONS						
AFF AC AFF AT ATS BC CKB EC EWC EWC EFF FLA GGFI GNO HP IG BKW MC MT MT NC NO NIC NTS PNL PH	ABOVE FINISHED FLOOR ALTERNATING CURRENT AMPERE AMP FRAME AMP TRIP  AUTOMATIC TEMPERATURE CONTROL AUTOMATIC TRANSFER SWITCH BREAKER CONDUIT CIRCUIT CIRCUIT CIRCUIT BREAKER ELECTRICAL CONTRACTOR ELECTRIC METALLIC TUBING ELECTRIC WATER COOLER ELECTRIC WATER HEATER EXHAUST FAN FLOOR FULL LOAD AMPERE GENERAL CONTRACTOR GROUND FAULT INTERRUPTER GROUND HAND OFF AUTOMATIC HORSEPOWER ISOLATED GROUND JUNCTION BOX KILOVOLT AMPERES KILOWATT MAIN CIRCUIT BREAKER MAIN LUGS ONLY MECHANICAL CONTRACTOR MOUNTED MOUNTING NON-METALLIC CONDUIT NORMALLY CLOSED NORMALLY OPEN NOT APPLICABLE NOT IN CONTRACT NOT TO SCALE PANELBOARD PHASE						
PVC RSC	POLYVINYL CHLORIDE CONDUIT RIGID GALVANIZED STEEL CONDUIT						
RSC SF	RIGID GALVANIZED STEEL CONDUIT SUPPLY FAN						
SS	SAFETY SWITCH						
TEL	TELEPHONE						
TRF	TRANSFORMER						
V	VOLTS						

WATTS OR WIRE

WEATHERPROOF

RECEPTACLE ABBREVIATIONS

PERSONAL PROTECTION

GROUND FAULT CIRCUIT INTERUPTER,

WEATHERPROOF RECEPTACLE WITH

COVERPLATE LISTED FOR WET LOCATION WITH AN ATTACHMENT PLUG INSERTED.

4-WIRE SOLID NEUTRAL

4WSN

## ELECTRICAL LEGEND

## RACEWAY AND WIRING

HOME RUNS ARE 3/4"C., 2#12 & 1#12 GND. UNLESS NOTED OTHERWISE ON

UNDERGROUND RACEWAY \_\_\_\_

### LIGHTING FIXTURES

POLE & FIXTURE - 'P1' INDICATES POLE TYPE, 'A' INDICATES FIXTURE TYPE

# RECEPTACLES

DUPLEX CONVENIENCE OUTLET RATED 20A, 125V, U-SLOT

GROUNDED TYPE . REFER TO RECEPTACLE ABBREVIATIONS FOR SPECIAL PURPOSE RECEPTACLES. GFI INDICATES GROUND FAULT INTERRUPTING TYPE.

### POWER DISTRIBUTION EQUIPMENT

HAND HOLE

1,3 LP1B

GROUND - SYSTEM AND/OR EQUIPMENT

### **GENERAL NOTES**

- DRAWINGS ARE DIAGRAMMATIC ONLY. THE EXACT LOCATION, MOUNTING HEIGHTS, SIZE OF EQUIPMENT AND ROUTING OF RACEWAYS SHALL BE COORDINATED AND DETERMINED IN THE
- WORK SHALL CONFORM TO THE MASSACHUSETTS ELECTRICAL CODE AND MASSACHUSETTS BUILDING CODE AND REQUIREMENTS OF LOCAL AUTHORITIES HAVING JURISDICTION.
- THE WORD "CONTRACTOR" AS USED IN THE "ELECTRICAL WORK" SHALL MEAN THE ELECTRICAL SUBCONTRACTOR.
- CONTRACTOR SHALL PAY FOR ALL PERMITS, INSURANCE AND TESTS, AND SHALL PROVIDE LABOR AND MATERIAL TO COMPLETE THE ELECTRICAL WORK SHOWN.
- CONTRACTOR SHALL PAY ELECTRIC UTILITY COMPANY BACKCHARGES AND PROVIDE COORDINATION WITH SAME.
- EXCEPT AS OTHERWISE NOTED, THE ELECTRICAL WORK SHALL INCLUDE PANELBOARDS, CIRCUIT BREAKERS, FEEDERS, WIRING, RACEWAYS, LIGHTING FIXTURES, DEVICES, SAFETY SWITCHES, MOUNTING AND WIRING, TRANSFORMERS AND CONNECTIONS NECESSARY TO OPERATE ALL EQUIPMENT.
- THE CONTRACTOR SHALL PROVIDE ALL TEMPORARY LIGHTING AND POWER AND PAY ALL ENERGY CHARGES.
- DURING CONSTRUCTION, THE ELECTRICAL CONTRACTOR SHALL KEEP HIS PORTION OF THE WORK NEAT, CLEAN AND ORDERLY.
- 9. ALL SYSTEMS SHALL BE TESTED FOR SHORT CIRCUIT AND GROUNDS PRIOR TO ENERGIZING AND ANY DEFECTS SHALL BE CORRECTED.
- 10. ALL CUTTING AND PATCHING REQUIRED FOR ELECTRICAL WORK SHALL BE INCLUDED AS PART OF THIS SECTION.
- 1. COMPLETE SHOP DRAWINGS SHALL BE SUBMITTED FOR ELECTRICAL EQUIPMENT. WHERE SPECIFIED, ELECTRICAL EQUIPMENT IS SUBSTITUTED. THE ELECTRICAL CONTRACTOR SHALL SUBMIT COMPLETE SPECIFICATIONS ON THE SUBSTITUTE AS WELL AS THE ITEM ORIGINALLY
- 12. MATERIALS SHALL BE SPECIFICATION GRADE AND UL LISTED.
- 13. WHERE MATERIAL IS CALLED OUT IN THE LEGEND BY MANUFACTURER, TYPE OR CATALOG NUMBER, SUCH DESIGNATIONS ARE TO ESTABLISH STANDARDS OR DESIRED QUALITY. ACCEPTANCE OR REJECTIONS OF PROPOSED SUBSTITUTIONS SHALL BE SUBJECT TO THE APPROVAL OF THE OWNER.
- 14. WORK SHALL BE COORDINATED WITH THAT OF OTHER TRADES TO ELIMINATE INTERFERENCES.
- 15. ELECTRICAL WORK SHALL BE GUARANTEED FOR A PERIOD OF ONE YEAR FROM DATE OF WHICH SYSTEM IS PUT INTO SERVICE.
- 16. WORK SHALL BE GROUNDED IN ACCORDANCE WITH CODE REQUIREMENTS. COMPLETE EQUIPMENT (INSULATED GREEN WIRE) GROUNDING SYSTEM SHALL BE INSTALLED.
- 17. WIRE SHALL BE TYPE "THHN/THWN" INSULATED FOR 600 VOLTS, MINIMUM SIZE #12 AWG COPPER UNLESS SPECIFICALLY NOTED OTHERWISE.
- 18. WIRING METHODS:
  - A. ALL BELOW GRADE DIRECT BURIED CONDUIT SHALL BE SCHEDULE 80 PVC.
  - B. ALL BELOW GRADE CONCRETE ENCASED CONDUITS SHALL BE SCHEDULE 40 PVC.
  - C. ALL ABOVE GRADE CONDUITS SHALL BE RGS.
- 19. PANELBOARDS SHALL BE DEAD FRONT, THERMAL MAGNETIC BOLT-ON CIRCUIT BREAKER TYPE, DESIGNED FOR SURFACE MOUNTING AS INDICATED ON PLAN, AND HAVING CONNECTIONS TO 120/240 VOLT, 3 PHASE, 4 WIRE SERVICE. ALL BUS BARS SHALL BE COPPER. CABINETS SHALL BE MADE OF CODE GAUGE GALVANIZED SHEET STEEL, WITH A MINIMUM OF 4 INCH GUTTERS, DOOR IN DOOR CONSTRUCTION, LOCKED DOOR, AND FLUSH HINGES. TYPEWRITTEN INDEX SHALL BE MOUNTED ON DOOR INSIDE TRANSPARENT COVER INDICATING LOAD SERVED. PANELS SHALL INCLUDE SEPARATE EQUIPMENT GROUND BUS.
- 20. CONDUIT RUNS AS SHOWN ON THE PLANS ARE DIAGRAMMATIC ONLY EXACT LOCATION AND METHOD OF SUPPORT SHALL BE DETERMINED IN THE FIELD.
- 21. CONTRACTOR SHALL CHECK EXISTING CONDITIONS TO DETERMINE EXACT EXTENT OF WORK TO BE PERFORMED PRIOR TO BIDDING. DIMENSIONS RELEVANT TO EXISTING WORK SHALL BE VERIFIED IN THE FIELD.
- 22. PROVIDE AS-BUILT "CADD" DRAWINGS AT THE COMPLETION OF THE PROJECT.
- 23 UTILITY WORK ORDERS FROM NATIONAL GRID: BILLBOARD SERVICE - 27758565 TRAFFIC CONTROL CABINET SERVICE - TBD STREET LIGHTING SERVICE - TBD

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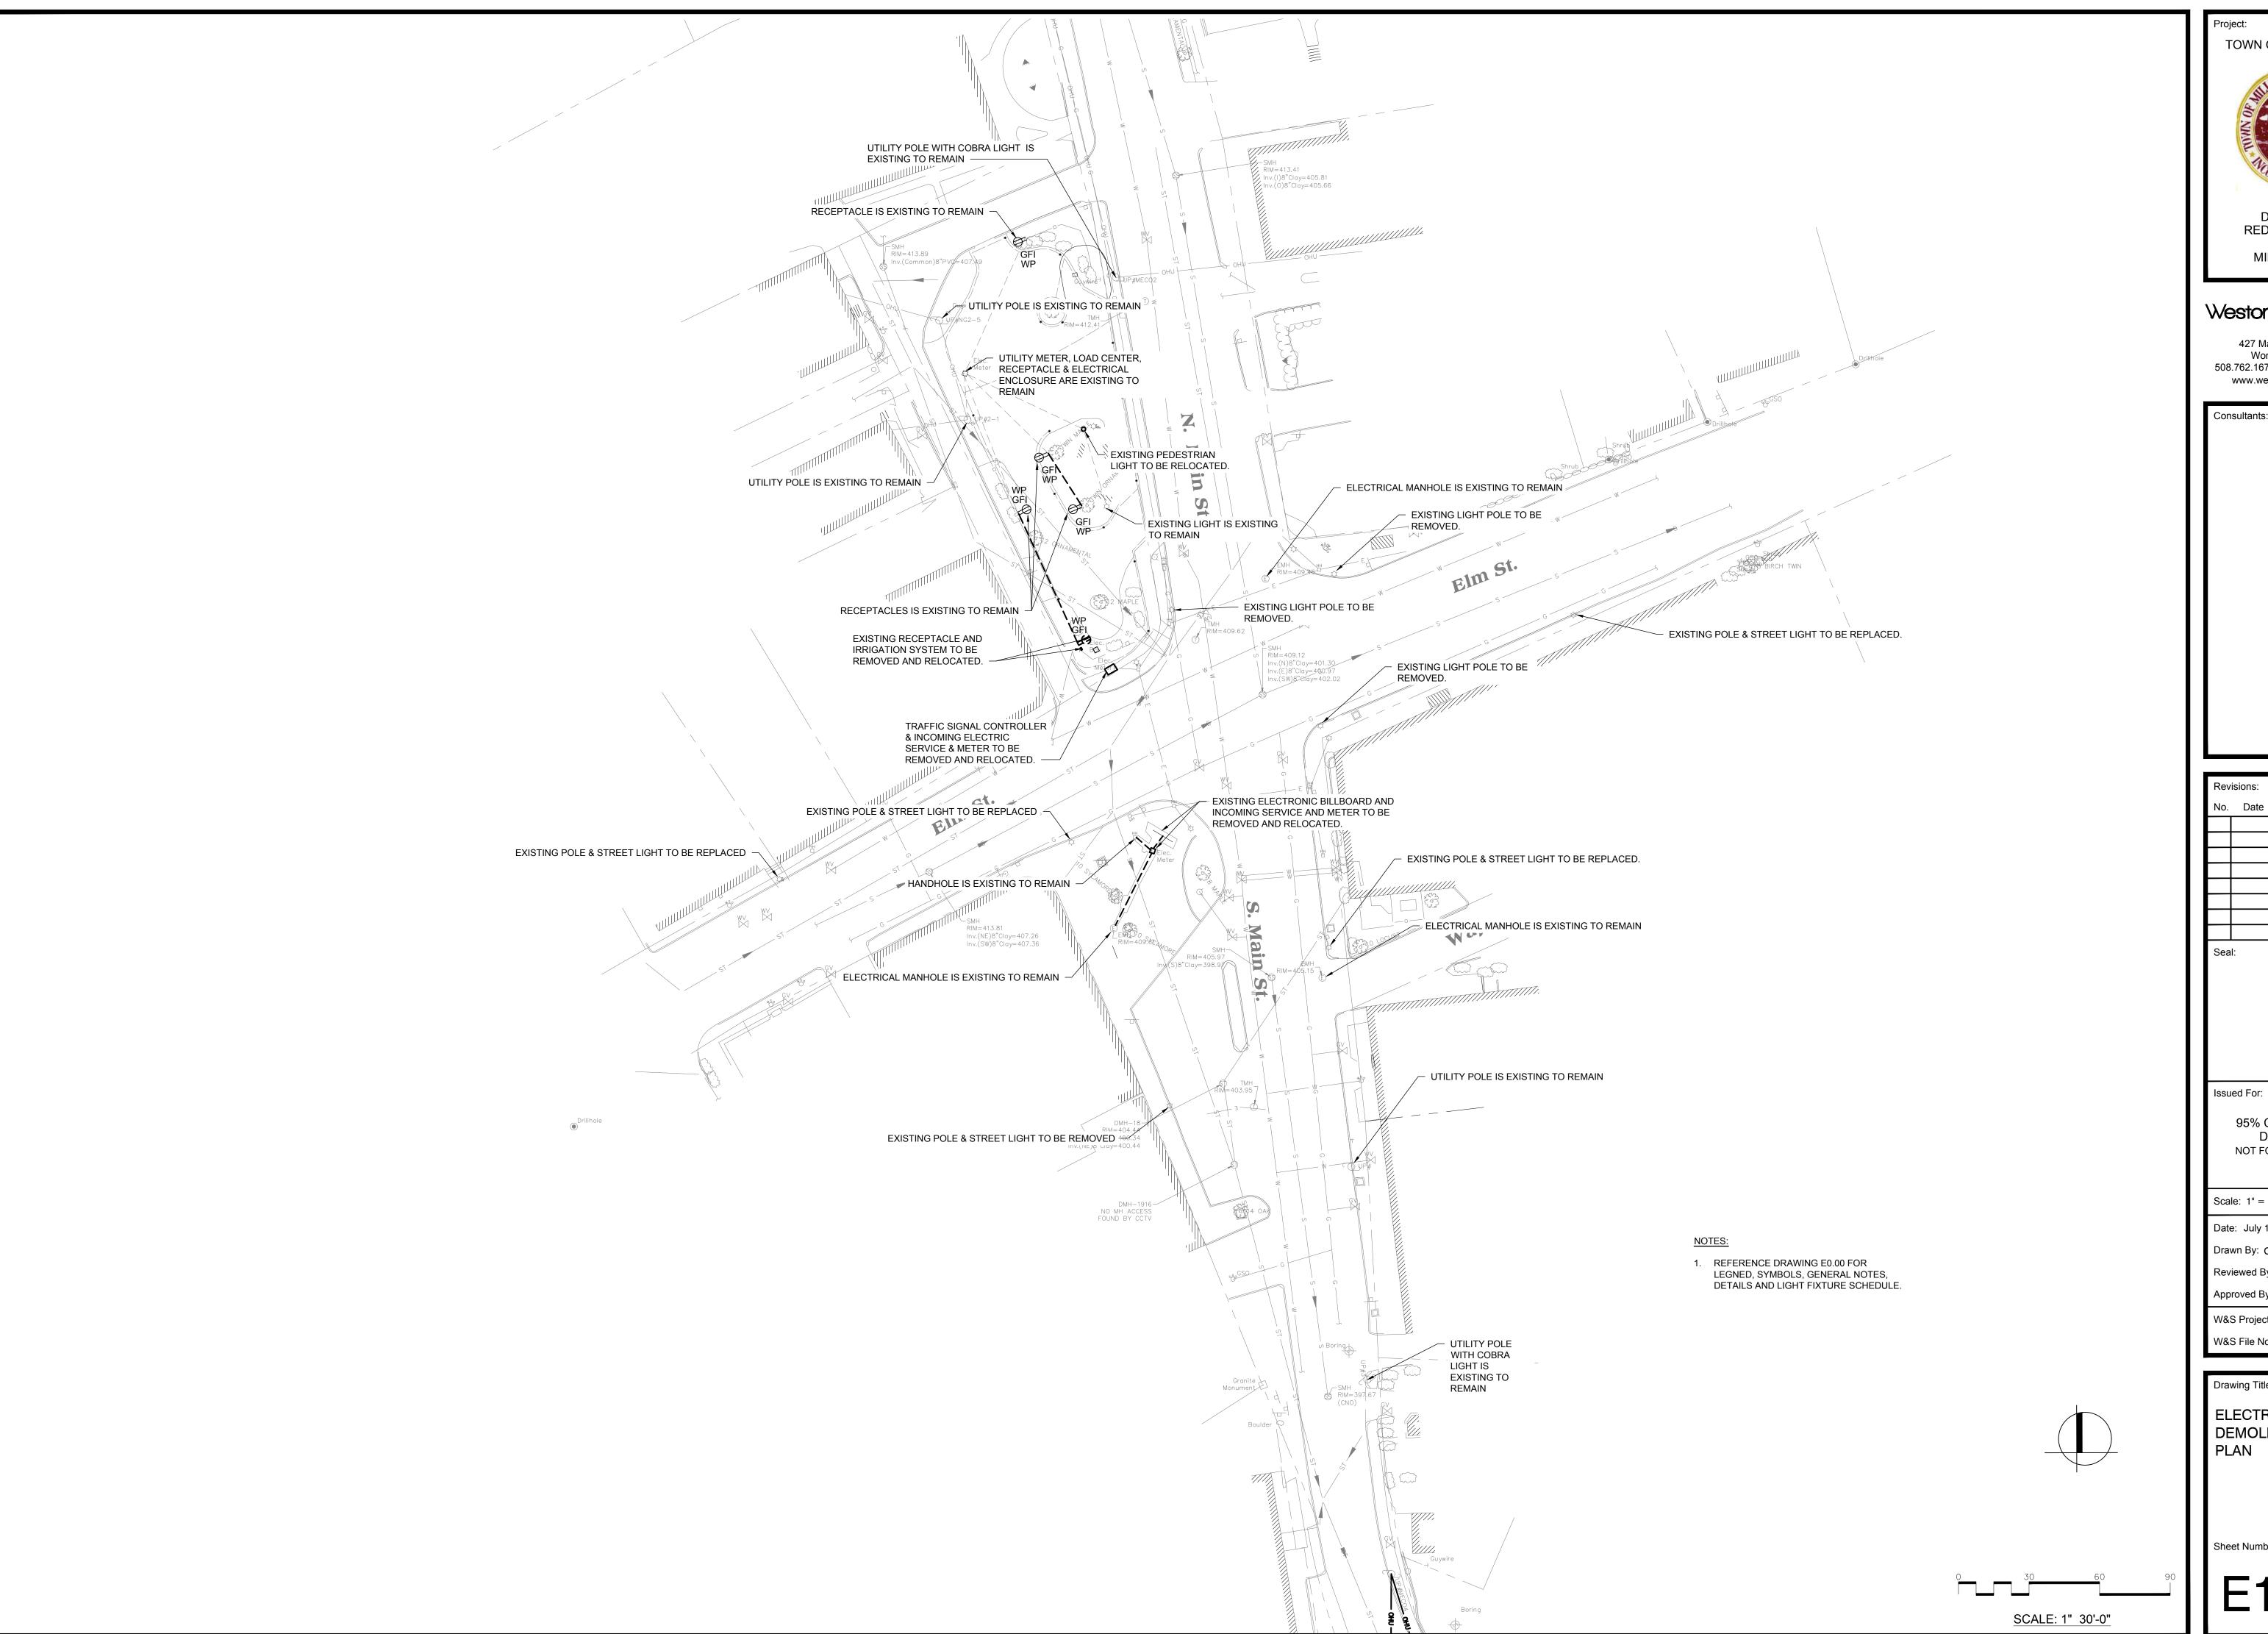
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Drawing Title:

ELECTRICAL SYMBOLS, NOTES & **ABBREVIATIONS** 

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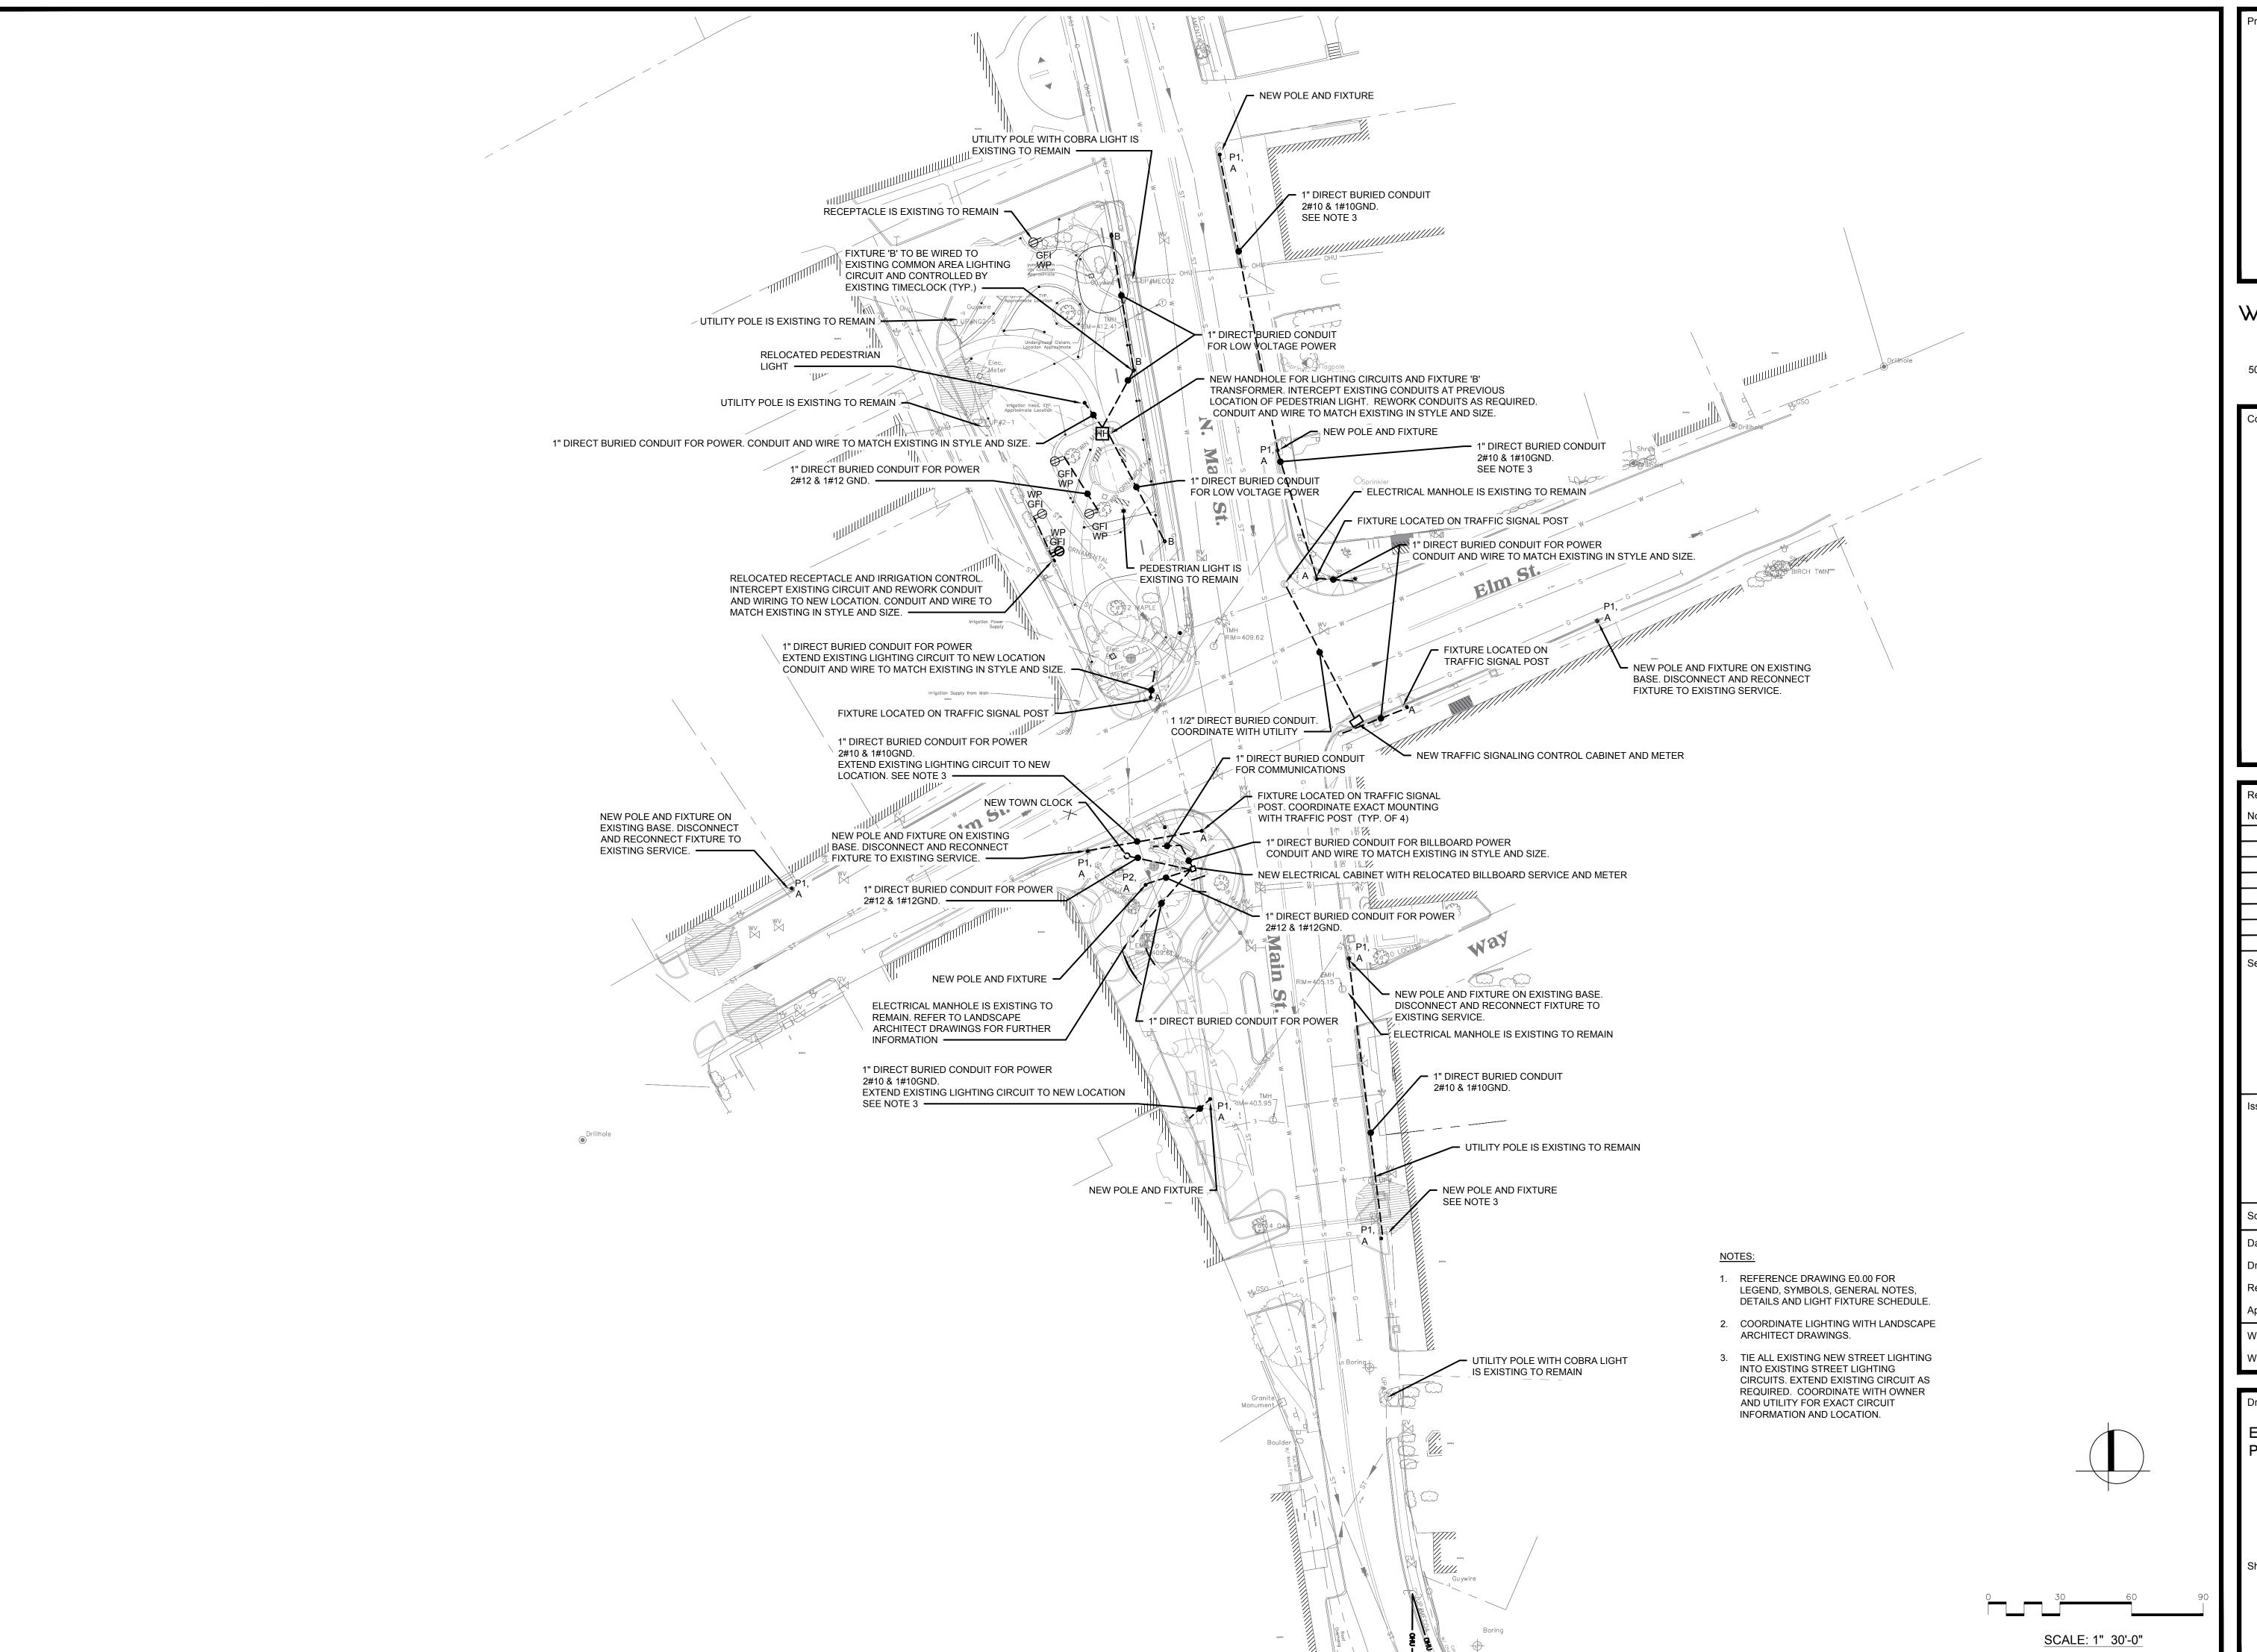
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ELECTRICAL DEMOLITION PLAN



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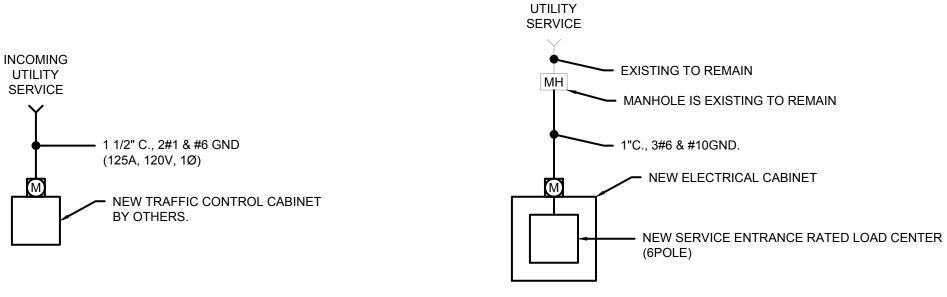
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Drawing Title:

ELECTRICAL SITE PLAN

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TRAFFIC CONTROL CABINET ONE-LINE


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INCOMING

# LOCATION: ELECTRICAL CABINET

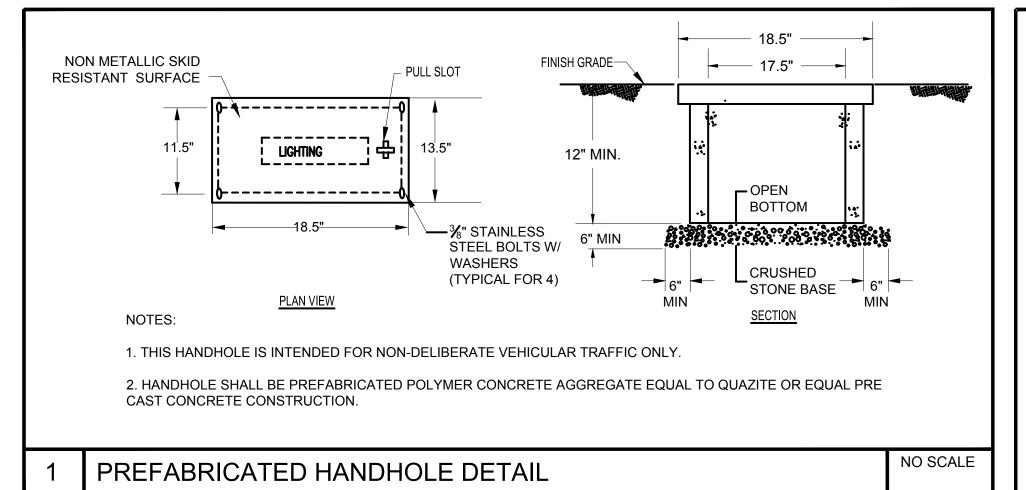	LOAD CENTER							
	SERVICE: 120/240V, 1Ø, 3W, 60Hz 100 AMP MAINS							
	MOUNTING: SURFACE 60 AMP MAIN CIRCUIT BREA							
	CKT #	CIDCUIT DESCRIPTION		AD	BREAKER			
		CIRCUIT DESCRIPTION	KW	HP	POLES	TRIP		
	1	BILLBOARD	Χ	-	1	20		
	2	CLOCK	0.1	-	1	20		
	3	PEDESTRIAN LIGHT	0.1	-	1	20		
	4	SPARE	-	-	1	20		
	5	SPARE	-	-	1	20		
	6	SPARE	-	-	1	20		




€ TRENCH FINISH GRADE & CONDUIT PLASTIC CAUTION TAPE -BY GENERAL CONTRACTOR COMPACTED SUITABLE BACKFILL - BY GENERAL CONTRACTOR SCHEDULE 80 PVC CONDUIT, SIZED AS NOTED ON THE PLAN COMPACTED SUBGRADE OR SUITABLE BACKFILL -BY GENERAL <del>- -- -</del> USE 1 1/2" CRUSHED CONTRACTOR STONE BEDDING IF **----** 1'-4" ----WATER IS **ENCOUNTERED** TYPICAL DIRECT BURIED DUCTBANK DETAIL NO SCALE


	LIGHTING FIXTURE SCHEDULE								
TYPE	TYPE	MANUFACTURER	CATALOG NUMBER	LAI	MP	MOUNTING	VOLTAGE	LOAD	REMARKS
ITPE	LIFE			NO.	TYPE	WOUNTING			REIVIARNS
А	DECORATIVE LED STREET LIGHT, ACORN STYLE	HALOPHANE	GVD2 P50 30K AS M BK 3 R B BK F H AO PCLL	1	LED 10,694 LUMENS 3000K	POLE	120	100W	(8) SUPPLIED BY OWNER. INDIVIDUAL PHOTOCELLS.
В	CONCRETE INCASED LED UPLIGHT	B-K LIGHTING	AW-LED-e65-XX-A9- XX-XX-XX-XX-CPC	1	LED 466 LUMENS 3000K	CONCRETE ENCASED	12	7W	PROVIDE WITH 12VAC BKSSL REMOTE TRANSFORMER MOUNTED IN HAND HOLE.
P1	CHARLSTON ALUMINUM POLE, 18'	HALOPHANE	CHA 18 L5J 16_1 P07 ABG BK BA 30 L45 B 5 BK	N/A	N/A	BASE/ ANCHOR PLATE	N/A	N/A	(8) SUPPLIED BY OWNER.
P2	CHARLSTON ALUMINUM POLE, 10'	HALOPHANE	CHA 10 L5J 16_1 P07 ABG BK	N/A	N/A		N/A	N/A	HEIGHT TO BE DETERMINED BY ARCHITECT

### LIGHTING FIXTURE SCHEDULE REQUIREMENTS

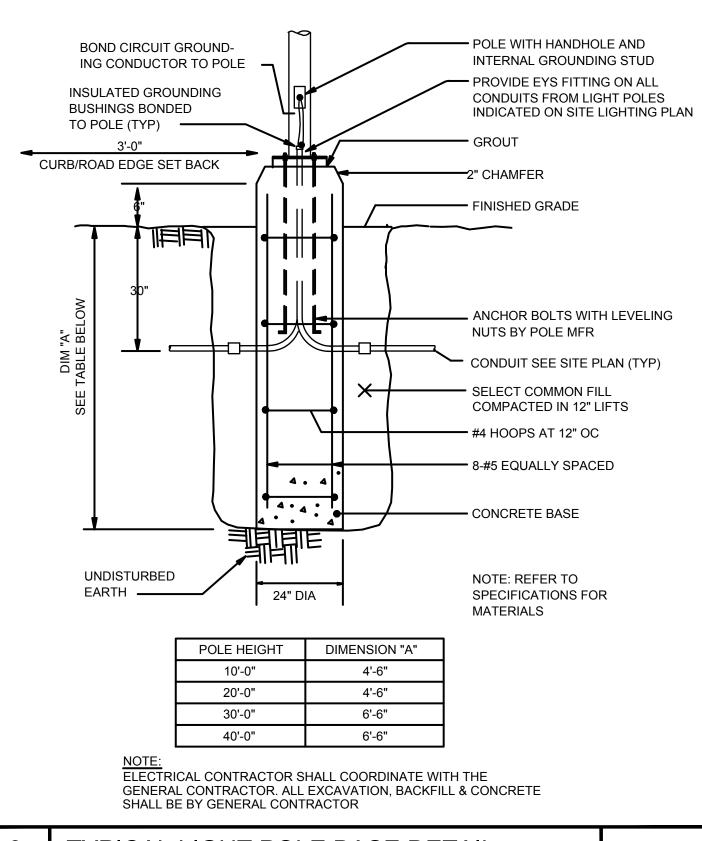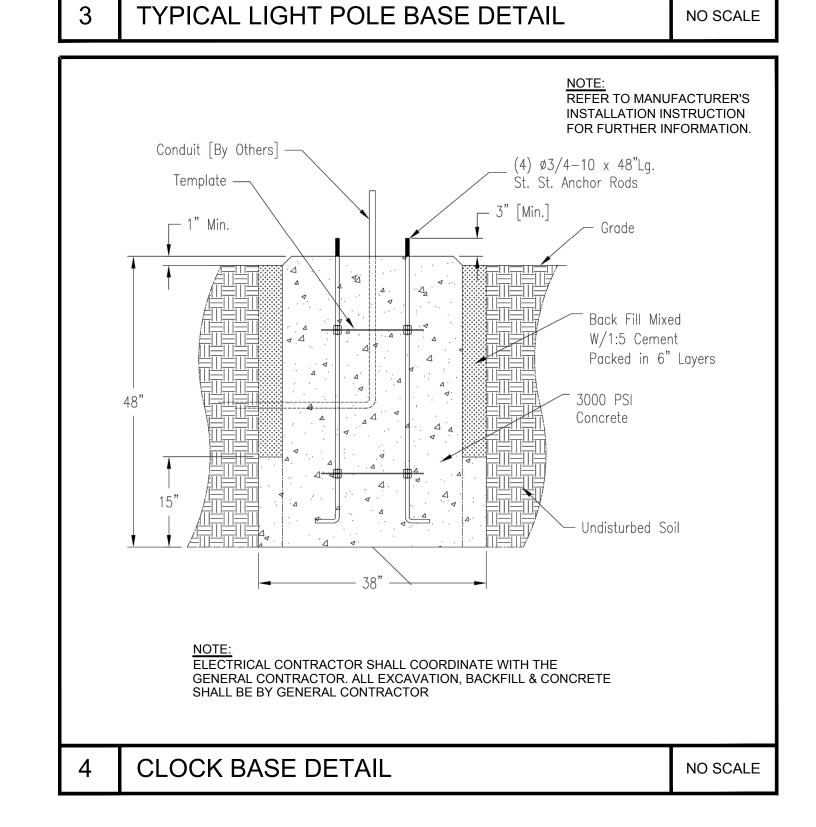EFFICIENT INSTALLATION.

- 1. FURNISH AND INSTALL ALL MATERIALS, ACCESSORIES AND OTHER EQUIPMENT NECESSARY FOR THE COMPLETE AND PROPER INSTALLATION OF ALL LIGHTING FIXTURES INCLUDED IN THIS CONTRACT. PROVIDE ALL NECESSARY ACCESSORIES AS NECESSARY TO PROVIDE A COMPLETE LIGHTING SYSTEM.
- 2. SPECIFICATIONS AND DRAWINGS ARE INTENDED TO CONVEY THE FEATURES, FUNCTION AND CHARACTER OF THE FIXTURES ONLY, AND DO NOT UNDERTAKE TO SPECIFY EVERY ITEM OR DETAIL NECESSARY. MINOR DETAILS NECESSARY FOR THE PROPER EXECUTION AND COMPLETION OF THE LIGHTING SYSTEM NOT INDICATED ON THE DRAWINGS NOR SPECIFIED SHALL BE PROVIDED AS IF THEY WERE SPECIFIED HERE OR INDICATED ON THE DRAWINGS.
- FIXTURES SUBSTITUTIONS (FROM MANUFACTURERS OTHER THAN THOSE LISTED) SHALL BE EQUAL IN ALL RESPECTS OF PERFORMANCE, QUALITY OF CONSTRUCTION, SUITABILITY TO PROJECT CONDITIONS AND APPEARANCE OF THE SPECIFIED FIXTURE. SUBSTITUTIONS SHALL BE SUBMITTED FOR APPROVAL IN THE FORM OF CATALOG CUTS OR DETAIL DRAWINGS. UPON REQUEST SUBMIT SAMPLES OF SUBSTITUTE FIXTURES FOR APPROVAL.
- 4. THE ELECTRICAL CONTRACTOR SHALL COORDINATE THE LIGHTING FIXTURE INSTALLATION WITH THE DRAWINGS AND DETAIL OF THE ARCHITECTURAL, STRUCTURAL AND OTHER RELATED TRADES TO ASSURE AN





Project:

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MILLBURY, MA

427 Main Street, Suite 400, Worcester, MA 01608 508.762.1676 800.SAMPSON www.westonandsampson.com

Consultants:

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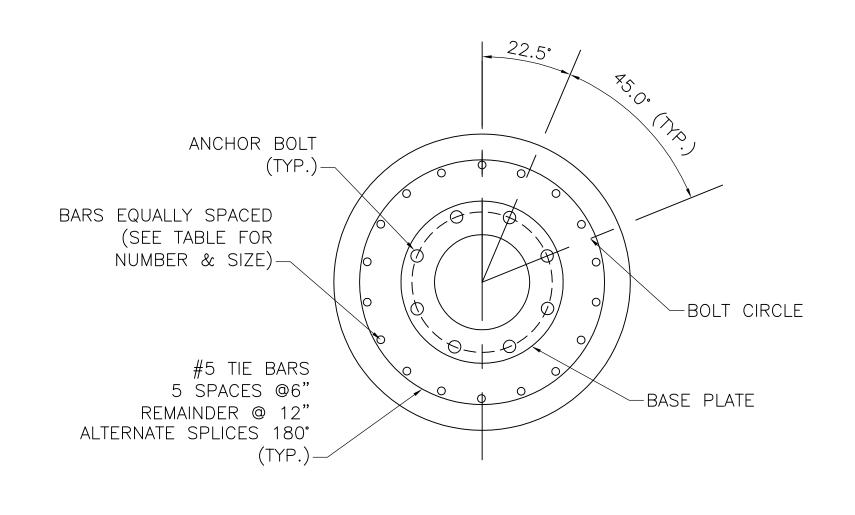
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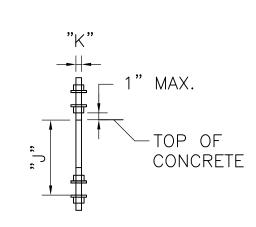
ELECTRICAL DETAILS, SCHEDULES & ONE-LINES

Sheet Number:

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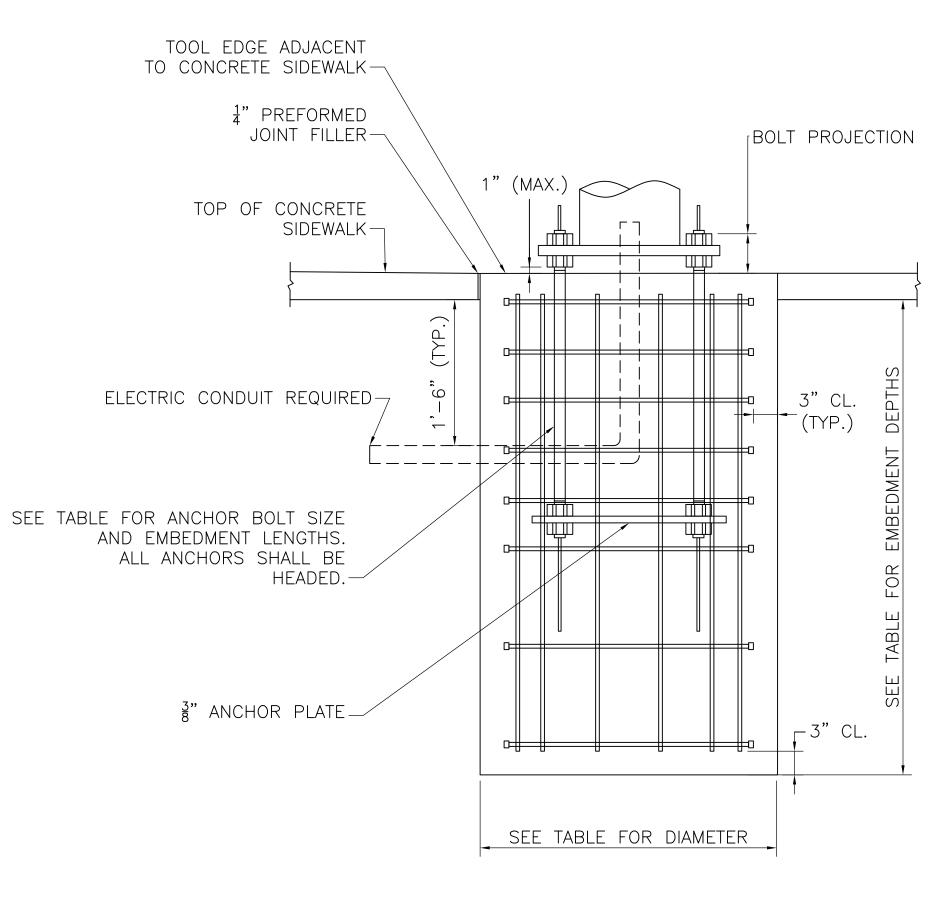


PIER FOUNDATION PLAN N.T.S.



(8) ANCHOR BOLTS WITH (4) HEX NUTS, (4) FLAT WASHERS, AND (1) LOCK-WASHER PER BOLT.

ANCHOR BOLT DETAIL N.T.S.




PIER FOUNDATION DETAIL N.T.S.

POLE AND SIGNAL ARM DATA							
		ANCH	ANCHOR BOLT				
DESIGNATION	PLATE CIRCLE "S"	BOLT CIRCLE "Y"	THK. "M"	HOLE "Z"	DIA. "K"	EMBED LENGTH "J"	
30' - 0" MAST ARM	29.50"	24.00"	1.50"	1.813"	1.50"	36.00"	
40' - 0" MAST ARM	34.50"	28.00"	1.75"	2.063"	1.75"	36.00"	


SIGNAL FOUNDATIONS						
DESIGNATION	ON DIA	AMETER	DEPTH	VERTICAL BARS		
30'-0" MAST A	ARM	4'-0"	12'-0"	18 - #9		
40'-0" MAST A	ARM	4'-6"	13'-0"	18 - #10		
8'-0" TRAFFIC SIGNALS FOUNDATION SIMILAR TO LIGHT POST FOOTING SHOWN ON SECTION 5 SHEET L7.05						

- 1. FOUNDATIONS SHALL BE 4000 PSI,  $1\frac{1}{2}$ ", 565 CEMENT CONCRETE.
- 2. REINFORCEMENT SHALL BE ASTM A615 GRADE 60. 3. ANCHOR BOLTS SHALL BE SET BY TEMPLATE.
- 4. PROVIDE FOR ELECTRICAL CONDUIT.
- 5. EXCAVATION SHALL BE BY THE AUGER METHOD TO THE NEAT LINES OF THE OUTSIDE DIMENSION OF THE FOUNDATIONS WITHOUT DISTURBING THE SOIL AROUND AND BELOW THE BOTTOM. ALTERNATE METHODS OF EXCAVATION MAY BE SUBMITTED TO MASSHIGHWAY FOR APPROVAL IF THEY MEET THE REQUIREMENTS LISTED IN NOTES 6, 7, AND 8. 6. THE EARTH WALLS OF THE FOUNDATION SHALL BE ADEQUATELY AND SECURELY PROTECTED AT ALL TIMES AGAINST CAVE-INS, DISPLACEMENT OF THE SURROUNDING EARTH
- AND FOR EXCLUSION OF GROUND WATER. THIS MAY BE DONE BY THE USE OF STEEL CYLINDER LINERS OR CASINGS THAT ARE APPROVED BY MASSHIGHWAY. IF LINERS ARE USED THEY MAY BE RECLAIMED PROVIDED THAT THEY ARE WITHDRAWN AS THE CONCRETE IS BEING PLACED, MAINTAINING A SUFFICIENT HEAD OF CONCRETE WITHIN THE LINER TO PREVENT REDUCTION IN THE FOUNDATION DIAMETER AND TO PREVENT EXTRANEOUS MATERIAL FROM FALLING IN FROM THE SIDE AND MIXING WITH THE CONCRETE. 7. IF THE SOIL IS DISTURBED OR REMOVED BEYOND THE NEAT LINES OF THE OUTSIDE DIMENSION OF THE FOUNDATION, IT SHALL BE REPLACED WITH CONCRETE. ANY
- ADDITIONAL COST FOR THE CONCRETE SHALL BE PAID FOR BY THE CONTRACTOR. 8. SPECIAL CARE SHOULD BE GIVEN TO AREAS WHERE WET SOIL IS ENCOUNTERED, TO INSURE THAT THE PREAUGERED HOLE DOES NOT COLLAPSE. THIS MAY REQUIRE THE USE OF STEEL CYLINDER LINERS OR CASINGS TO HOLD THE SOIL IN PLACE UNTIL READY FOR CONCRETE PLACEMENT. THE STEEL CYLINDERS OR CASINGS SHALL BE WITHDRAWN
- AS THE FOUNDATION CONCRETE IS PLACED. 9. CONTRACTORS SHALL CONTACT ENGINEER IN THE EVENT ROCK IS ENCOUNTERED AND ADDITIONAL DIRECTION SHALL BE PROVIDED.

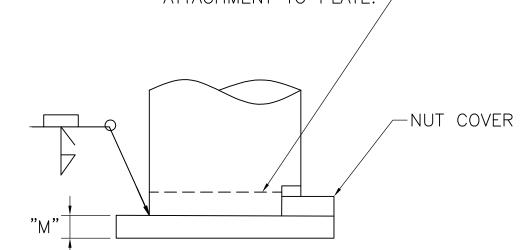
2" BACKING RING ATTACHED TO PLATE WILL FULL PENETRATION WELD, OR WITH A CONTINUOUS FILLET WELD AROUND INTERIOR FACE OF BACKING RING. THE THICKNESS OF THE BACKING RING SHALL NOT EXCEED 3" WITH FILLET WELD ATTACHMENT TO PLATE.



POLE BASE ELEVATION N.T.S.

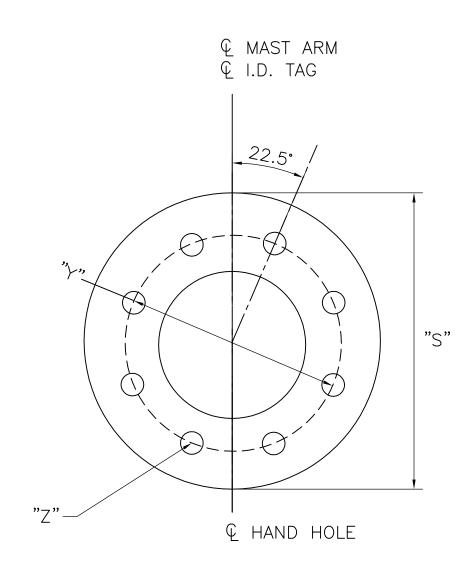

POLE BASE PARTIAL PLAN N.T.S.

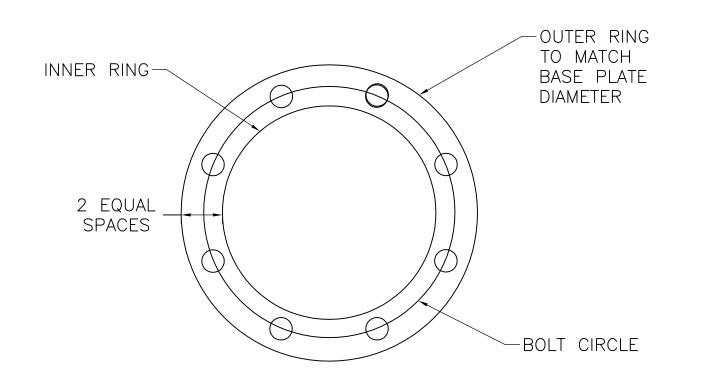

ANCHOR BOLT DETAIL N.T.S.


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427 Main Street, Suite 400, Worcester, MA 01608 508.762.1676 800.SAMPSON www.westonandsampson.com



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Approved By: SRB
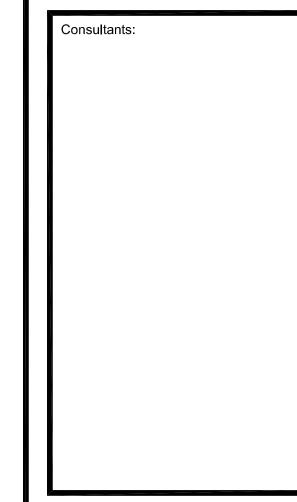
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